

Planning/Zoning Application

Receipt # 188943

Submitted On:

Jan 18, 2024, 02:09PM EST

Planning & Zoning Department

JAN 2 2 PAID Parcel Number: (Include ALL WD-84-3 parcels) Nearest property address to the Street Address: 801 Main Avenue City: De Pere project site: State: W **Zip:** 54115 Check each project type that is Site Plan being applied for: **Current De Pere Zoning** MX3 Districts: **Existing Site Land Uses:** Commercial **Proposed Site Land Uses:** Commercial Does the project comply with Yes the Comprehensive Plan? Has City Staff been contacted Yes for a pre-consultation meeting? First Name: Caleb **Property Owner:** Last Name: Hayes Is the property owner's address the same as the nearest No property address? Street Address: 1674 Eisenhower Road **Property Owner's Address:** City: De Pere State: W **Zip:** 54115 **Property Owner's Phone** 920-309-1037 Number: **Property Owner's Email** caleb@calebhayes.com Address: Is someone processing the project for the property owner Yes as their authorized representative? Authorized Representative's First Name: Brandon Name: Last Name: Robaidek **Authorized Representative's** Robert E. Lee and Associates, Inc. **Business Name:**

Authorized Representative's 920-662-9641 **Phone Number: Authorized Representative's** brobaidek@releeinc.com **Email Address:** Please attach a PDF copy of the 6137005 CARIBOU 24X36 2024-01-18.pdf site plan. Would you like a basic checklist of information to include in the Yes site plan? How do you plan on paying for Online with a credit card your application? **Total Due:** \$350.00 First Name: Brandon Signature Data

Last Name: Robaidek

Email Address: brobaidek@releeinc.com

Brandon Robaidek

Signed at: January 18, 2024 2:08pm America/New_York

User's Session Information

IP Address: 24.106.22.82

Referrer URL:

CITY OF DE PERE

335 South Broadway, De Pere, WI 54115 | www.de-pere.org



Brandon Robaidek Robert E. Lee and Associates, INC 1250 Centennial Centre BL Hobart, WI 54155

Site Plan Review for the New Caribou Coffee at 803 Main AV RE:

Parcel WD-364-D-506

Dear Brandon:

Thank you for the site plan for the New Caribou Coffee at 803 Main AV. The City of De Pere staff reviewed the site plan on March 7, 2024, and recommended approval, with the following four conditions that must be addressed prior to submitting a request for occupancy permits:

- After landscaping is installed, provide a statement from the landscaper that verifies that all landscaping has been installed according to the approved landscaping plan to minimize delays or violations related to this topic.
- After the exterior lighting is installed, provide a statement from the installer that the light spill from the property does not exceed the approved photometric plan.
- Submit detailed plans of the building layout including kitchen equipment & finish schedules.
- Check if there is a model or traffic study that forecasts generated traffic for a typical Caribou Coffee. Public Works is looking for additional traffic information for the reconstruction of the Main AV and Eighth ST intersection by WisDOT in 2028.

You may now proceed to the Inspection Division to begin the process of obtaining permits. Should you have any questions regarding the decision or require further information, feel free to contact me at 339-4043 or pschleinz@deperewi.gov.

Sincerely,

Peter Schleinz

Senior Planner | Zoning Administrator


Futer Schlery

Daniel J. Lindstrom, AICP, Development Services Director cc: Dennis Jensen, Senior Building Inspector

CARIBOU COFFEE DEVELOPMENT FOR PARK PLACE HOLDINGS, LLC. - 801 MAIN AVE. CITY OF DE PERE, BROWN COUNTY, WISCONSIN

TTENTION!

OWNLOADED PLANS ARE NOT SCALEABLE, NEITHER THE OWNER OR THE ENGINEER SHALL BE HELD RESPONSIBLE FOR THE SCALE OR PRINT QUALITY OF DOWNLOADED PLANS. ONLY PRINTED PLANS FROM BLUE PRINT SERVICE CO., INC. SHALL BE CONSIDERED TO BE SCALEABLE PLANS.

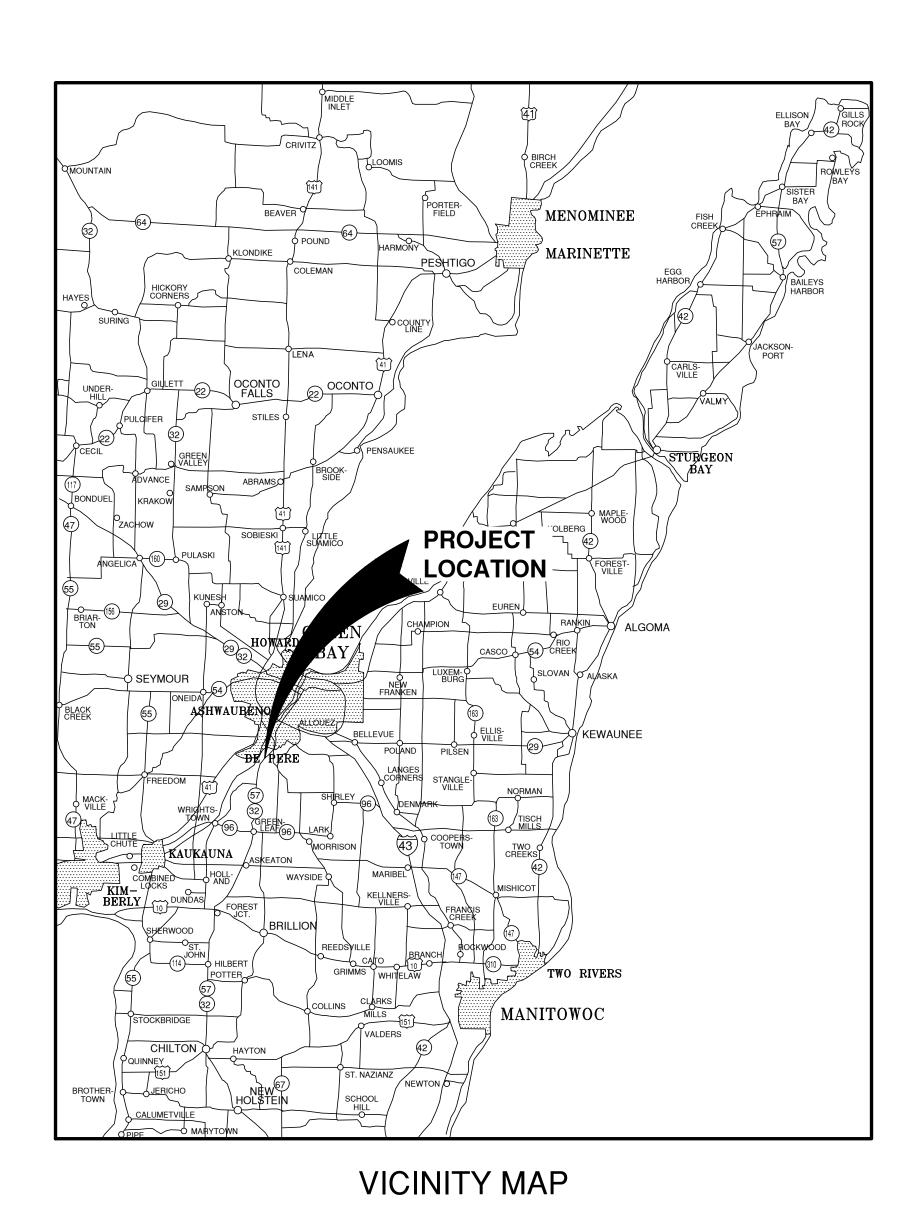


NOTE:
EXISTING UTILITIES SHOWN ON PLANS ARE APPROXIMATE. THE CONTRACTOR SHALL BE
RESPONSIBLE FOR OBTAINING EXACT LOCATIONS AND ELEVATIONS OF ALL UTILITIES,
WHETHER SHOWN OR NOT, FROM THE OWNERS OF THE RESPECTIVE UTILITIES. ALL UTILITY
OWNERS SHALL BE NOTIFIED FOR LOCATES BY THE CONTRACTOR 72 HOURS PRIOR TO
EXCAVATION.

NOTE:
ALL EROSION CONTROL MEASURES SHALL
BE IN PLACE PRIOR TO CONSTRUCTION
AND SHALL CONFORM TO THE WISCONSIN
DEPARTMENT OF NATURAL RESOURCES
CONSTRUCTION SITE EROSION CONTROL
AND TECHNICAL STANDARDS.

INDEX TO DRAWINGS

SHT. NO.	DESCRIPTION
С	LOCATION MAPS AND INDEX TO DRAWINGS
1	GENERAL NOTES
2	EXISTING CONDITIONS AND DEMO PLAN
3	OVERALL SITE PLAN
4	SITE AND UTILITY PLAN
5	GRADING AND EROSION CONTROL PLAN
6	MISCELLANEOUS DETAILS
7	MISCELLANEOUS DETAILS
8	EROSION CONTROL - INLET PROTECTION TYPES A, B, C AND D
9	EROSION CONTROL - INLET PROTECTION TYPE D-HR AND TYPE D-I
10	EROSION CONTROL - SHEET FLOW DETAILS
11	EROSION CONTROL - TRACKOUT CONTROL PRACTICES
L1	LANDSCAPE PLAN
L2	LANDSCAPE DETAIL
L3	LIGHTING PLAN

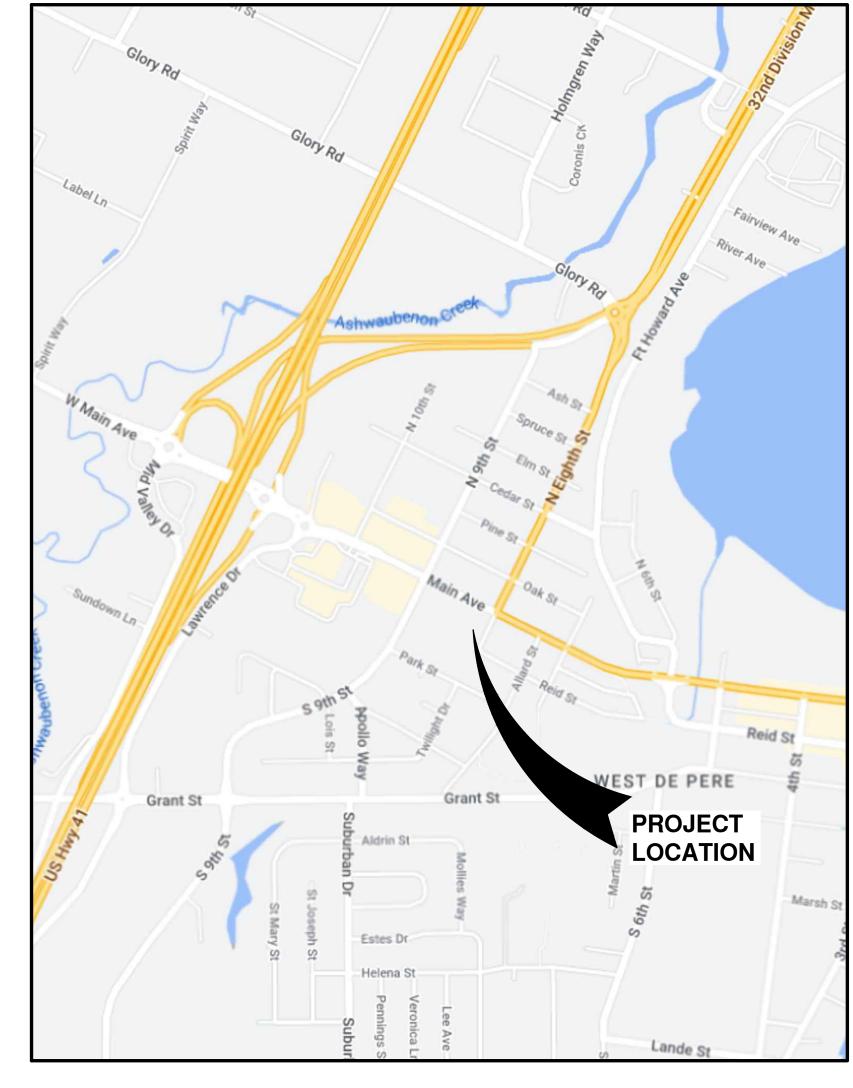

LOCATION MAP

NO.	DATE	APPROV.	REVISION	NO.	DATE	APPROV.	REVISION	DRAWN BDR
1	1/18/24	BDR	CITY SUBMITTAL					CHECKED
								DESIGNED
								BDR
-		-				-		•

CARIBOU COFFEE DEVELOPMENT FOR PARK PLACE HOLDINGS, LLC. - 801 MAIN AVE. CITY OF DE PERE BROWN COUNTY, WISCONSIN

LOCATION MAPS AND INDEX TO DRAWINGS

DATE 07/2023 FILE 6137005C JOB NO. 6137005



CITY OF DE PERE STORM, SANITARY, AND WATER, EVERSTREAM TELECOMMUNICATIONS, AT&T TELECOMMUNICATIONS, TDS TELECOMMUNICATIONS, TIME WARNER CABLE TELECOMMUNICATIONS, LEVEL 3 NOW LUMEN, NOW CENTURY LINK TELECOMMUNICATIONS, AND WPS GAS AND ELECTRIC.

UTILITIES SHOWN ON THIS MAP ARE BASED ON LOCATES FROM:

DIGGER'S HOTLINE TICKET NUMBER 20232409346 6/23/2023, VISIBLE OBSERVATION (7/11/2023) AND RECORD UTILITY PLAN DOCUMENTS. UTILITY LINE LOCATIONS SHOULD BE VERIFIED PRIOR TO ANY DIGGING. THIS SITE MAY CONTAIN BURIED UTILITIES NOT IDENTIFIED ON THIS MAP.

DIGGERS HOTLINE = 1-800-242-8511

WATER/SANITARY/STORM SEWER: TELECOMMUNICATIONS: DEPARTMENT OF PUBLIC WORKS EVERSTREAM CITY OF DE PERE 925 SIXTH ST. DE PERE, WI 54155

1228 EUCLID AVENUE CLEVELAND, OH 44115

(844) 387-7876

TELECOMMUNICATIONS: AT & T / SBC 205 S. JEFFERSON ST. GREEN BAY, WI 54301

TELECOMMUNICATIONS:

TDS METROCOM / TDS TELECOM TIME WARNER CABLE 2580 W. MASON ST. GREEN BAY, WI 54303

(920) 944-1581

TELECOMMUNICATIONS: GAS & ELECTRIC: WISCONSIN PUBLIC SERVICE CORP. 700 N. ADAMS ST. GREEN BAY, WI 54307

(920) 433-4147

(800) 797-7434

(920)884-3340

1029 W. MASON ST.

GREEN BAY, WI 54303

(920) 339-8076

www.DiggersHotline.com

TO OBTAIN LOCATION OF PARTICIPANTS UNDERGROUND FACILITIES BEFORE YOU DIG IN WISCONSIN

WIS. STATUTE 182.0175 (1974) REQUIRES MIN. OF 3 WORK DAYS NOTICE BEFORE YOU EXCAVATE.

LEGEND

BOLLARD

- FIRE HYDRANT POWER POLE P— POWER POLE W/GUY WIRE ⊗ WATER VALVE/CURB STOP W WATER MANHOLE ∇ REDUCER/INCREASER TRAFFIC SIGNAL POLE SANITARY MANHOLE **E** ELECTRIC MANHOLE

 AIR RELIEF MANHOLE ELECTRIC METER STORM MANHOLE TELEPHONE MANHOLE OPEN STORM MANHOLE TELEPHONE PEDESTAL STORM INLET

STORM INLET MANHOLE □ CABLE TV PEDESTAL TANK COVER © GAS VALVE \bigoplus_{SP} SOIL BORING G GAS METER ■ POST MAILBOX IRON PIPE/ROD ∮ SIGN

DECIDUOUS TREE **CONIFEROUS TREE** BUSH

RIP RAP

WETLANDS

==== CULVERT

HANDICAP PARKING

		– 8SS ––––	8SS ———	SANITARY SEWER (SIZE NOTED)
ED	GE OF ASPHALT	— 4FM ————	4FM	FORCEMAIN (SIZE NOTED)
		-10ST	10ST	STORM SEWER (SIZE NOTED)
ED	GE OF GRAVEL 6	W 6W	6W	WATERMAIN (SIZE NOTED)
		G	G —	GAS LINE
CU	IRB & GUTTER	— OT-	OT —	OVERHEAD TELEPHONE LINE
		T	Т —	UNDERGROUND TELEPHONE LINE
TR	EE/BRUSH LINE	— OE	OE	OVERHEAD ELECTRIC LINE
		— Е ———	E ———	UNDERGROUND ELECTRIC LINE
CO	NTOUR LINE	OTV —	OTV —	OVERHEAD CABLE TV LINE
		TV	TV	CABLE TV LINE
	TAINING WALL	— FO———	F0	FIBER OPTIC LINE
				R/W LINE
	IARD RAIL			PROPERTY LINE
		· · · ·		EASEMENT LINE
-X X X FE	NCE — —			BUILDING SETBACK LINE
	 -			SECTION LINE

GR.	GRAVEL	WM	WATERMAIN	VPC	VERTICAL POINT
BIT.	BITUMINOUS	HYD.	HYDRANT	VPI	VERTICAL POINT
ASPH	ASPHALT	WV	WATER VALVE	VPT	VERTICAL POINT
CONC	CONCRETE	SAN	SANITARY SEWER	PC	POINT OF CURVA
SW	SIDEWALK	MH	MANHOLE	PI	POINT OF INTERS
BLDG	BUILDING	ST	STORM SEWER	PT	POINT OF TANGE
HSE	HOUSE	CB	CATCH BASIN	R	RADIUS
PED	PEDESTAL	TELE	TELEPHONE	EX	EXISTING
PP	POWER POLE	ELEC	ELECTRIC	PR	PROPOSED
LP	LIGHT POLE	TV	TELEVISION	EOR	END OF RADIUS

STA. STATION

Γ OF TANGENCY /ATURE SENCY

BOC BACK OF CURB

FOF CURVATURE B-B BACK TO BACK (OF CURB) T OF INTERSECTION F-F FACE TO FACE (OF CURB) R/W RIGHT OF WAY T/C TOP OF CURB F/L FLOW LINE C/L CENTERLINE R/L REFERENCE LINE INV INVERT CMP CORRUGATED METAL PIPE

> RCP REINFORCED CONCRETE PIPE CULV CULVERT

OWNER INFORMATION:

△ PK NAIL


PARK PLACE HOLDINGS, LLC 1674 EISENHOWER ROAD DE PERE, WI 54115

BENCH MARK


(920) 309-1037


CONTACT: CALEB HAYES




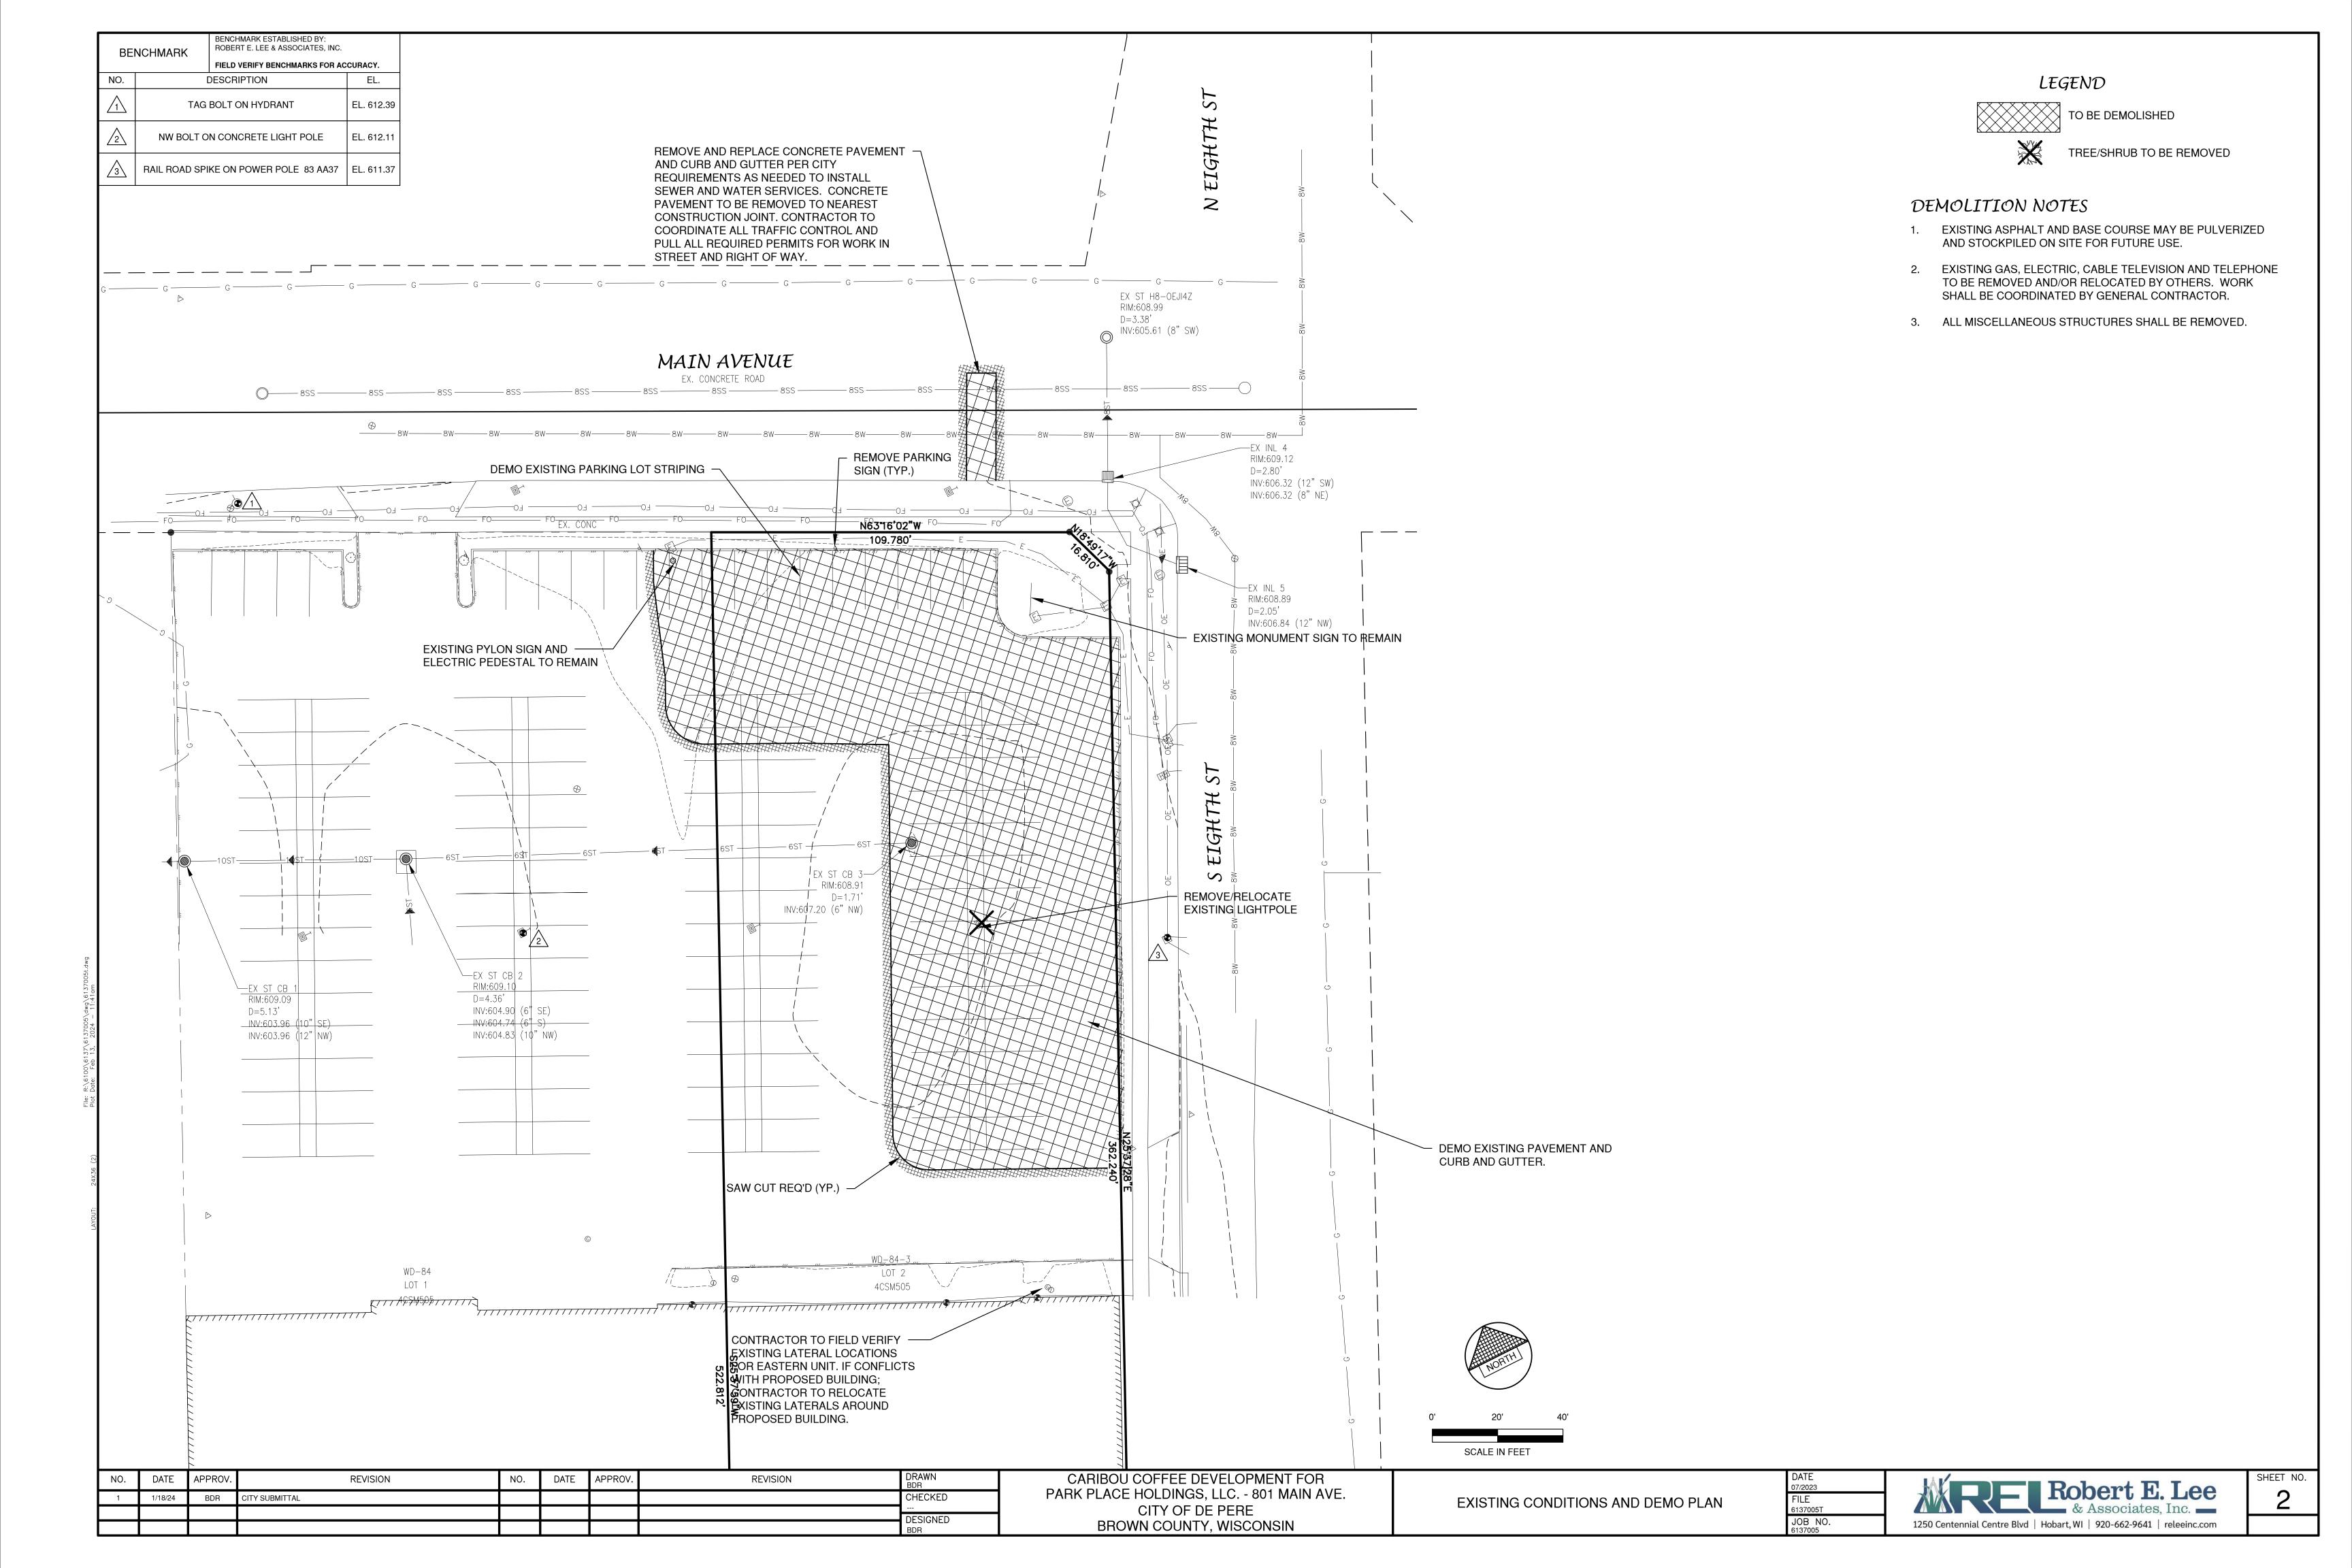


801-815 Main Ave, De Pere	801	Women's Care of Wisconsin, S.C. (medical office)	3,300 SF	8.25+6 for employee
801-815 Main Ave, De Pere	805	The Game Capital (retail)	10,800 SF	27
801-815 Main Ave, De Pere	807	Papa Johns Pizza (retail)	2,000 SF	5
801-815 Main Ave, De Pere	809	Holly Shepard (medical clinic)	2,000 SF	5+ 1 for employee
801-815 Main Ave, De Pere	811	Anytime Fitness (Retail)	5,000 SF	12.5
801-815 Main Ave, De Pere	813	The Wine Cellar (retail)	6,400 SF	16
801-815 Main Ave, De Pere	815	KK Sew & Vac (Retail)	2,560 SF	6.4
801-815 Main Ave, De Pere	120 S 8th	X Factor Elite Gym (Gym/retail)	9,000 SF	22.5
801-815 Main Ave, De Pere	Proposed	Caribou Coffee	583 SF	5 Guest stalls, 5 employee stalls, 2 Order Ahead Stalls
			Total	124

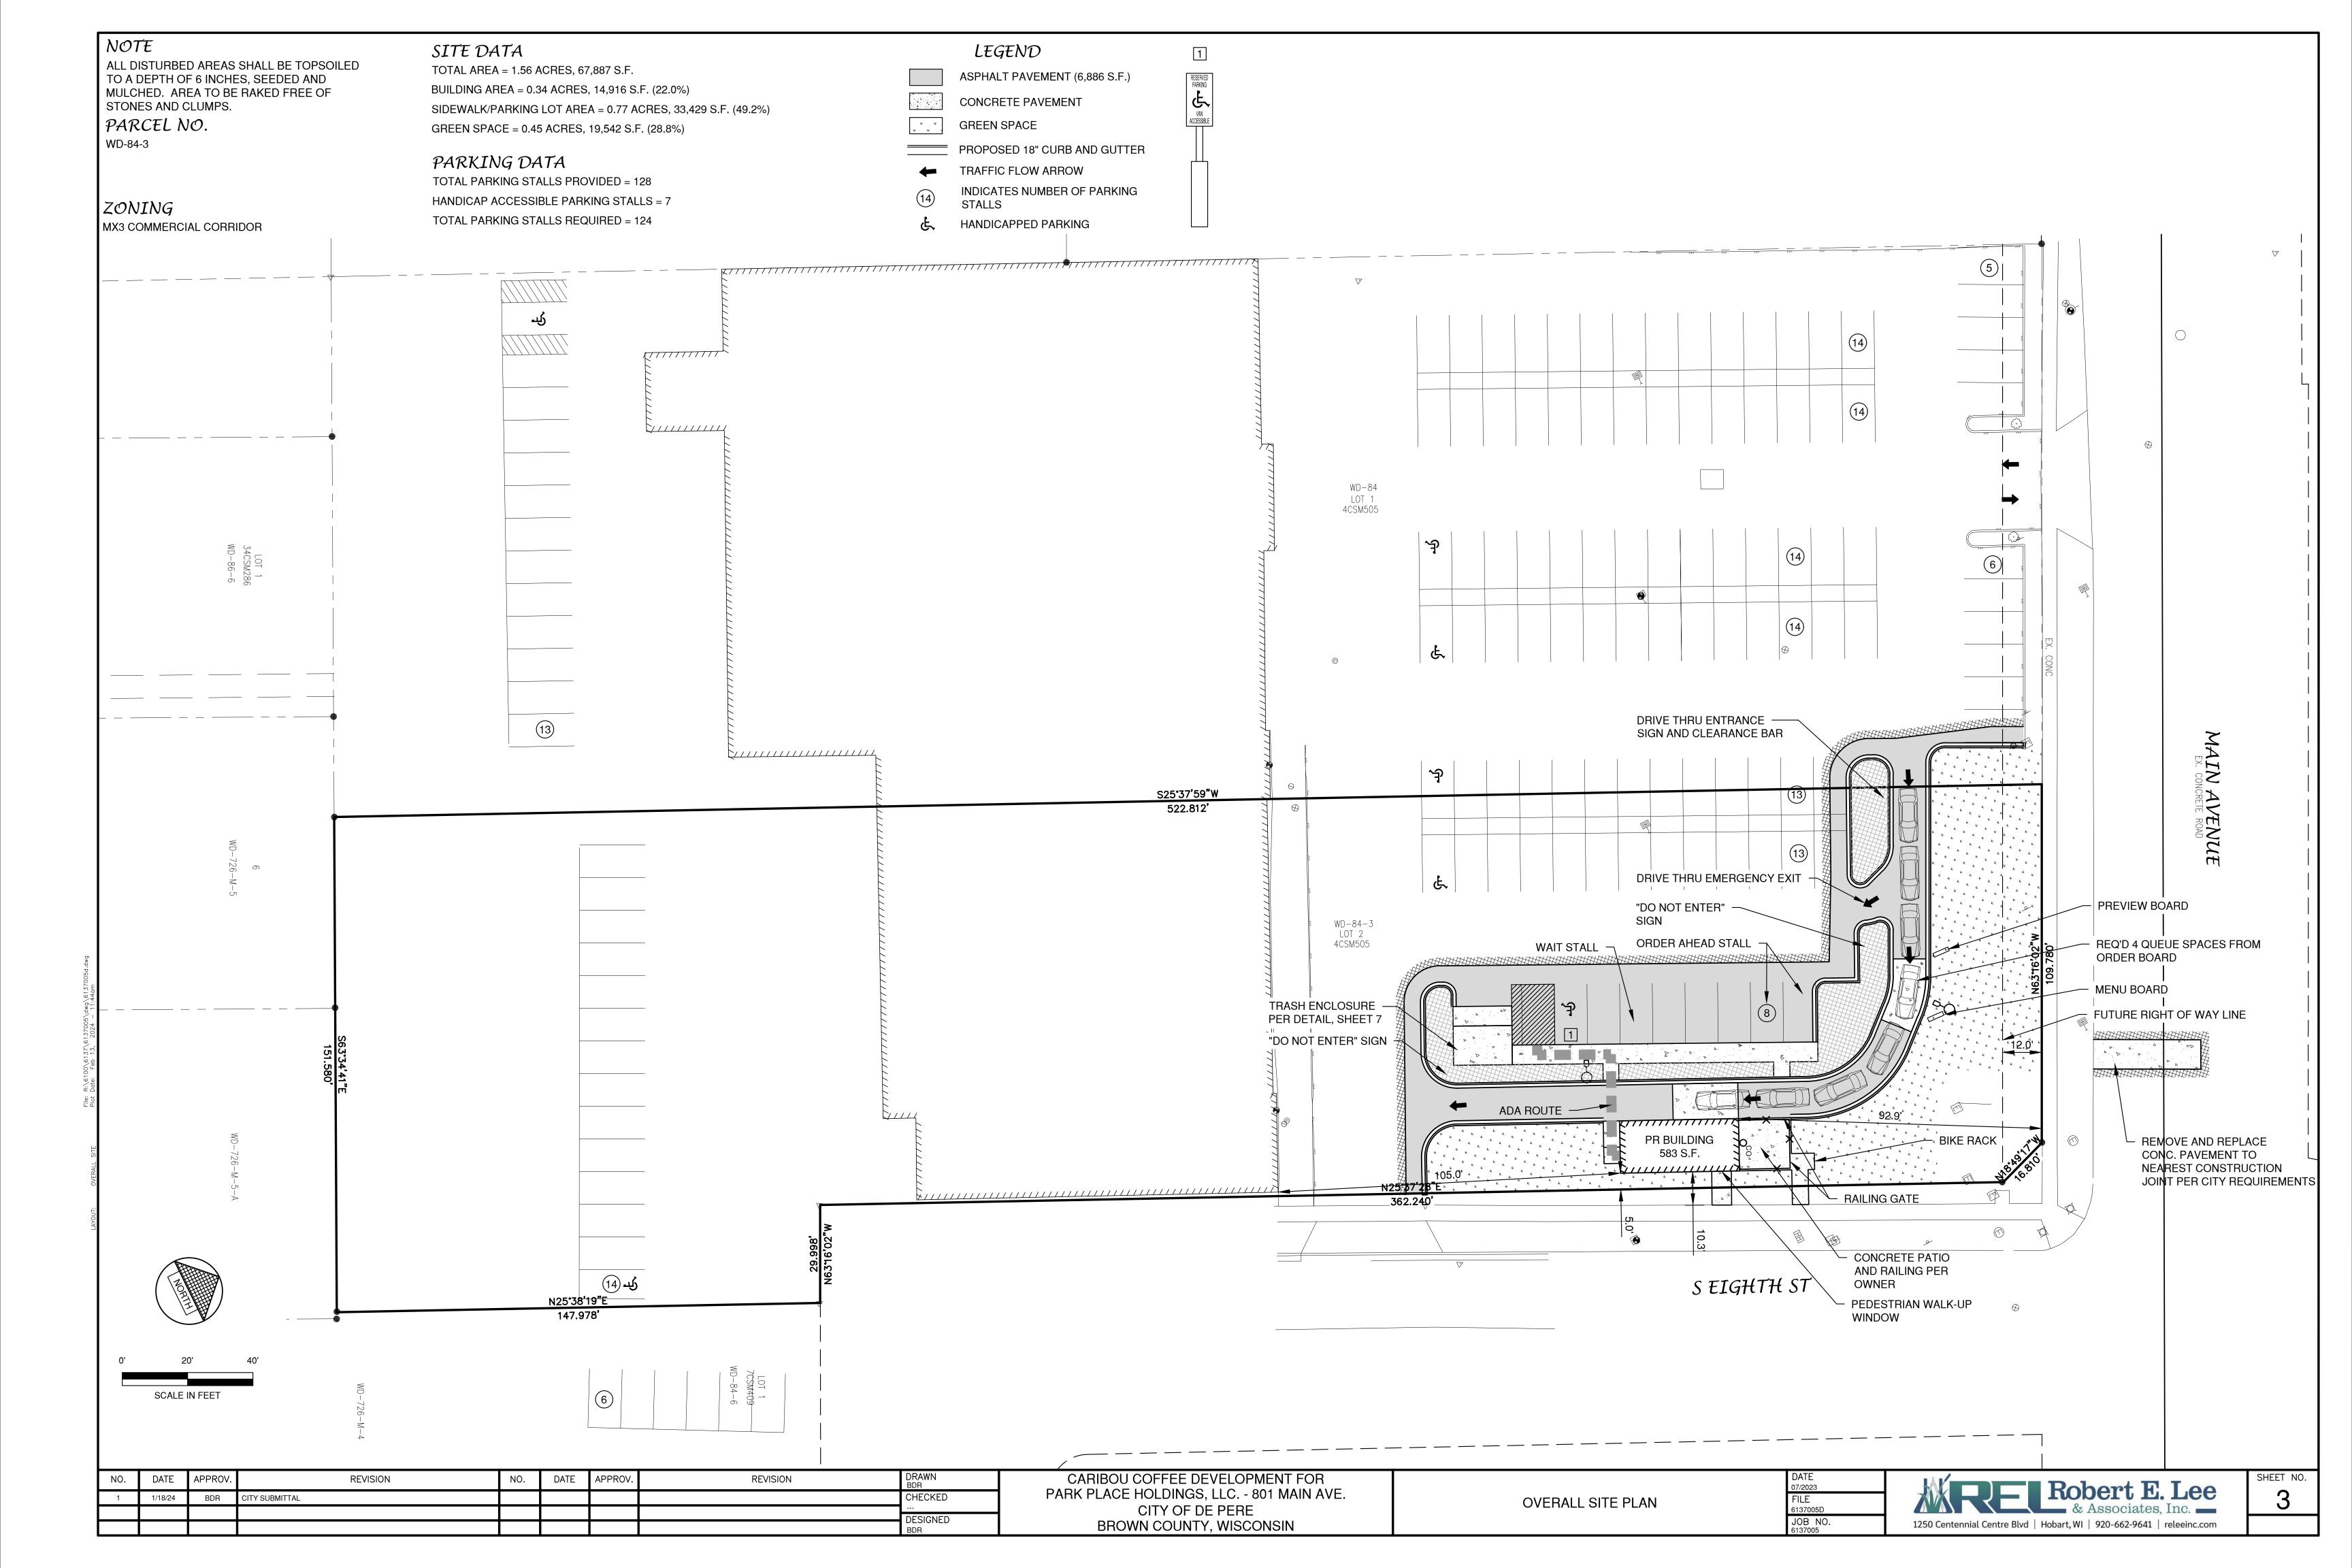

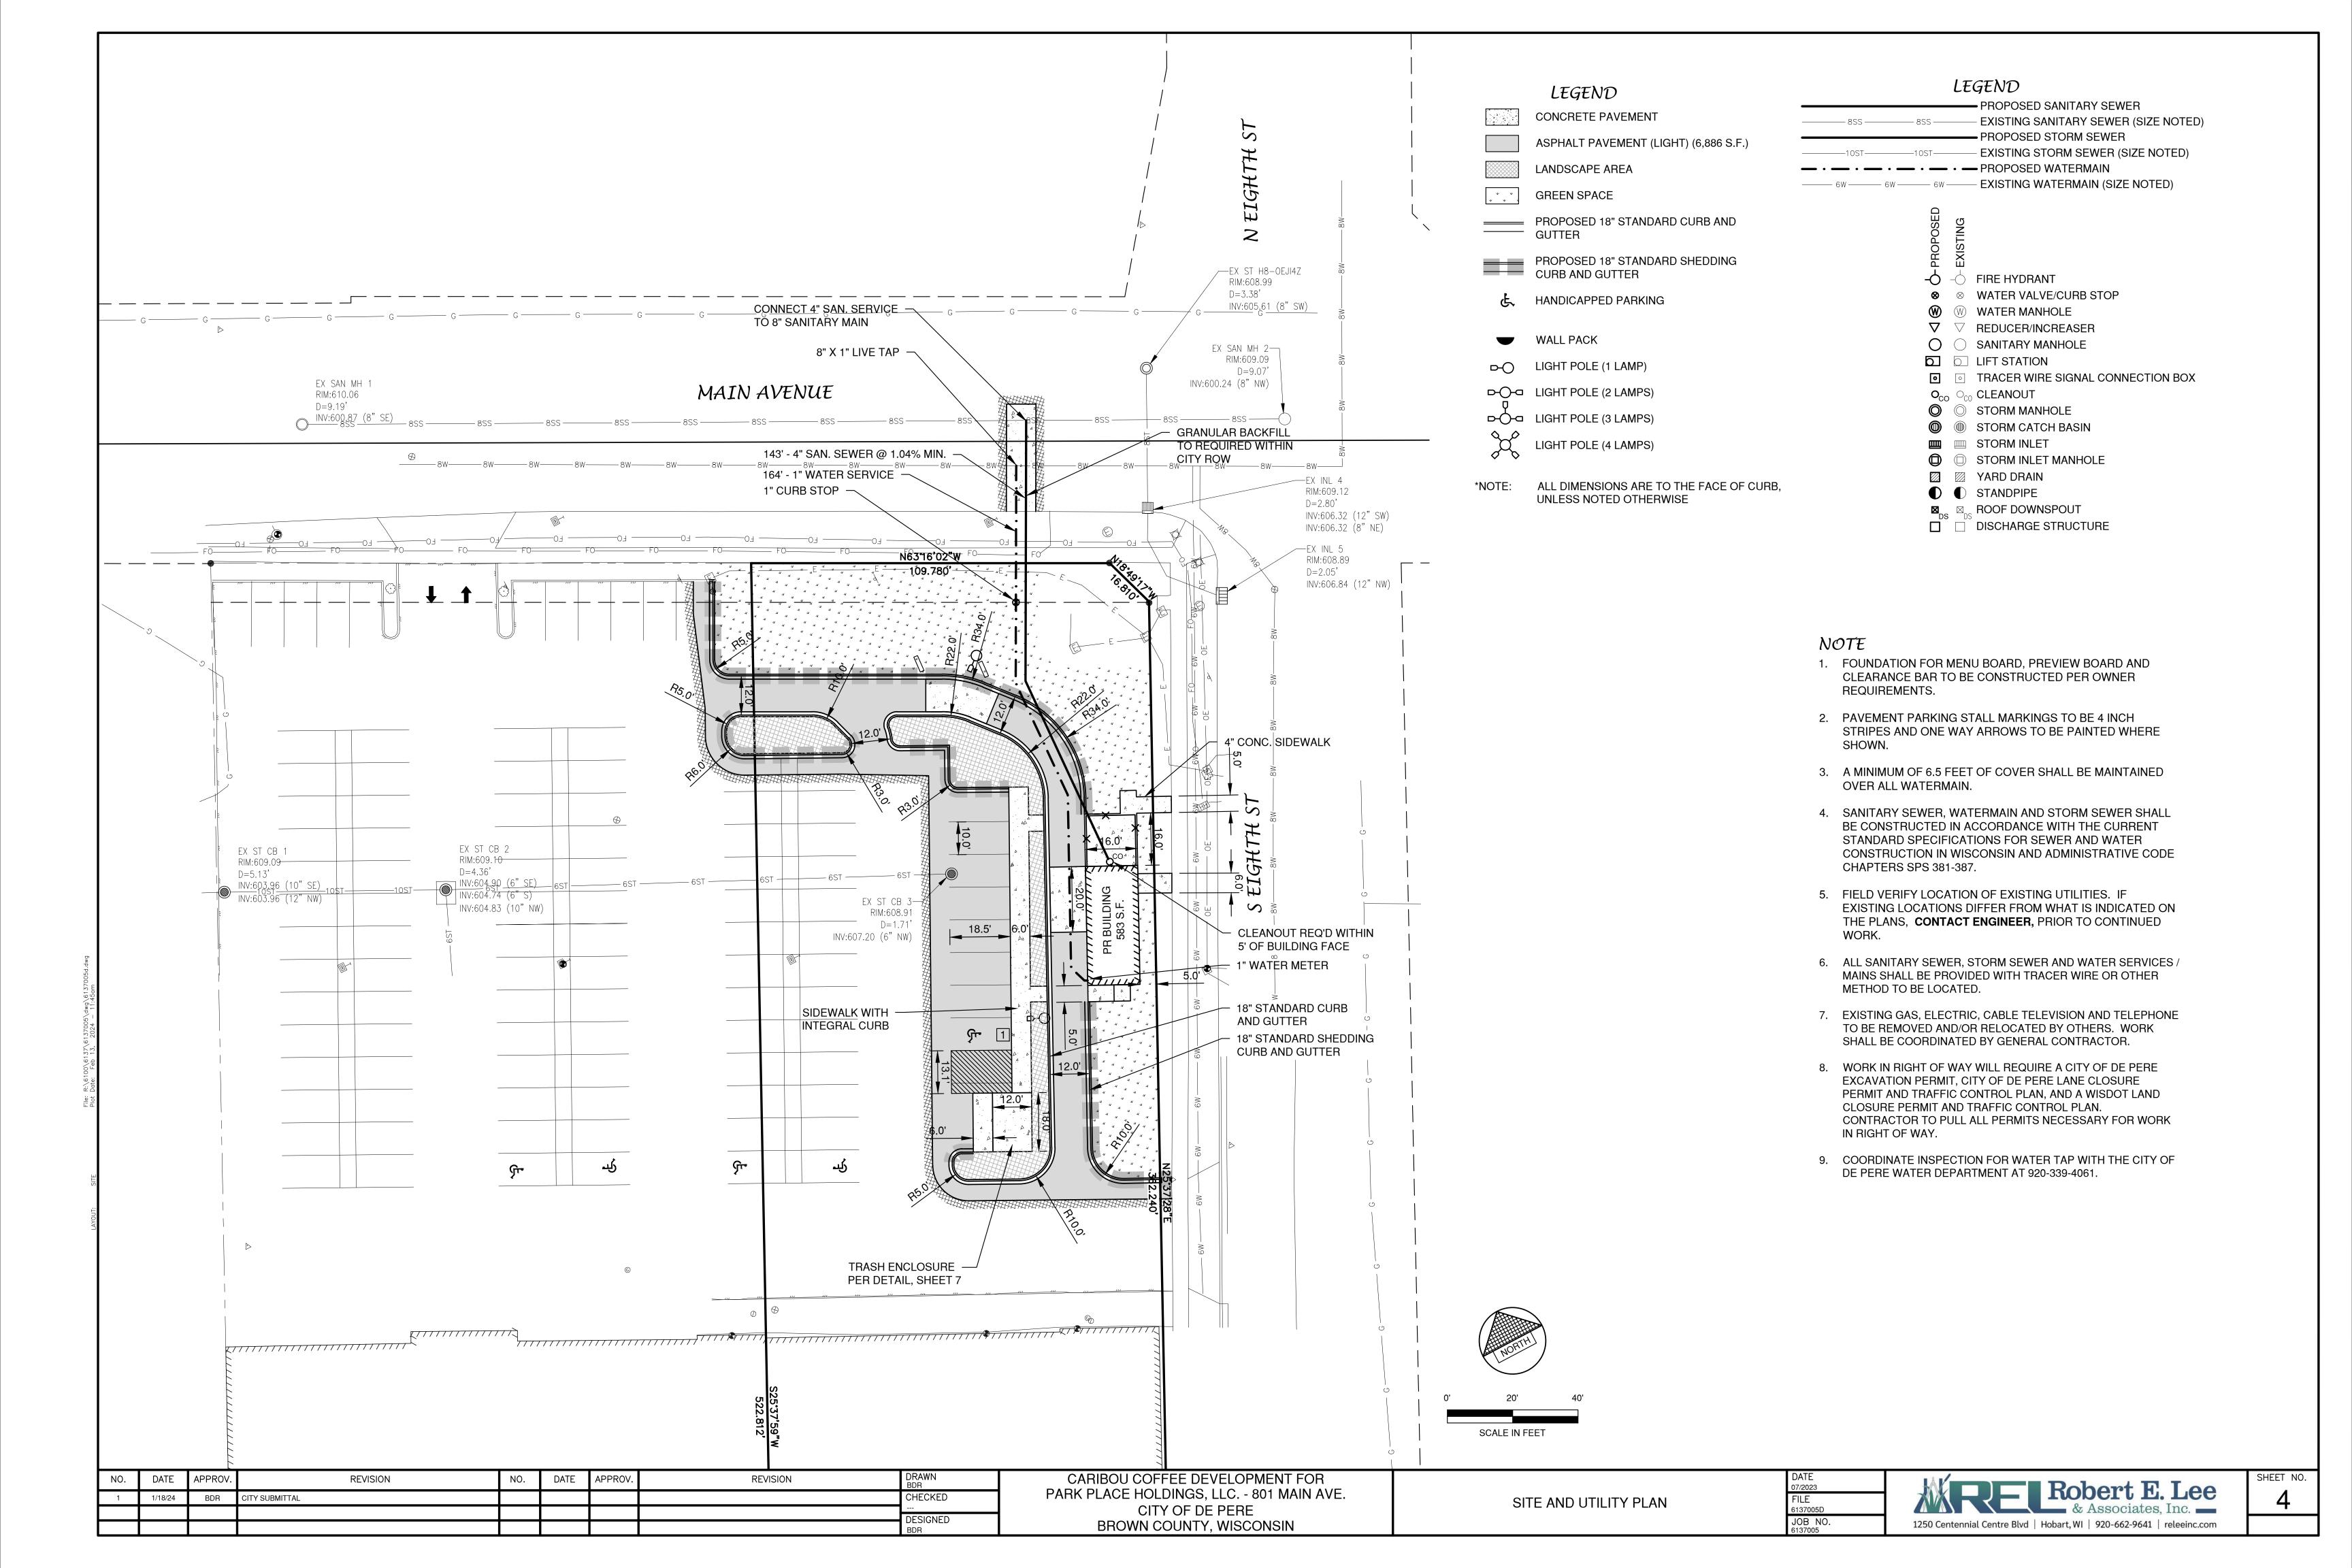


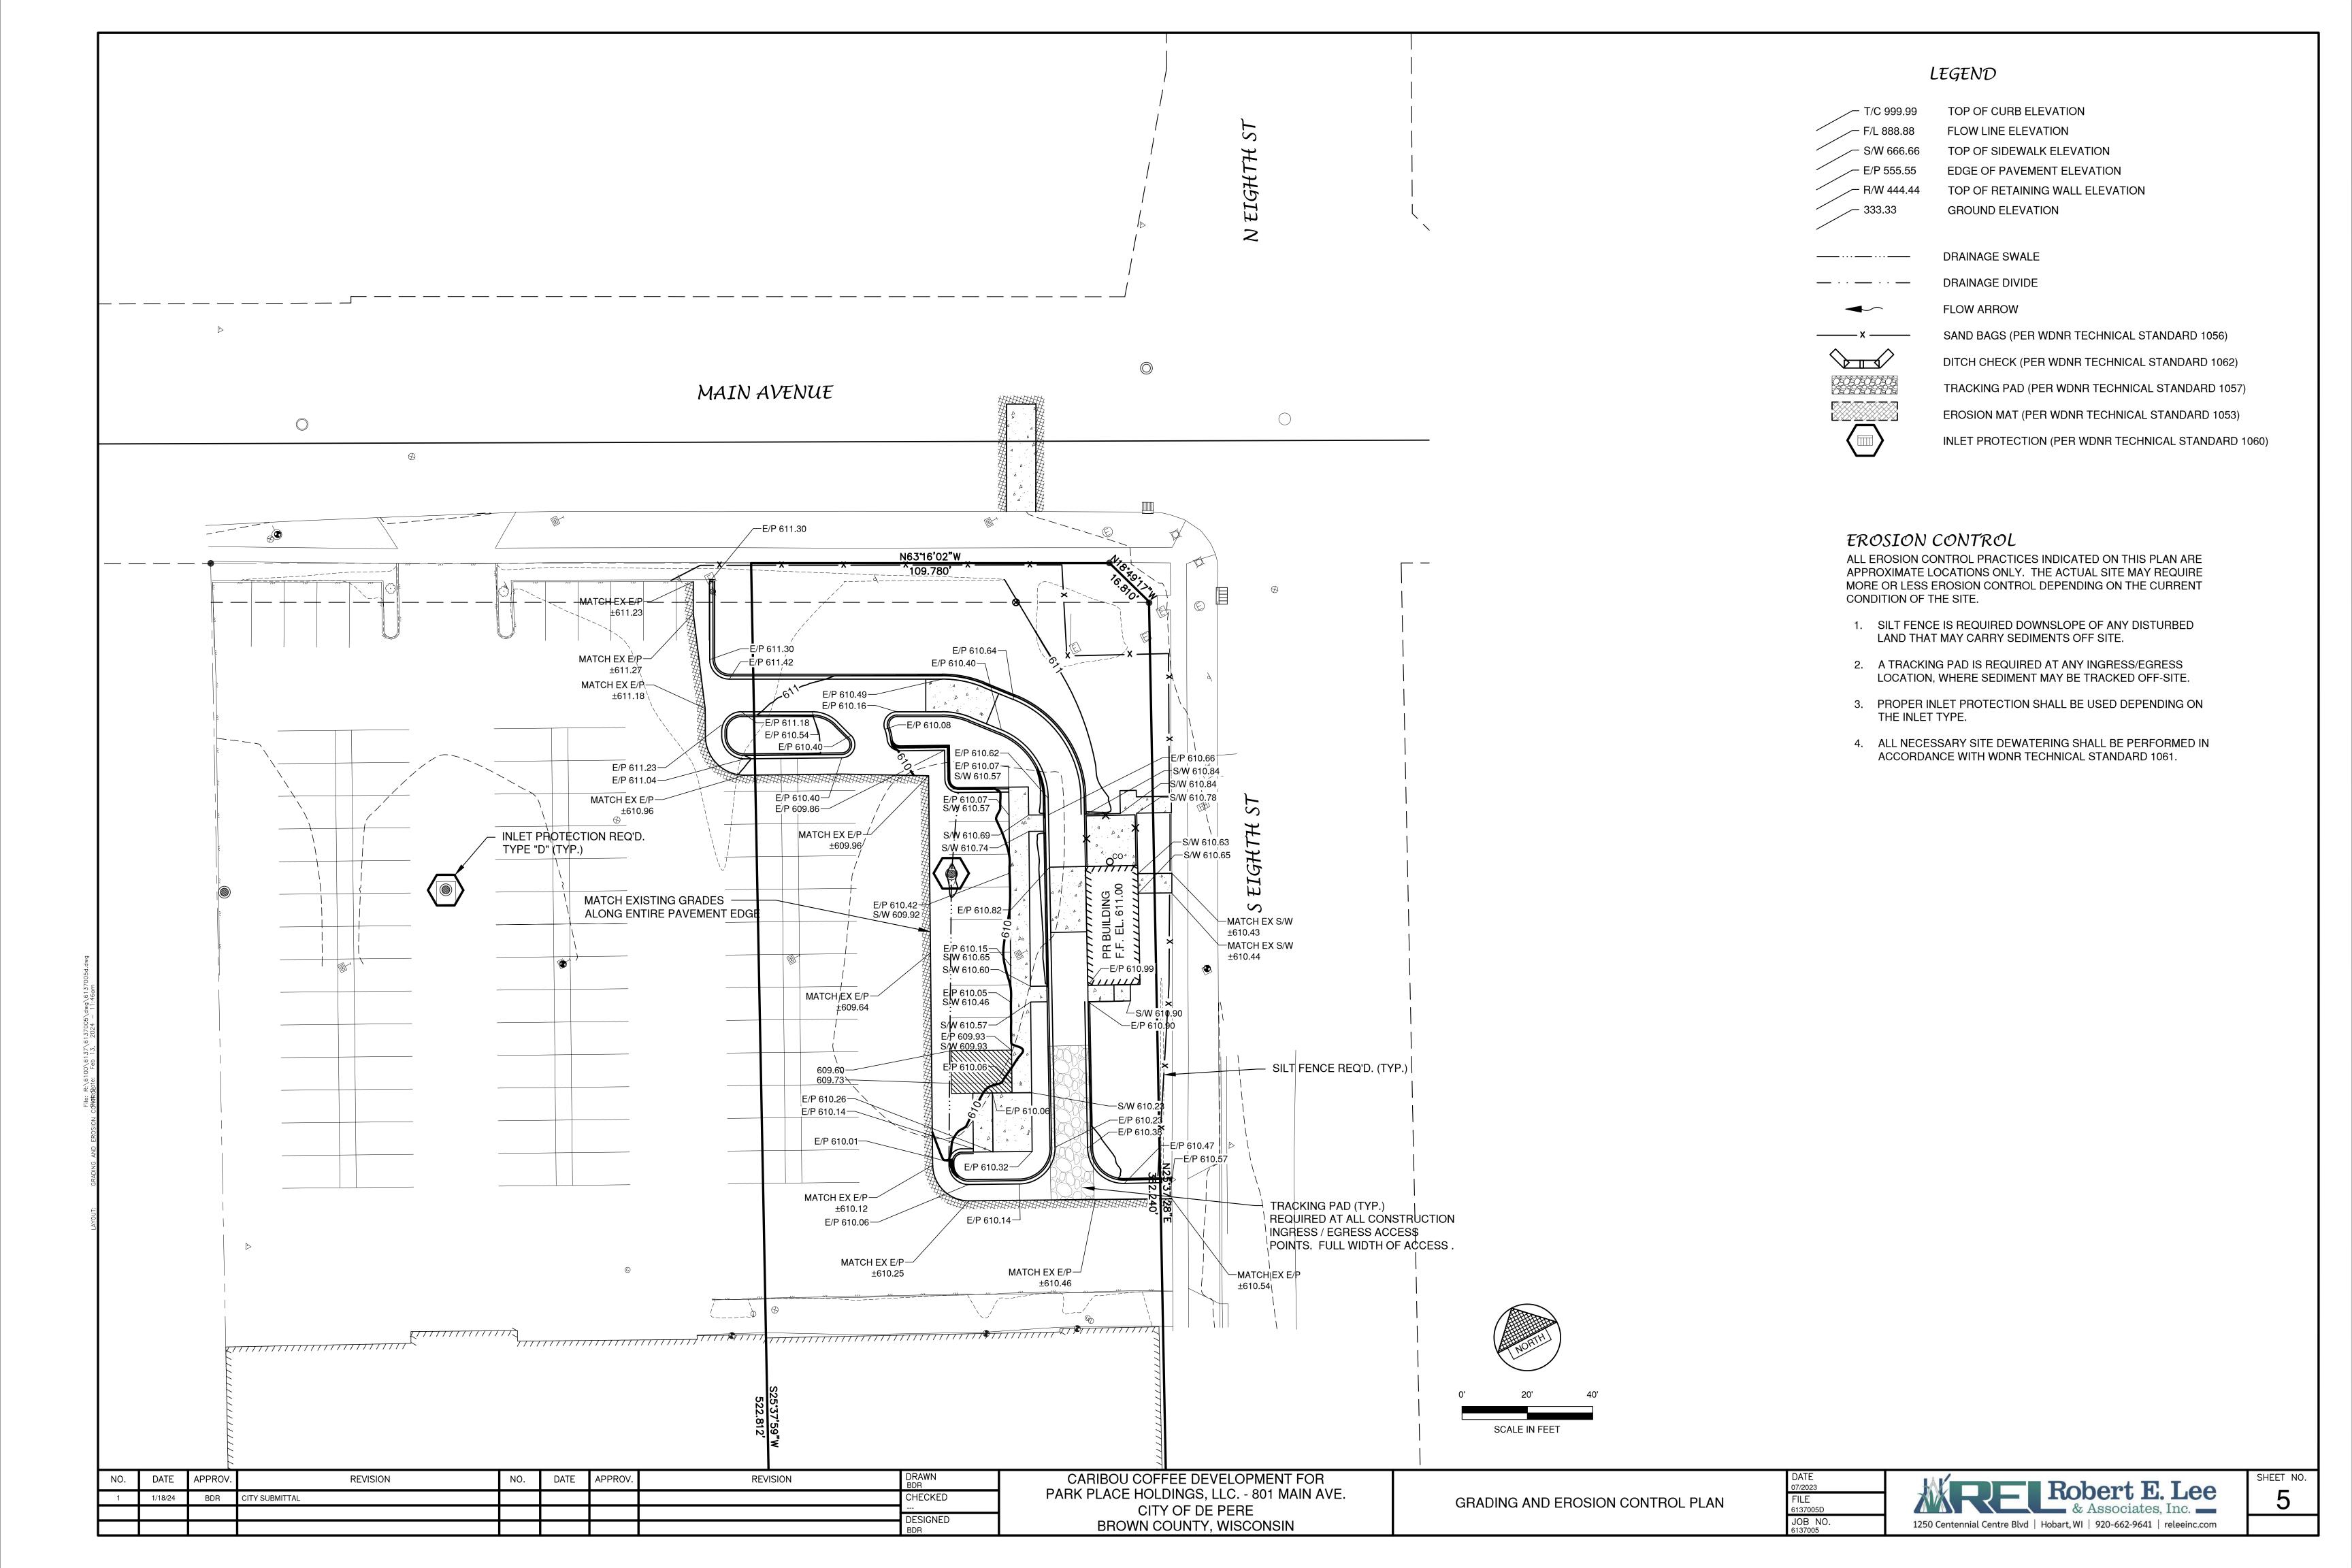


HDPE /PVC SEWER, WATERMAIN AND FORCEMAIN BEDDING AND TRENCH DETAIL

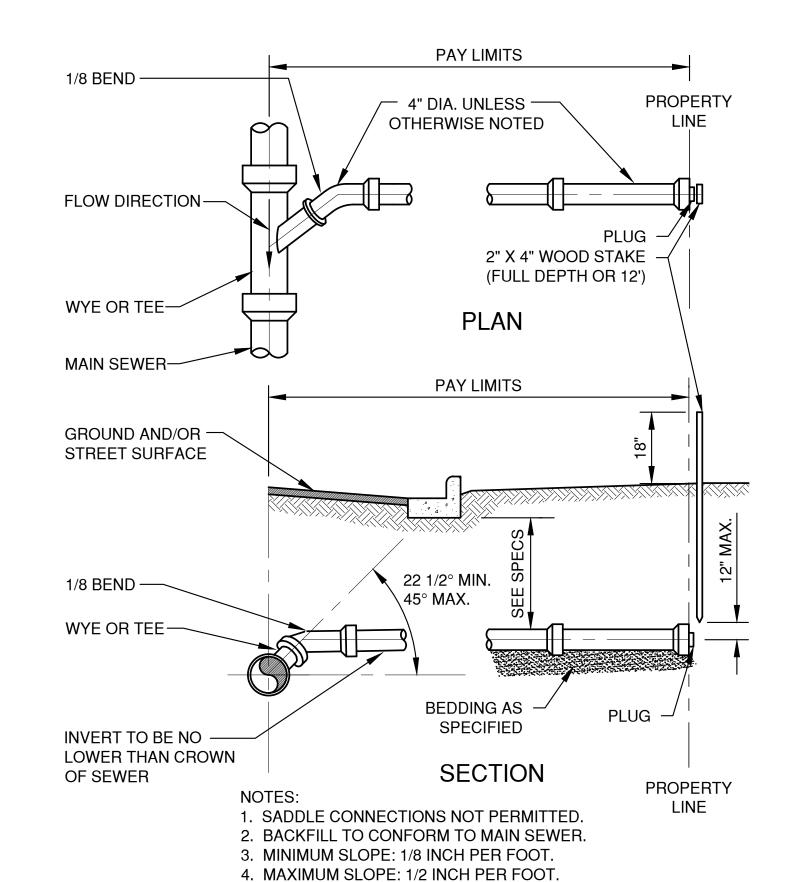

STANDARD SERVICE LATERAL

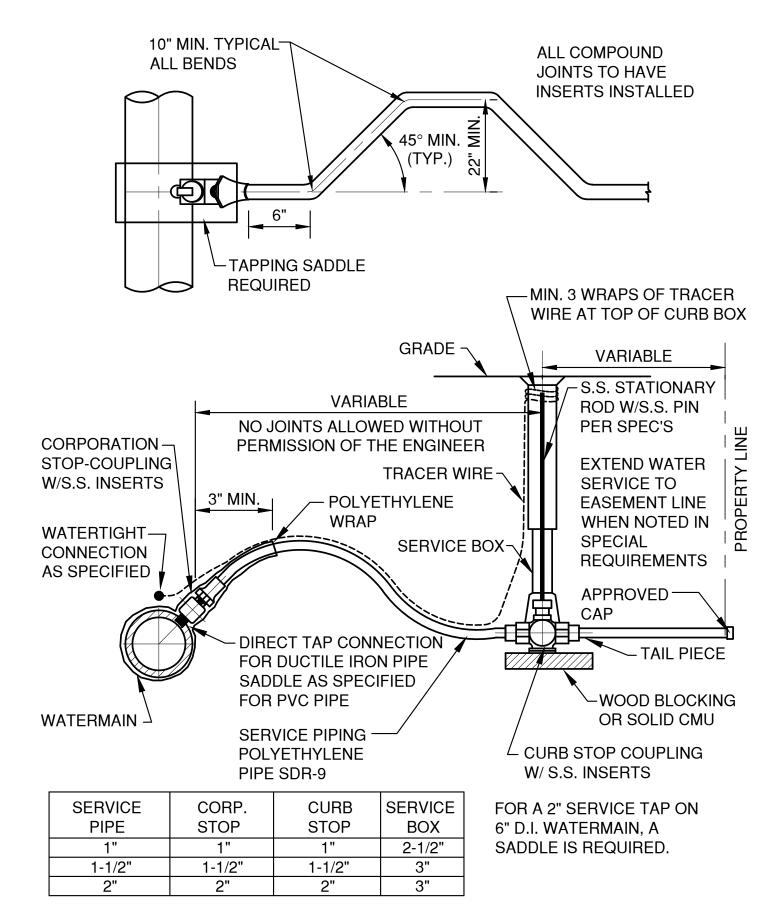


TAP SERVICE PIPING (POLYETHYLENE)

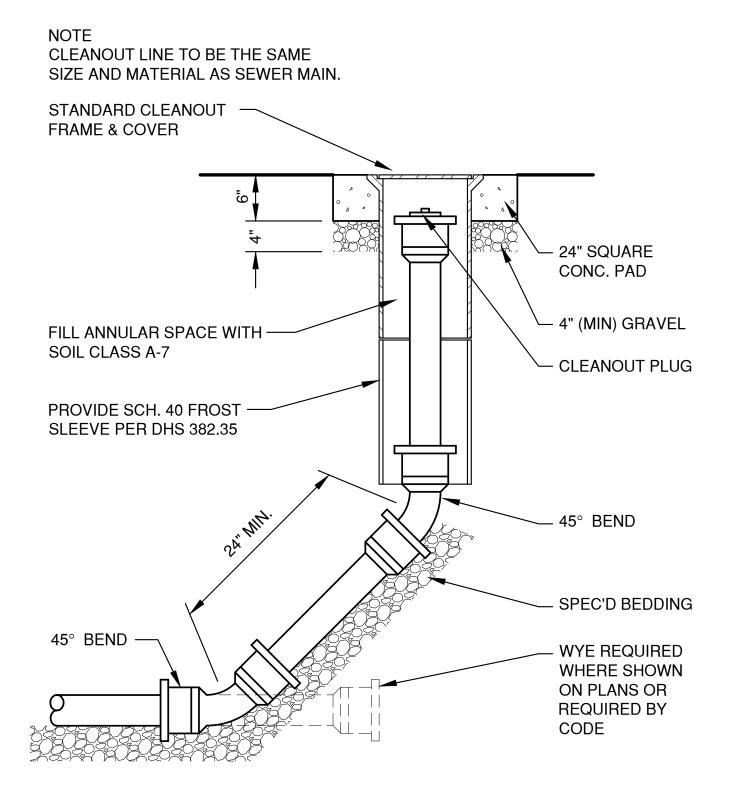


CLEAN-OUT DETAIL (TRAVELED AREAS)

NO.	DATE	APPROV.	REVISION	NO.	DATE	APPROV.	REVISION	DRAWN BDR
1	1/18/24	BDR	CITY SUBMITTAL					CHECKED
								 DESIGNED
								BDR

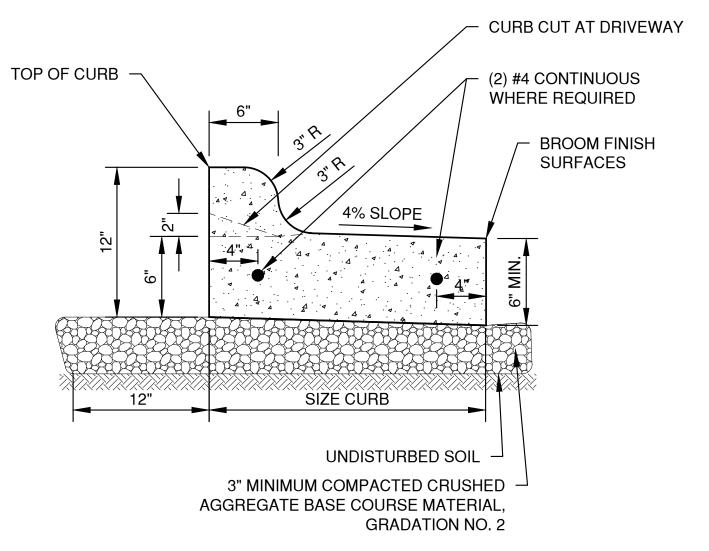


- 1. PROVIDE 1" EXPANSION JOINTS AT 300' INTERVALS OR AS SPECIFIED. PROVIDE CONTRACTION JOINTS EVERY 30' OR AS DIRECTED.
- 2. AT REMOVAL AND REPLACEMENT AREAS AND AT TIE-INS TO EXISTING CURB AND GUTTER, PROVIDE (2) #4 BARS, 18" LONG. DRILL AND GROUT INTO EXISTING CURB AND GUTTER 9". MATCH EXISTING SLOPE OF EXISTING GUTTER PAN.


SHEDDING CURB AND GUTTER

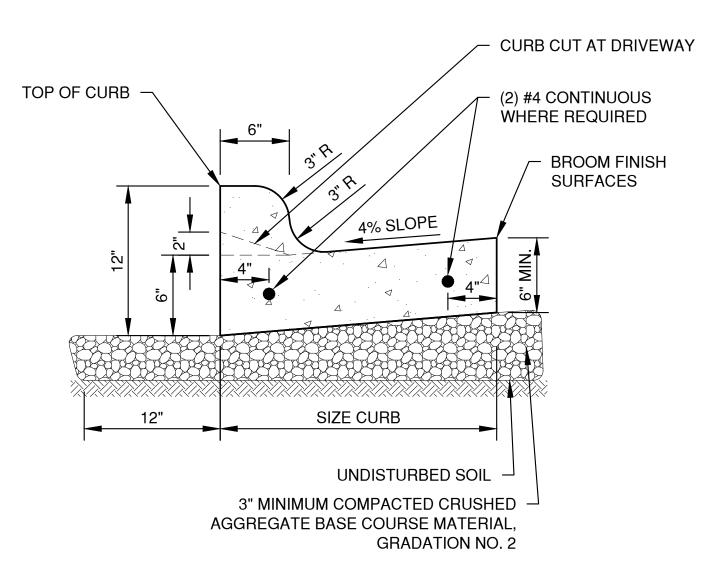

- 1. PROVIDE 1" EXPANSION JOINTS AT 300' INTERVALS OR AS SPECIFIED. PROVIDE CONTRACTION JOINTS EVERY 30' OR AS DIRECTED.
- 2. AT REMOVAL AND REPLACEMENT AREAS AND AT TIE-INS TO EXISTING CURB AND GUTTER, PROVIDE (2) #4 BARS, 18" LONG. DRILL AND GROUT INTO EXISTING CURB AND GUTTER 9". MATCH EXISTING SLOPE OF EXISTING GUTTER PAN.

STANDARD CURB AND GUTTER

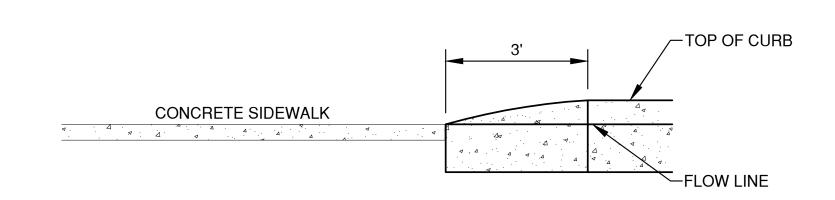


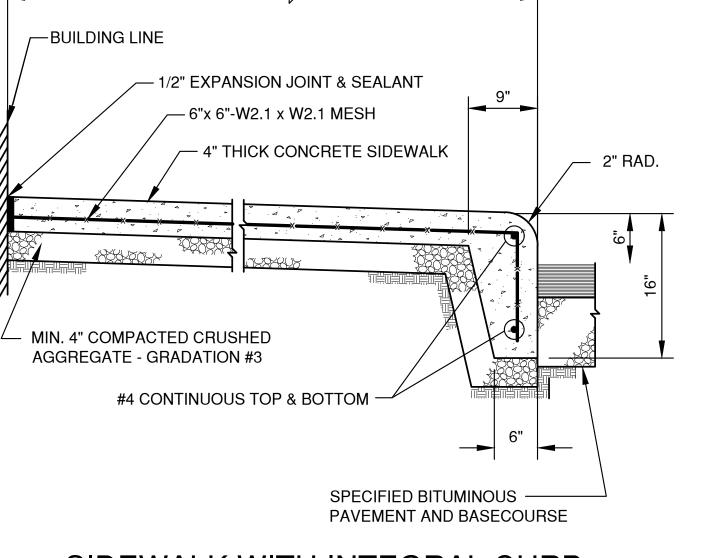


SEE PLAN


DIMENSION VARIES


SIDEWALK WITH INTEGRAL CURB

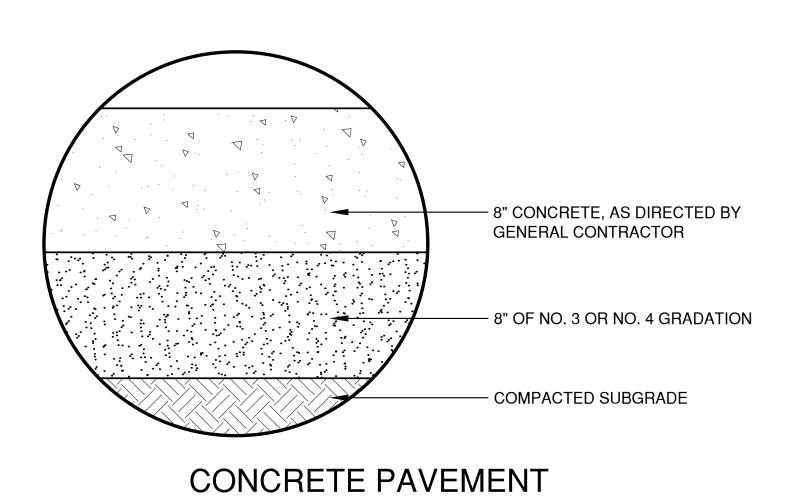


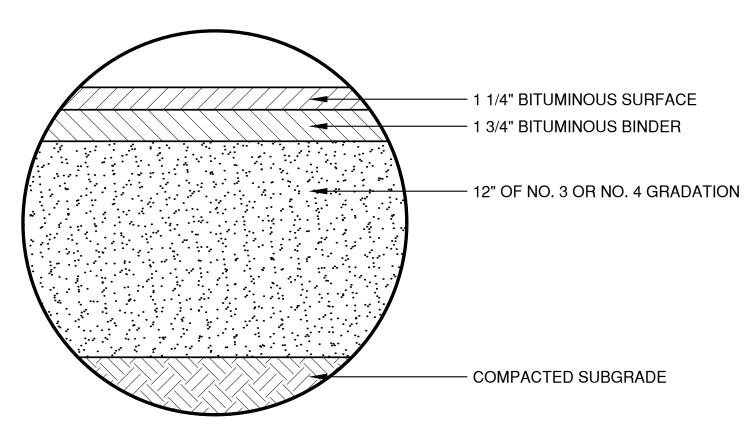

LIGHT DUTY ASPHALT PAVEMENT

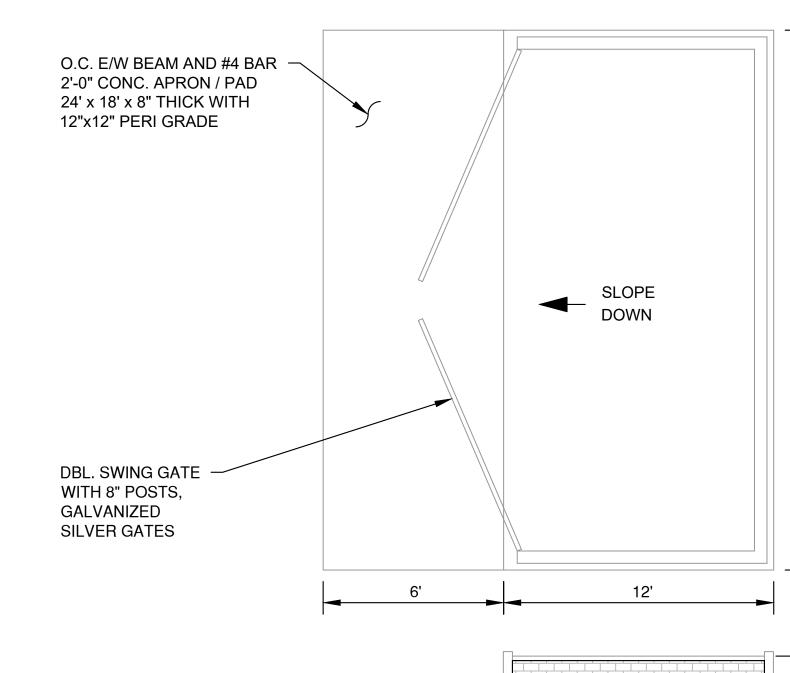

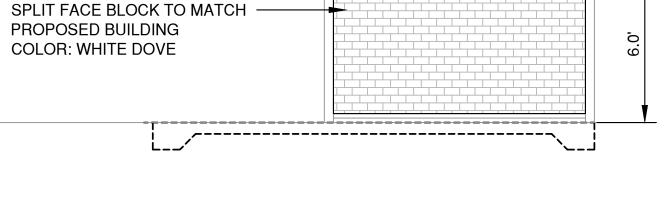

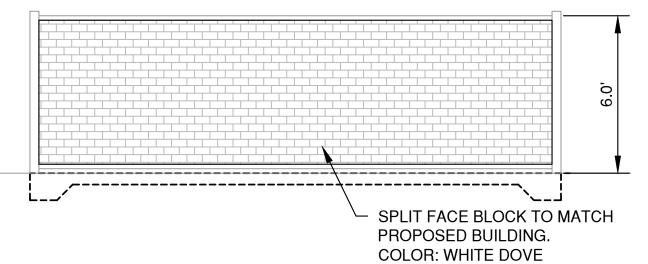

TRASH ENCLOSURE DETAIL *DETAILED CONSTRUCTION DETAILS PER GENERAL CONTRACTOR

CURB TAPER DETAIL

NO.	DATE	APPROV.	REVISION	NO.	DATE	APPROV.	REVISION	DRAWN BDR
1	1/18/24	BDR	CITY SUBMITTAL					CHECKED
								DESIGNED
								BDB

INLET PROTECTION NOTES:

INLET PROTECTION DEVICES SHALL BE IN ACCORDANCE WITH WDNR TECHNICAL STANDARD 1060, STORM DRAIN INLET PROTECTION FOR CONSTRUCTION SITES.

MANUFACTURED ALTERNATIVES APPROVED AND LISTED ON THE WDOT PRODUCT ACCEPTABILITY LIST MAY BE SUBSTITUTED.

WHEN REMOVING OR MAINTAINING INLET PROTECTION, CARE SHALL BE TAKEN SO THAT THE SEDIMENT TRAPPED ON THE GEOTEXTILE FABRIC DOES NOT FALL INTO THE INLET. ANY MATERIAL FALLING INTO THE INLET SHALL BE REMOVED IMMEDIATELY.

MAINTENANCE NOTES:

WHEN REMOVING OR MAINTAINING INLET PROTECTION, CARE SHALL BE TAKEN SO THAT THE SEDIMENT TRAPPED IN THE FABRIC DOES NOT FALL INTO THE STRUCTURE. MATERIAL THAT HAS FALLEN INTO THE INLET SHALL BE IMMEDIATELY REMOVED.

INSTALLATION NOTES: TYPE "B" AND "C"

TRIM EXCESS FABRIC IN THE FLOW LINE TO WITHIN 3" OF THE GRATE.

DEMONSTRATE A METHOD OF MAINTENANCE, USING A SEWN FLAP, HAND HOLDS OR OTHER METHOD TO PREVENT ACCUMULATED SEDIMENT FROM ENTERING THE INLET.

TYPE "D"


DO NOT INSTALL INLET PROTECTION TYPE D IN INLETS SHALLOWER THAN 30" MEASURED FROM THE BOTTOM OF THE INLET TO THE TOP OF THE GRATE.


TRIM EXCESS FABRIC IN THE FLOW LINE TO WITHIN 3" OF THE GRATE.

THE INSTALLED BAG SHALL HAVE A MINIMUM SIDE CLEARANCE, BETWEEN THE INLET WALLS AND THE BAG, MEASURED AT THE BOTTOM OF THE OVERFLOW HOLES, OF 3". WHERE NECESSARY, CINCH THE BAG, USING PLASTIC ZIP TIES, TO ACHIEVE THE 3" CLEARANCE, THE TIES SHALL BE PLACED AT THE MAXIMUM OF 4" FROM THE BOTTOM OF THE BAG.


NOTES:

- TAPER BOTTOM OF BAG TO MAINTAIN THREE INCHES OF CLEARANCE BETWEEN THE BAG AND THE STRUCTURE, MEASURED FROM THE BOTTOM OF THE OVERFLOW OPENINGS TO THE STRUCTURE WALL.
- GEOTEXTILE FABRIC TYPE FF FOR FLAPS, TOP AND BOTTOM OF THE OUTSIDE OF FILTER BAG. FRONT, BACK AND BOTTOM OF FILTER BAG BEING ONE PIECE.
- FRONT LIFTING FLAP IS TO BE USED WHEN REMOVING AND MAINTAINING FILTER BAG.
- SIDE FLAPS SHALL BE A MAXIMUM OF TWO INCHES LONG. FOLD THE FABRIC OVER AND REINFORCE WITH MULTIPLE STITCHES.
- FLAP POCKETS SHALL BE LARGE ENOUGH TO ACCEPT WOOD 2" X 4". THE REBAR, STEEL PIPE, OR WOOD SHALL BE INSTALLED IN THE REAR FLAP AND SHALL NOT BLOCK THE TOP HALF OF THE CURB FACE OPENING.

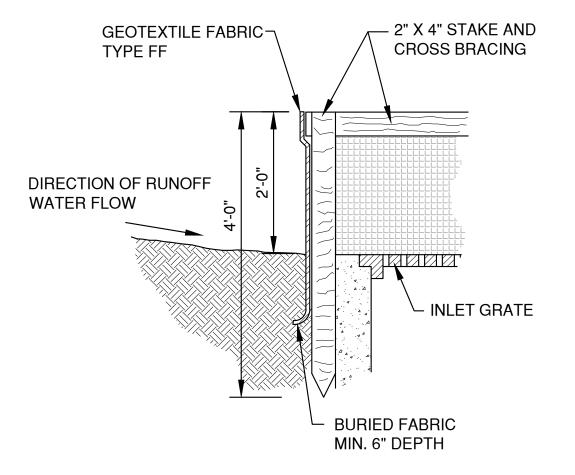


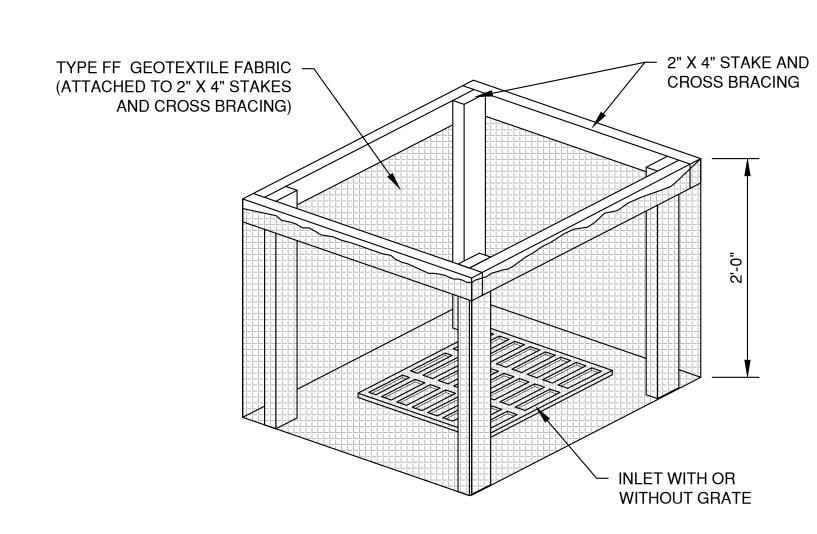

INLET PROTECTION, TYPE A

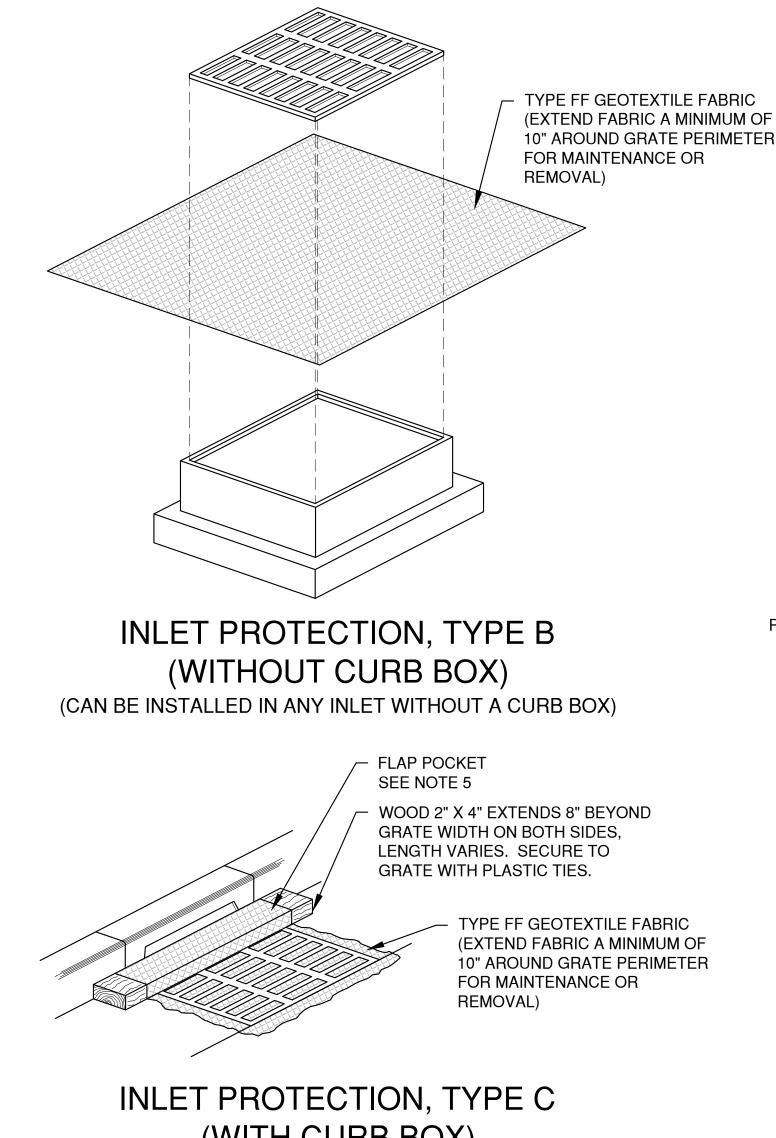



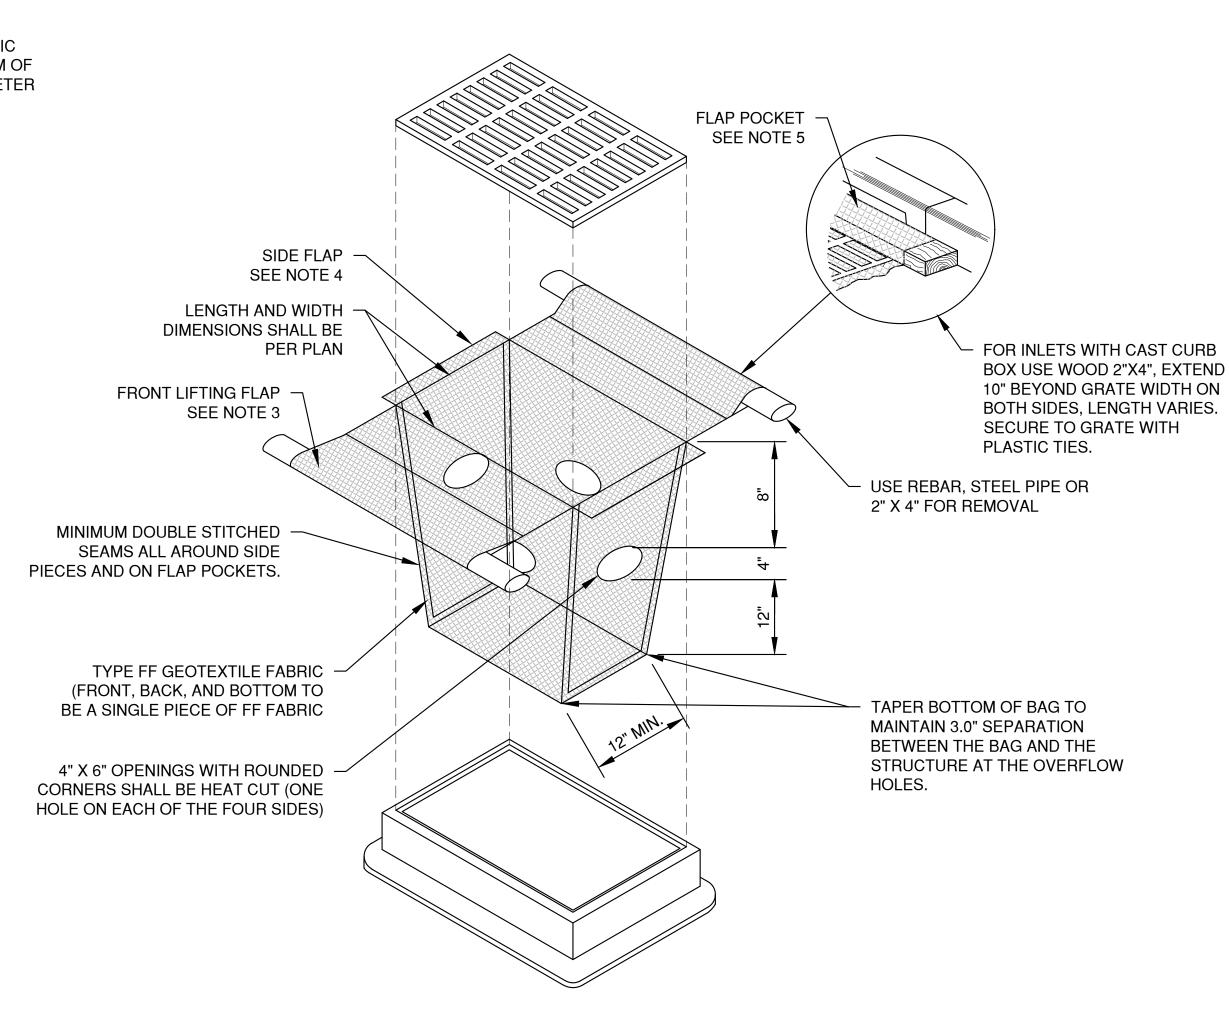

INLET PROTECTION, TYPE D (CAN BE INSTALLED IN INLETS WITH OR WITHOUT CURB BOXES)

DATE REVISION **REVISION** CHECKED BDR CITY SUBMITTAL DESIGNED

CARIBOU COFFEE DEVELOPMENT FOR PARK PLACE HOLDINGS, LLC. - 801 MAIN AVE. CITY OF DE PERE **BROWN COUNTY, WISCONSIN**

EROSION CONTROL INLET PROTECTION TYPES A, B, C AND D 6137005EC

1250 Centennial Centre Blvd | Hobart, WI | 920-662-9641 | releeinc.com

NOTES:


- TAPER BOTTOM OF BAG TO MAINTAIN THREE INCHES OF CLEARANCE BETWEEN THE BAG AND THE STRUCTURE, MEASURED FROM THE BOTTOM OF THE OVERFLOW OPENINGS TO THE STRUCTURE WALL.
- GEOTEXTILE FABRIC TYPE FF FOR FLAPS AND TOP HALF OF FILTER BAG. GEOTEXTILE FABRIC TYPE HR FOR BOTTOM HALF OF FILTER BAG. FRONT, BACK AND BOTTOM OF FILTER BAG BEING ONE PIECE.
- FRONT LIFTING FLAP IS TO BE USED WHEN REMOVING AND MAINTAINING FILTER BAG.
- SIDE FLAPS SHALL BE A MAXIMUM OF TWO INCHES LONG. FOLD THE FABRIC OVER AND REINFORCE WITH MULTIPLE STITCHES.
- FLAP POCKETS SHALL BE LARGE ENOUGH TO ACCEPT WOOD 2" X 4". THE REBAR, STEEL PIPE, OR WOOD SHALL BE INSTALLED IN THE REAR FLAP AND SHALL NOT BLOCK THE TOP HALF OF THE CURB FACE OPENING.


MAINTENANCE NOTES:

WHEN REMOVING OR MAINTAINING INLET PROTECTION, CARE SHALL BE TAKEN SO THAT THE SEDIMENT TRAPPED IN THE FABRIC DOES NOT FALL INTO THE STRUCTURE. MATERIAL THAT HAS FALLEN INTO THE INLET SHALL BE IMMEDIATELY REMOVED.

NOTES:


- TAPER BOTTOM OF BAG TO MAINTAIN THREE INCHES OF CLEARANCE BETWEEN THE BAG AND THE STRUCTURE, MEASURED FROM THE BOTTOM OF THE OVERFLOW OPENINGS TO THE STRUCTURE WALL.
- GEOTEXTILE FABRIC TYPE FF FOR FLAPS, TOP AND BOTTOM OF OUTSIDE OF FILTER BAG. FRONT, BACK AND BOTTOM OF FILTER BAG BEING ONE PIECE.
- 3. FRONT LIFTING FLAP IS TO BE USED WHEN REMOVING AND MAINTAINING FILTER BAG.
- SIDE FLAPS SHALL BE A MAXIMUM OF TWO INCHES LONG. FOLD THE FABRIC OVER AND REINFORCE WITH MULTIPLE STITCHES.
- 5. FLAP POCKETS SHALL BE LARGE ENOUGH TO ACCEPT WOOD 2" X 4". THE REBAR, STEEL PIPE, OR WOOD SHALL BE INSTALLED IN THE REAR FLAP AND SHALL NOT BLOCK THE TOP HALF OF THE CURB FACE OPENING.

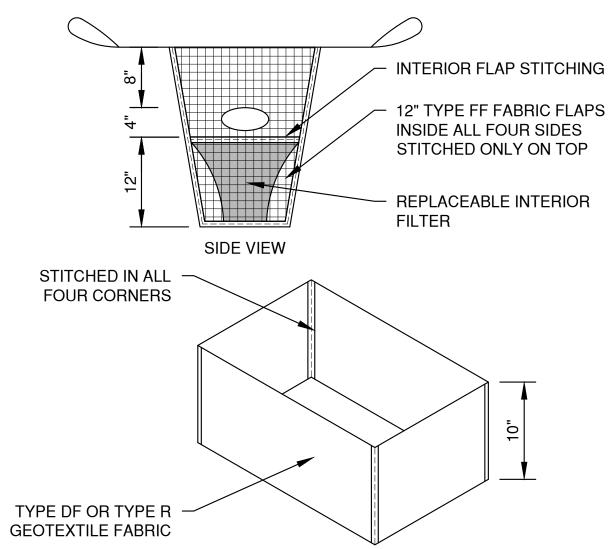

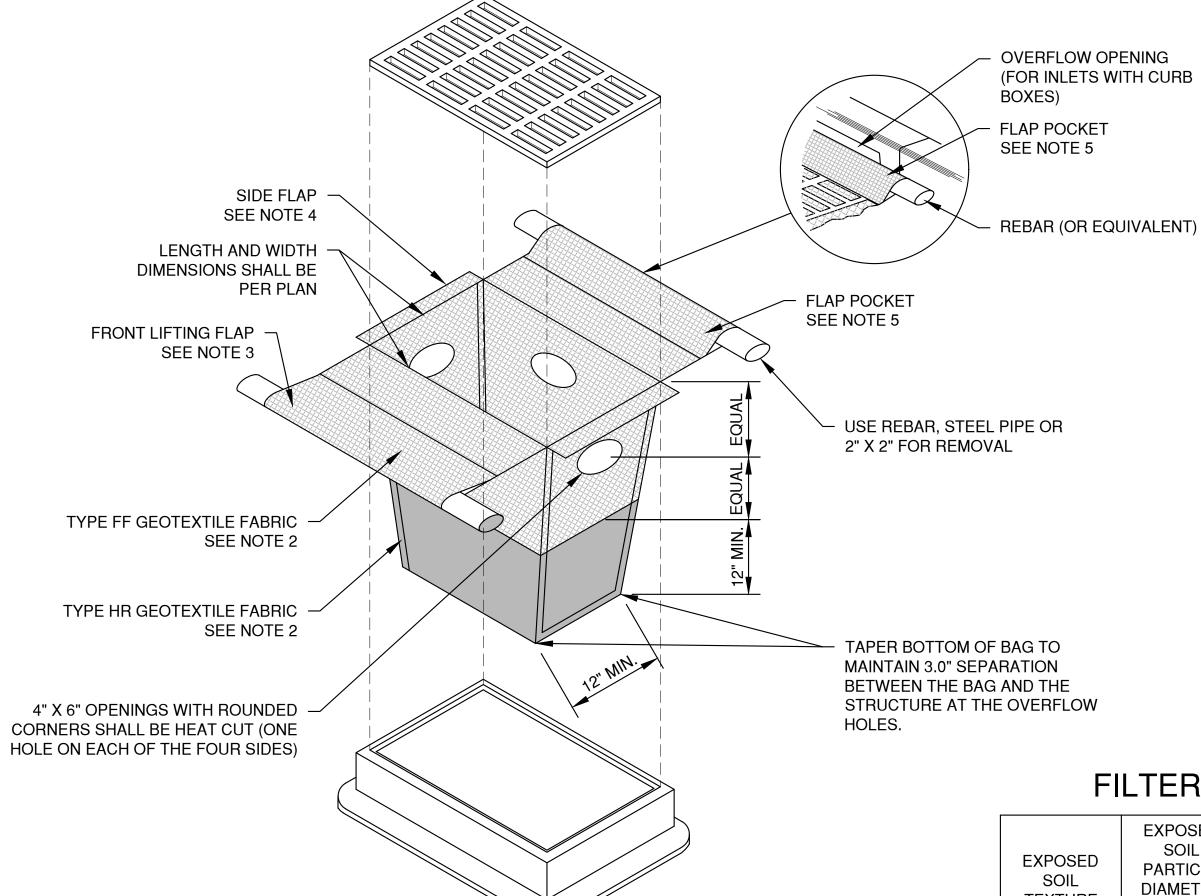

INLET PROTECTION, TYPE D-HR

(CAN BE INSTALLED IN INLETS WITH OR WITHOUT CURB BOXES)

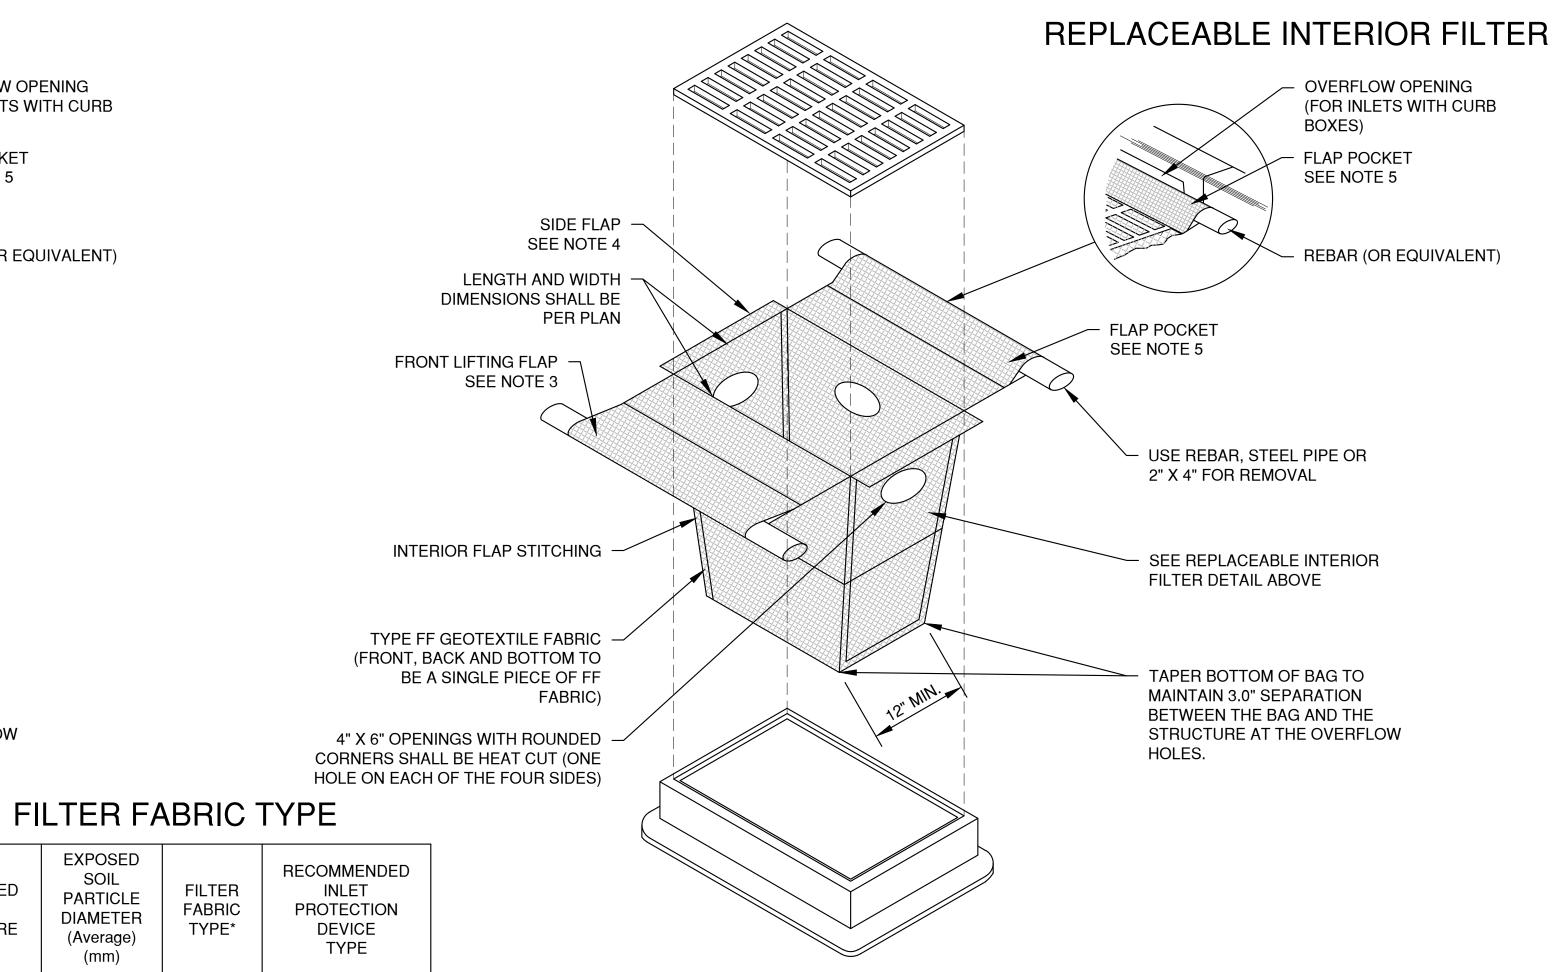

INLET PROTECTION, TYPE D-M

(CAN BE INSTALLED IN INLETS WITH OR WITHOUT CURB BOXES)

EXPOSED SOIL TEXTURE	EXPOSED SOIL PARTICLE DIAMETER (Average) (mm)	FILTER FABRIC TYPE*	RECOMMENDED INLET PROTECTION DEVICE TYPE
COARSE (SAND)	<u></u> 20.0625	FF	D, D-M
MEDIUM (SILT LOAM)	0.0624 - 0.005	DF	D, D-M
FINE	< 0.004	R	D-M
(CLAY)	≤ 0.004	HR	D-HR

* DF, R OR HR FILTERS MAY BE USED WHERE FF IS THE REQUIRED MINIMUM STANDARD. R OR HR MAY BE USED WHERE DF IS THE REQUIRED MINIMUM STANDARD.


** FOLLOW DESIGN CRITERIA OF WDNR TECHNICAL STANDARD 1060


DATE APPROV. DATE REVISION **REVISION** CHECKED BDR CITY SUBMITTAL 1/18/24 DESIGNED

CARIBOU COFFEE DEVELOPMENT FOR PARK PLACE HOLDINGS, LLC. - 801 MAIN AVE. CITY OF DE PERE **BROWN COUNTY, WISCONSIN**

EROSION CONTROL INLET PROTECTION TYPE D-HR AND TYPE D-M

6137005EC JOB NO. 1250 Centennial Centre Blvd | Hobart, WI | 920-662-9641 | releeinc.com

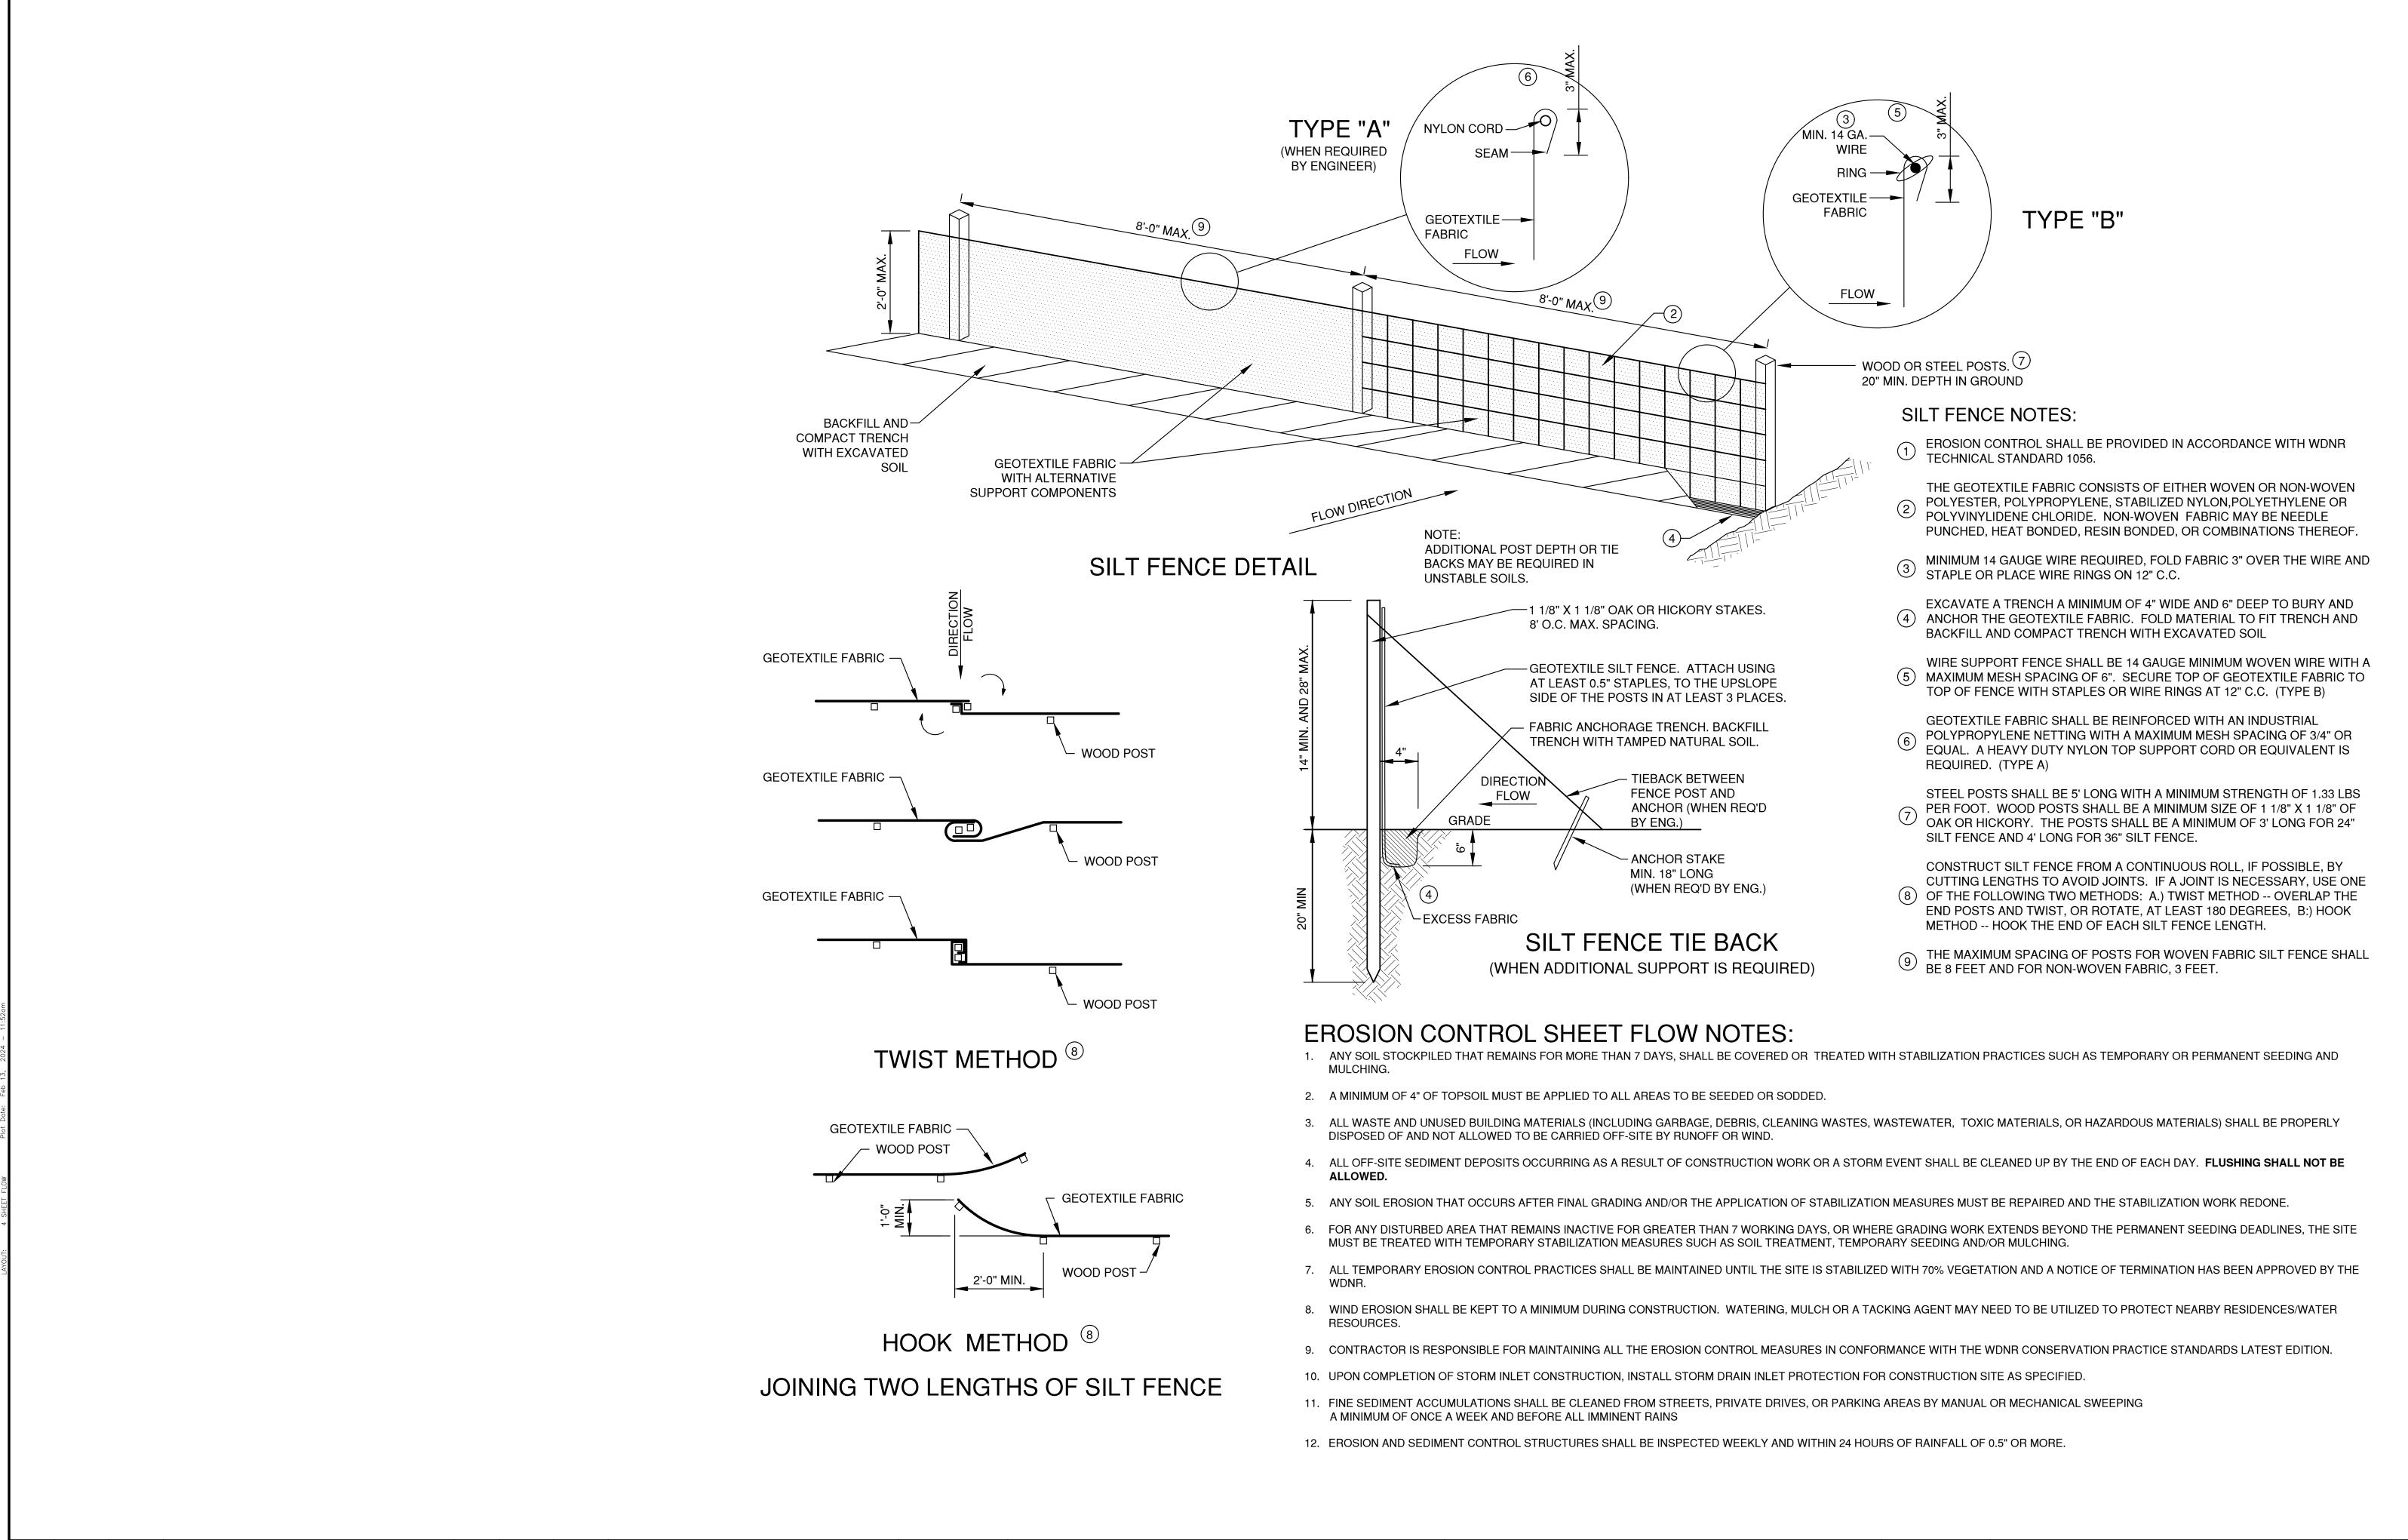


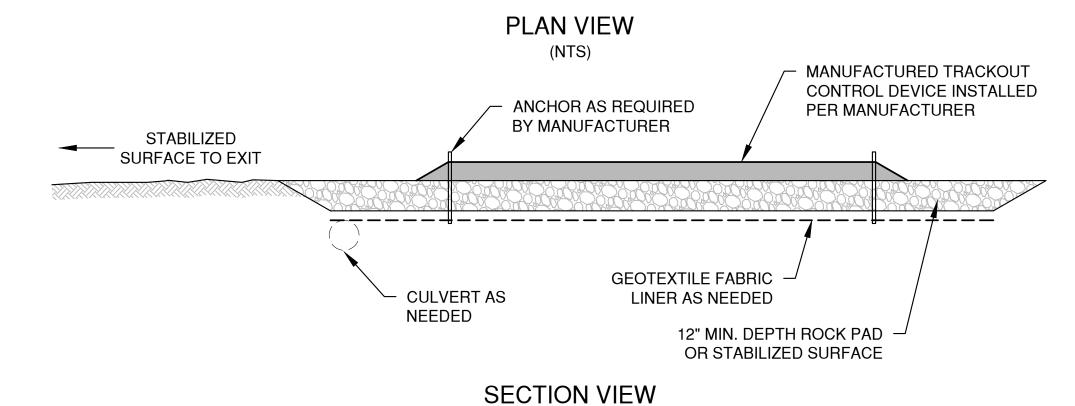


NOTES:

- 1. THIS DETAIL IS PROVIDED AS AN EXAMPLE. COMPLY WITH MANUFACTURER'S SPECIFICATIONS WHILE ALSO MEETING THE MINIMUM MANUFACTURED TRACKING PAD LENGTH AND WIDTH DESCRIBED IN THIS TECHNICAL STANDARD.
- 2. INSTALL SUCH THAT RUNOFF FLOWS TO AN APPROVED TREATMENT PRACTICE.
- 3. A THINNER STONE LAYER OR OTHER STABLE SURFACE MAY BE ACCEPTABLE SUCH THAT RUTTING IS MINIMIZED AS VEHICLES MOUNT OR DISMOUNT FROM THE MANUFACTURERS TRACKOUT CONTROL DEVICE.
- 4. SELECT FABRIC TYPE BASED ON SOIL CONDITIONS AND VEHICLES LOADING.
- 5. DIRECT ALL EXISTING VEHICLES OVER MANUFACTURED TRACKOUT CONTROL DEVICE. STONE TRACKING PAD INSTALLATION ACROSS REMAINING ACCESS WIDTH IS RECOMMENDED. A 12' MINIMUM CAN BE USED WHEN EXITING TRAFFIC IS RESTRICTED TO A DEDICATED EGRESS LANE.
- 6. IF MINIMUM INSTALLATION LENGTH IS NOT POSSIBLE DUE TO SITE GEOMETRY, INSTALL THE MAXIMUM LENGTH PRACTICABLE AND SUPPLEMENT WITH ADDITIONAL PRACTICES AS NEEDED.
- 7. ACCOMMODATE EXITING VEHICLES IN EXCESS OF MANUFACTURED TRACKOUT CONTROL DEVICE WEIGHT CAPACITY WITH OTHER TREATMENT PRACTICES.

MANUFACTURED TRACKOUT CONTROL DETAIL

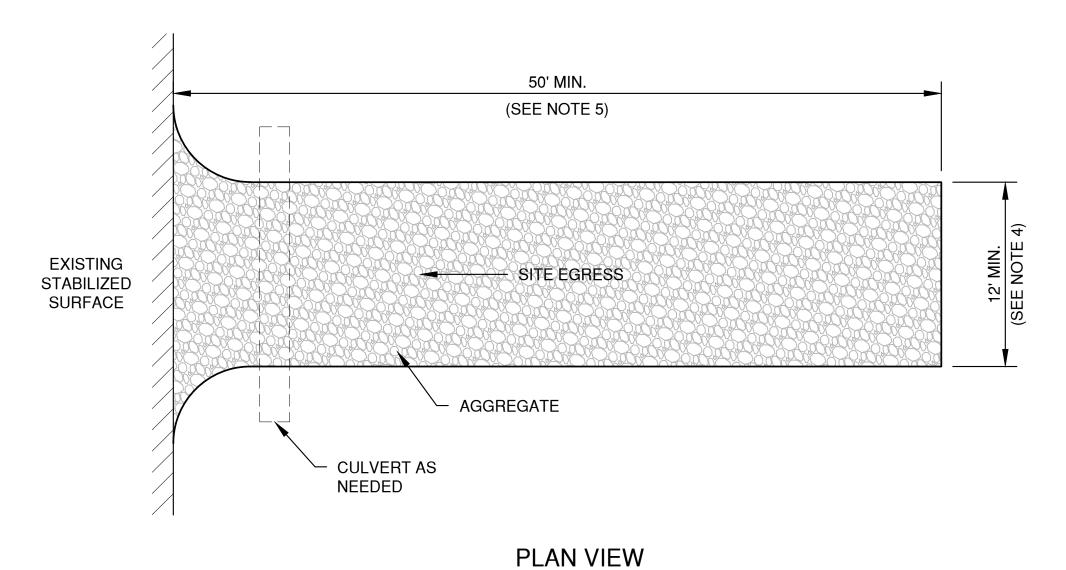

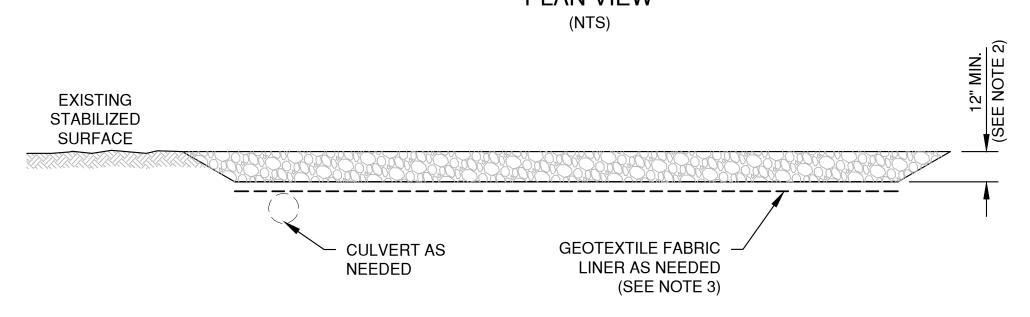

SECTION VIEW


NOTES:

1. USE HARD, DURABLE, ANGULAR STONE OR RECYCLED CONCRETE, MEETING THE FOLLOWING GRADATION:

SIEVE SIZE:	PERCENT BY WEIGHT PASSING:
3"	100
2 1/2"	90-100
1 1/2"	25-60
3/4"	0-20
3/8"	0-5

- 2. SLOPE THE STONE TRACKING PAD IN A MANNER TO DIRECT RUNOFF TO AN APPROVED TREATMENT PRACTICE.
- 3. SELECT FABRIC TYPE BASED ON SOIL CONDITIONS AND VEHICLES LOADING.
- 4. INSTALL TRACKING PAD ACROSS FULL WIDTH OF THE ACCESS POINT, OR RESTRICT EXISTING TRAFFIC TO A DEDICATED EGRESS LANE AT LEAST 12 FEET WIDE ACROSS THE TOP OF THE PAD.
- 5. IF A 50' PAD LENGTH IS NOT POSSIBLE DUE TO SITE GEOMETRY, INSTALL THE MAXIMUM LENGTH PRACTICABLE AND SUPPLEMENT WITH ADDITIONAL PRACTICES AS NEEDED.

STONE TRACKING PAD DETAIL

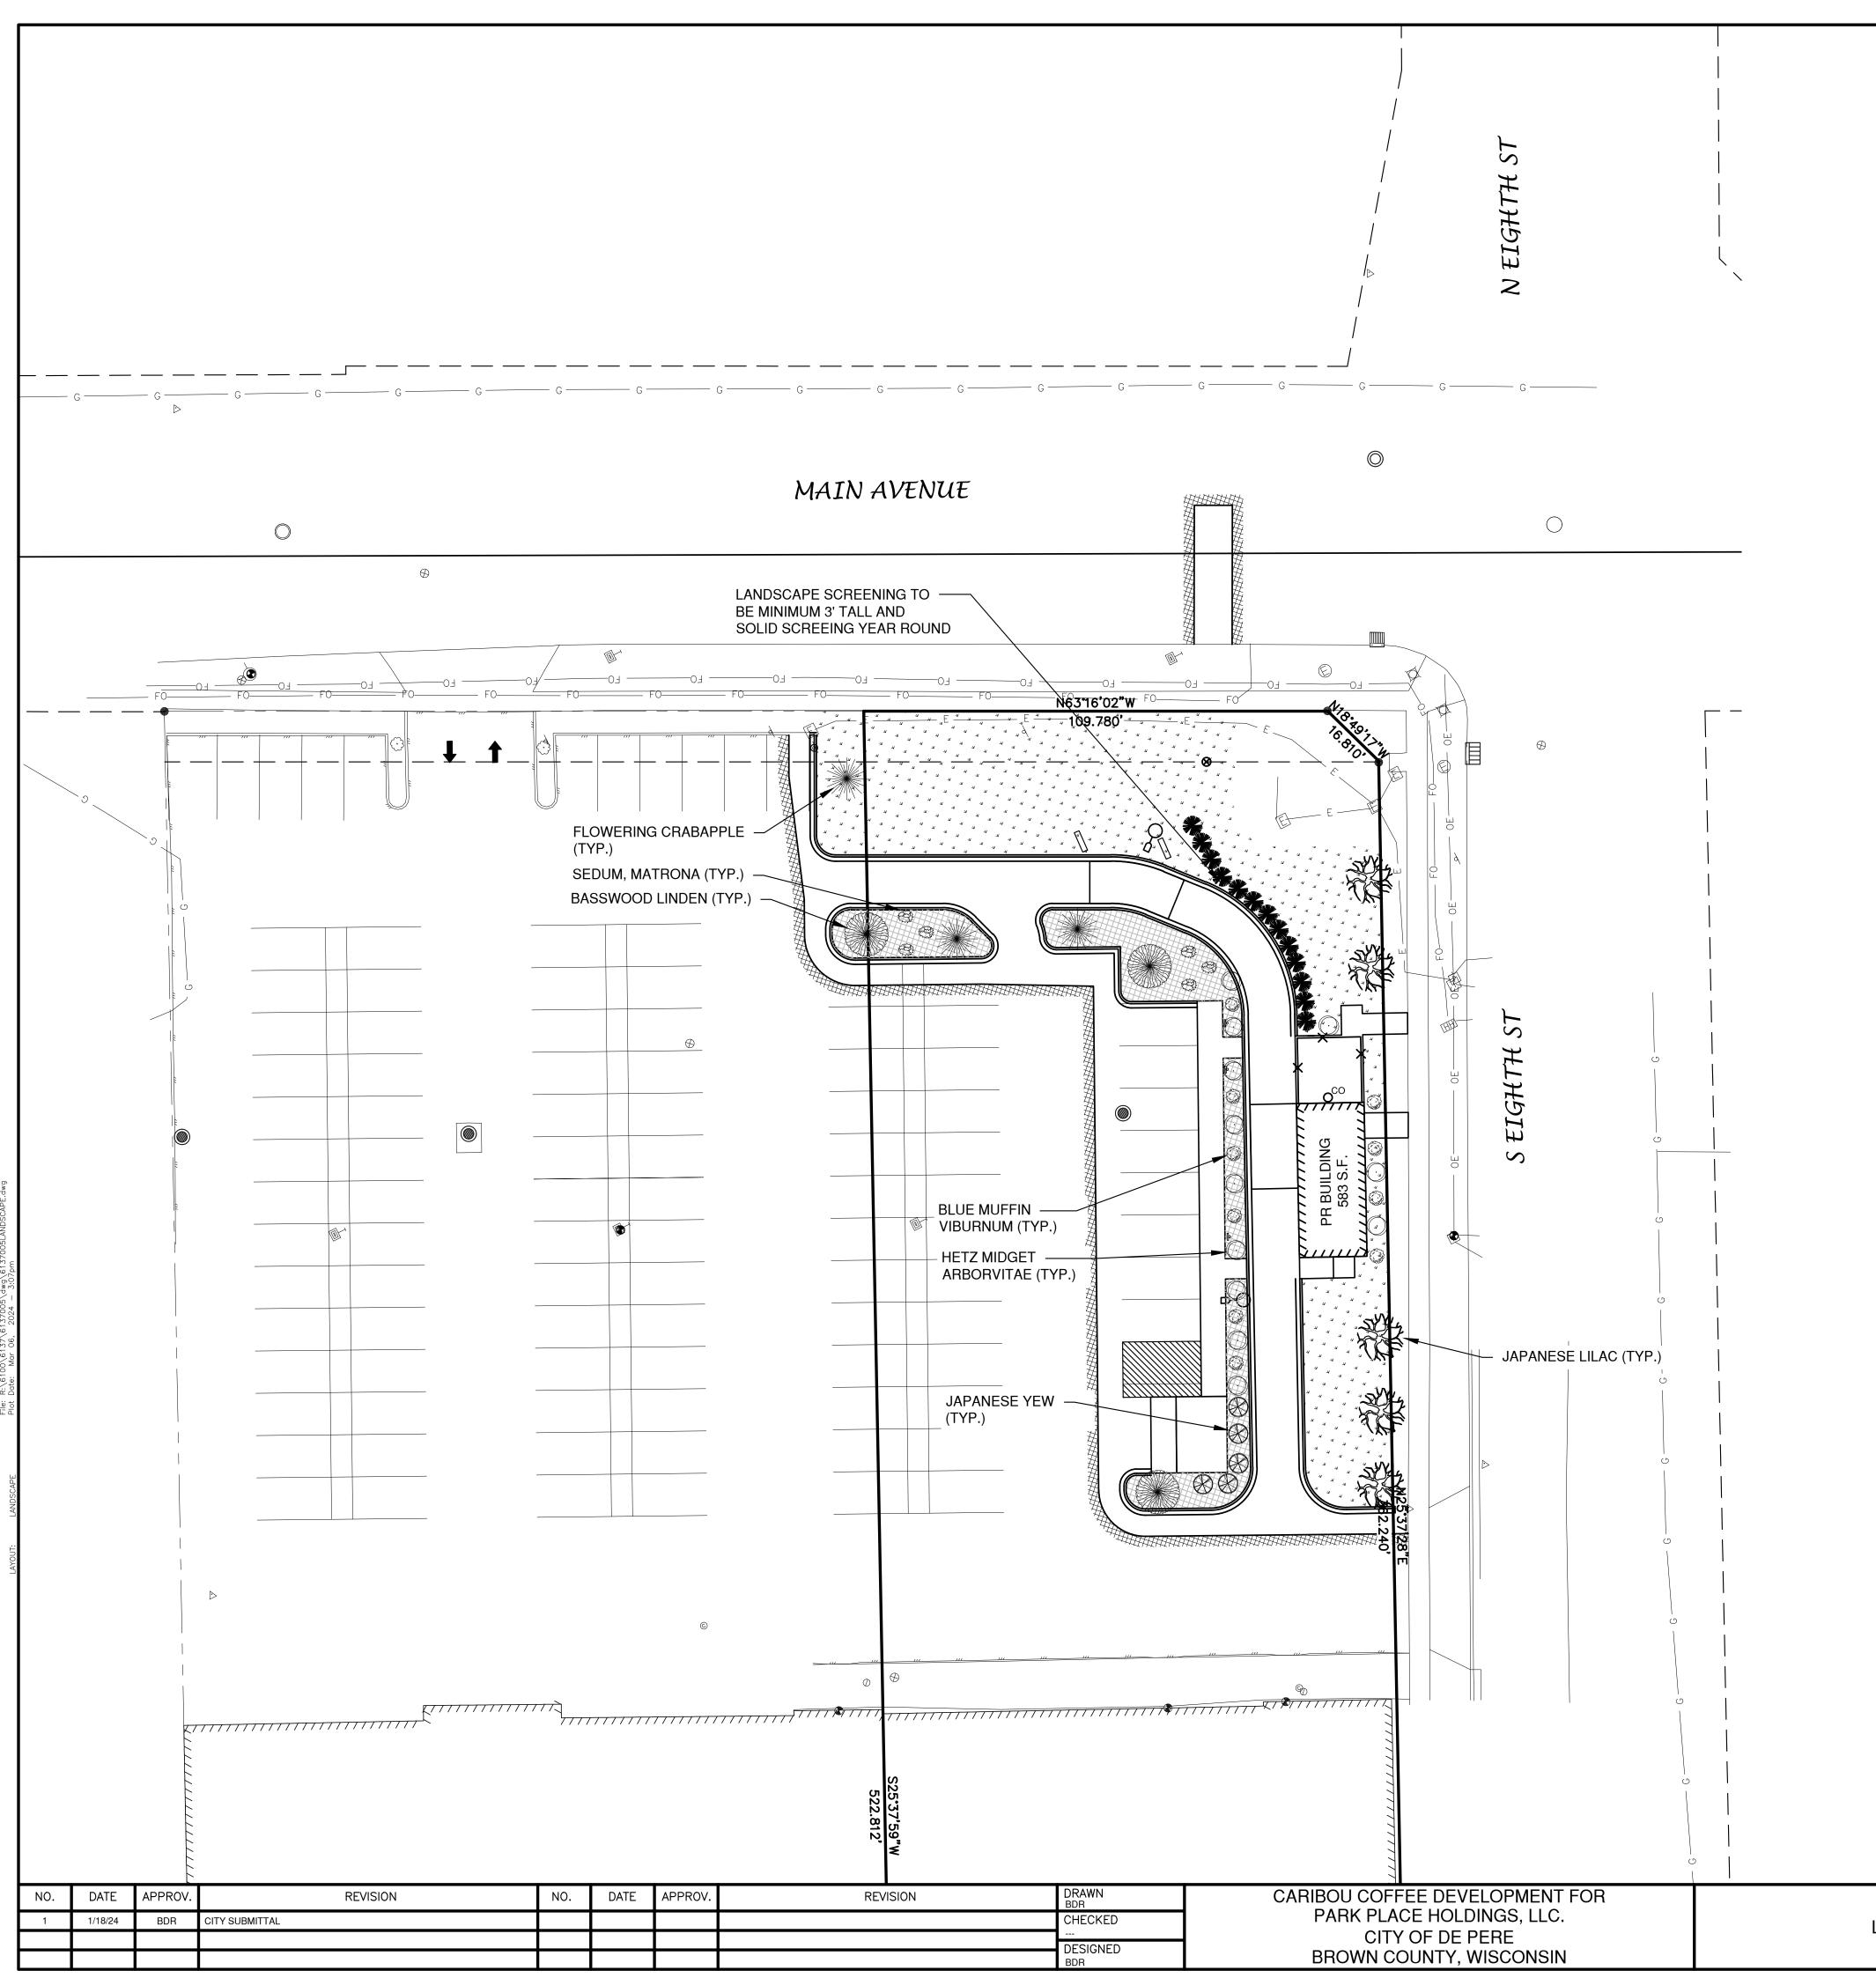

TREE LEGEND

SYMBOL	COMMON NAME	LATIN NAME	PLANT SIZE	QUANTITY
	JAPANESE TREE, IVORY SILK LILAC	SYRINGA RETICULATA "IVORY SILK"	2" CALIPER	5
	BASSWOOD LINDEN	TILIA AMERICANA	6' TALL	3
	FLOWERING CRABAPPLES	MALUS	2" CALIPER	3


SHRUBS LEGEND


SYMBOL	COMMON NAME	LATIN NAME	PLANT SIZE	QUANTITY
	BLUE MUFFIN VIBURNUM	VIBURNUM DENTATUM 'CHRISTOM'	5 GAL.	11
· ·	HETZ MIDGET ARBORVITAE	THU JA OCCIDENTALIS 'HETZ MIDGET'	5 GAL.	12
	JAPANESE YEW	TAXUS CUSPIDATA	5 GAL.	5
	SEDUM, MATRONA	SEDUM 'MATRONA'	1 GAL.	6
	BOXWOOD	BOXUS	3' HEIGHT	13

TREE / PLANTING MAINTENANCE

MAINTAIN TREES AND PLANTINGS BY PRUNING, CULTIVATING, WATERING, WEEDING, FERTILIZING, RESTORING PLANTING SAUCERS, ADJUSTING AND REPAIRING, AND RESETTING TO PROPER GRADES OR VERTICAL POSITION, AS REQUIRED TO ESTABLISH HEALTH, VIABLE PLANTINGS. SPRAY OR TREAT AS REQUIRED TO KEEP TREES AND SHRUBS FREE OF INSECTS AND DISEASE.

AFTER LANDSCAPING IS INSTALLED, LANDSCAPER TO PROVIDE A STATEMENT TO THE CITY OF DE PERE THAT VERIFIES THAT ALL LANDSCAPING HAS BEEN INSTALLED ACCORDING TO THE APPROVED LANDSCAPING PLAN.

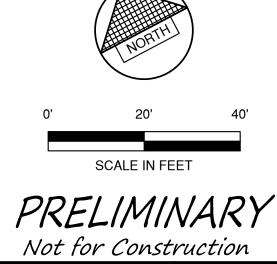

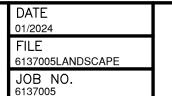




TYPICAL PLANTING, GUYING AND

SPIKING EVERGREEN TREE DETAIL

NOTE: PRUNE 20% OF BRANCHES OF DECIDUOUS SHRUBS ONLY. RETAINING NORMAL PLANT SHAPE.

SHRUB SHALL BEAR SAME RELATION TO FINISH GRADE AS IN NURSERY.

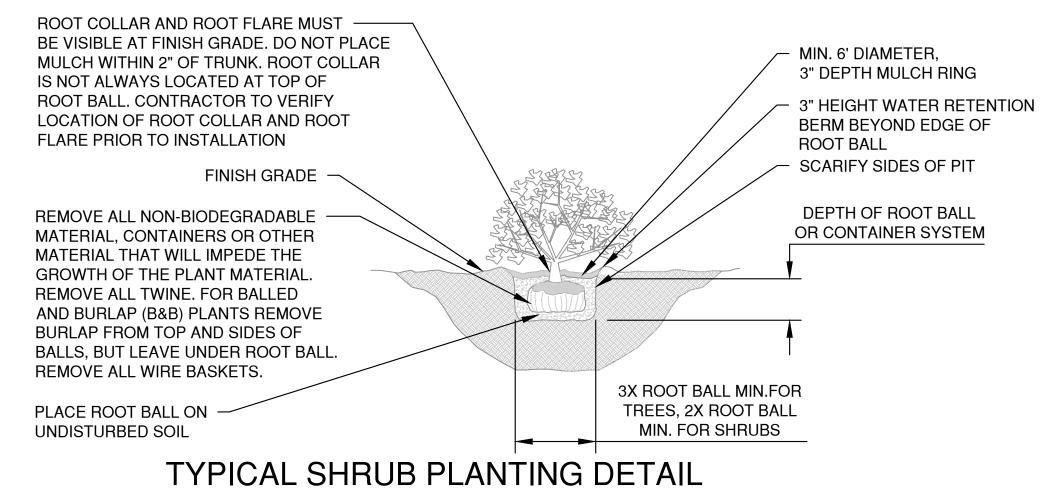

ITPICAL SHOOD PLANTING DETA

PRELIMINARY
Not for Construction

NO. DATE APPROV. REVISION NO. DATE APPROV. REVISION BDR

1 1/18/24 BDR CITY SUBMITTAL CHECKED
--DESIGNED BDR

DRAWN BDR

CHECKED
--DESIGNED BDR


CARIBOU COFFEE DEVELOPMENT FOR
PARK PLACE HOLDINGS, LLC.
CITY OF DE PERE
BROWN COUNTY, WISCONSIN

LANDSCAPE DETAIL

FILE
6137005LANDSCAPE

JOB NO.
6137005



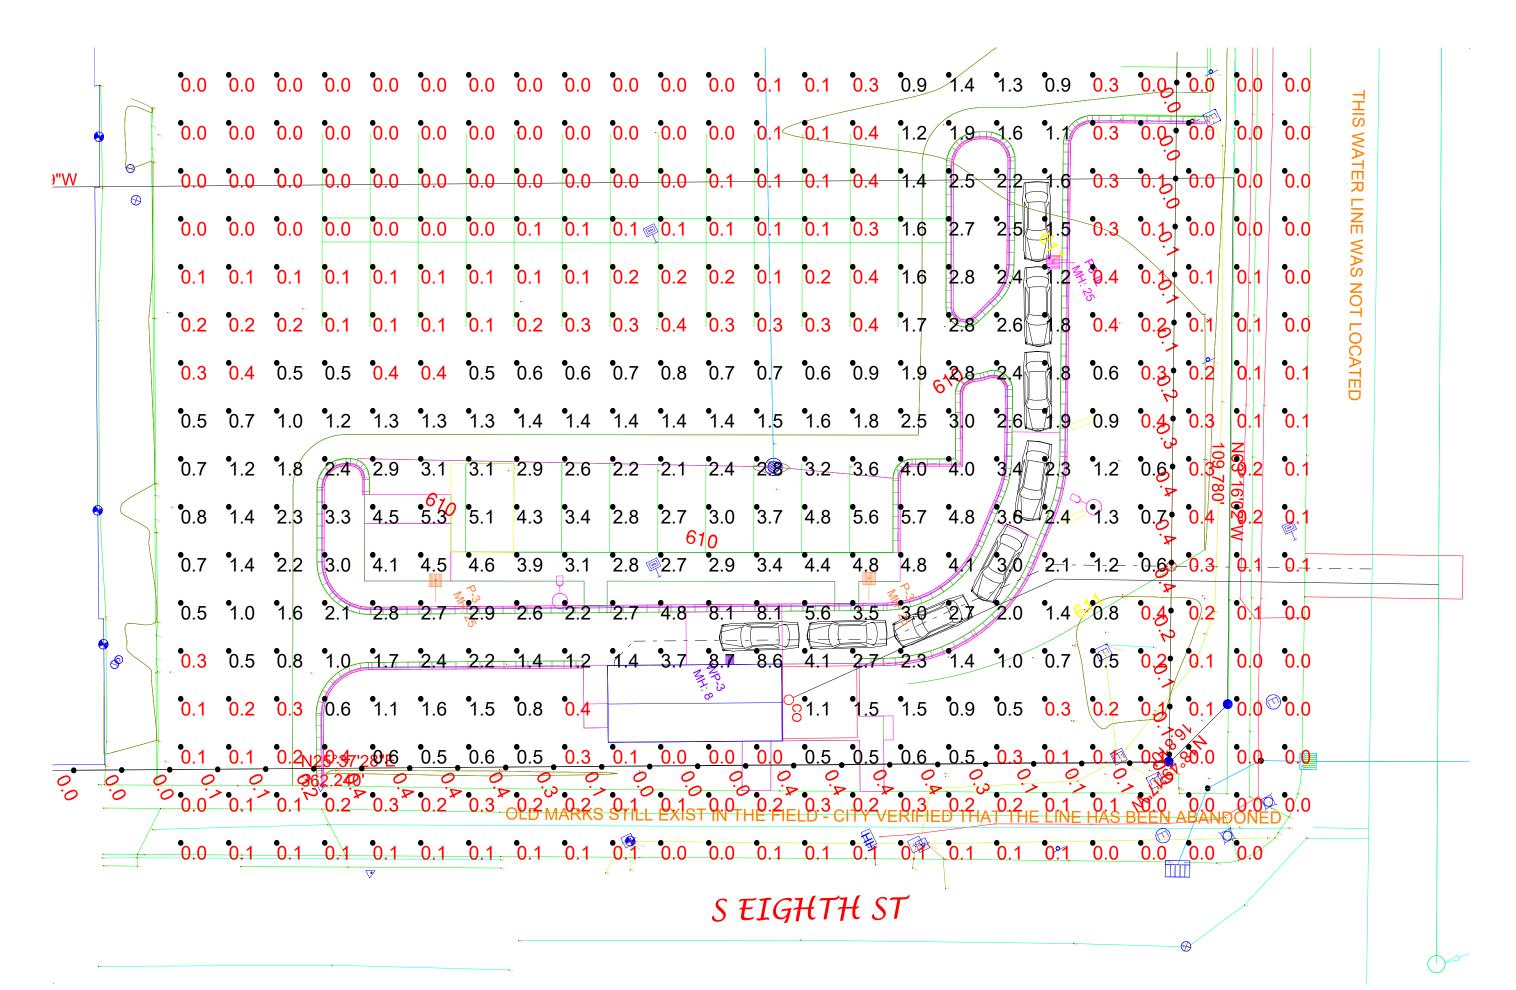

Scale: 1 inch= 20 Ft.

Luminaire Schedule												
Symbol	Qty	Label	Arrangement	Lum. Lumens	LLF	Description	Lum. Watts	Arr. Watts	Total Watts	Tag		
_	1	P3-IL	Single	8638	0.900	MRS-LED-12L-SIL-3-40-70CRI-IL	86	86	86	MH = 25FT		
	2	P-3	Single	18417	0.900	MRS-LED-18L-SIL-3-40-70CRI	135	135	270	MH = 25FT		
	1	WP-3	Single	5179	0.900	XWS-LED-05L-SIL-3-40-70CRI	35	35	35	MH=8FT		

Calculation Summary									
Label	CalcType	Units	Avg	Max	Min	Avg/Min	Max/Min		
CalcPts_1	Illuminance	Fc	1.06	8.7	0.0	N.A.	N.A.		
Prop Line	Illuminance	Fc	0.18	0.4	0.0	N.A.	N.A.		

After exterior lighting is installed, lighting contractor to provide a statement to the City of De Pere that the light spill from the property does not exceed the approved photometric plan.

These drawings are for conceptual use only and are not intended for construction. Fixture runs and quantities should be verified prior to order. Values represented are an approximation generated from manufacturers photometric inhouse or independent lab tests with data supplied by lamp manufacturers.



	Drawn By: KF	Sales Agent:	Date:3/6/2024	Scale: 1" = 4'
	Drawn By: KF	Sales Agent:	Date:3/6/2024	Scale: 1" = 4'


Coffe

aribou

C

⋝

DePere

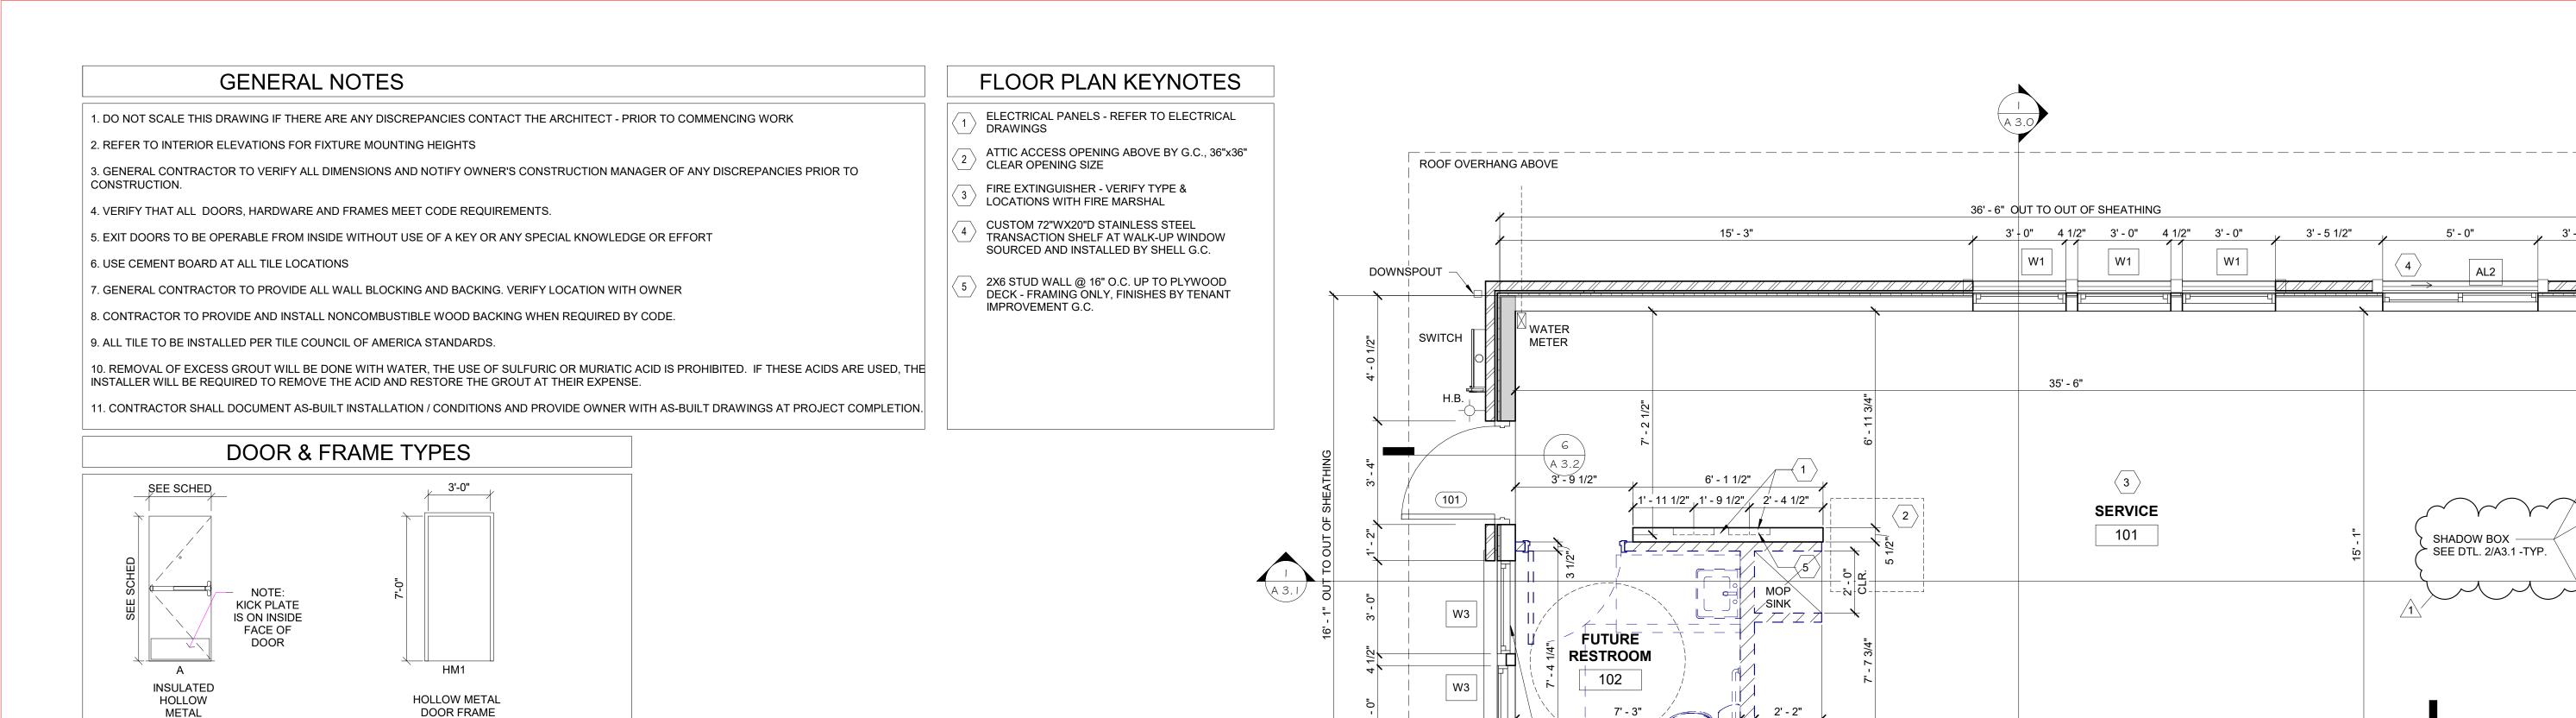

DOWNSPOUT

CORD. LOCATION FOR

ACCESS PANEL FOR

GAS SHUT-OFF



HDWE RATING

REMARKS

DOOR & FRAME

DOOR SCHEDULE

TYPE | FIN. | TYPE | FIN. | GROUP

A PT HM1 PT A

SERVICE DOOR


101 3'-0"x7'-0"X1 3/4"


DOOR

SIZE

DOOR

NUMBER

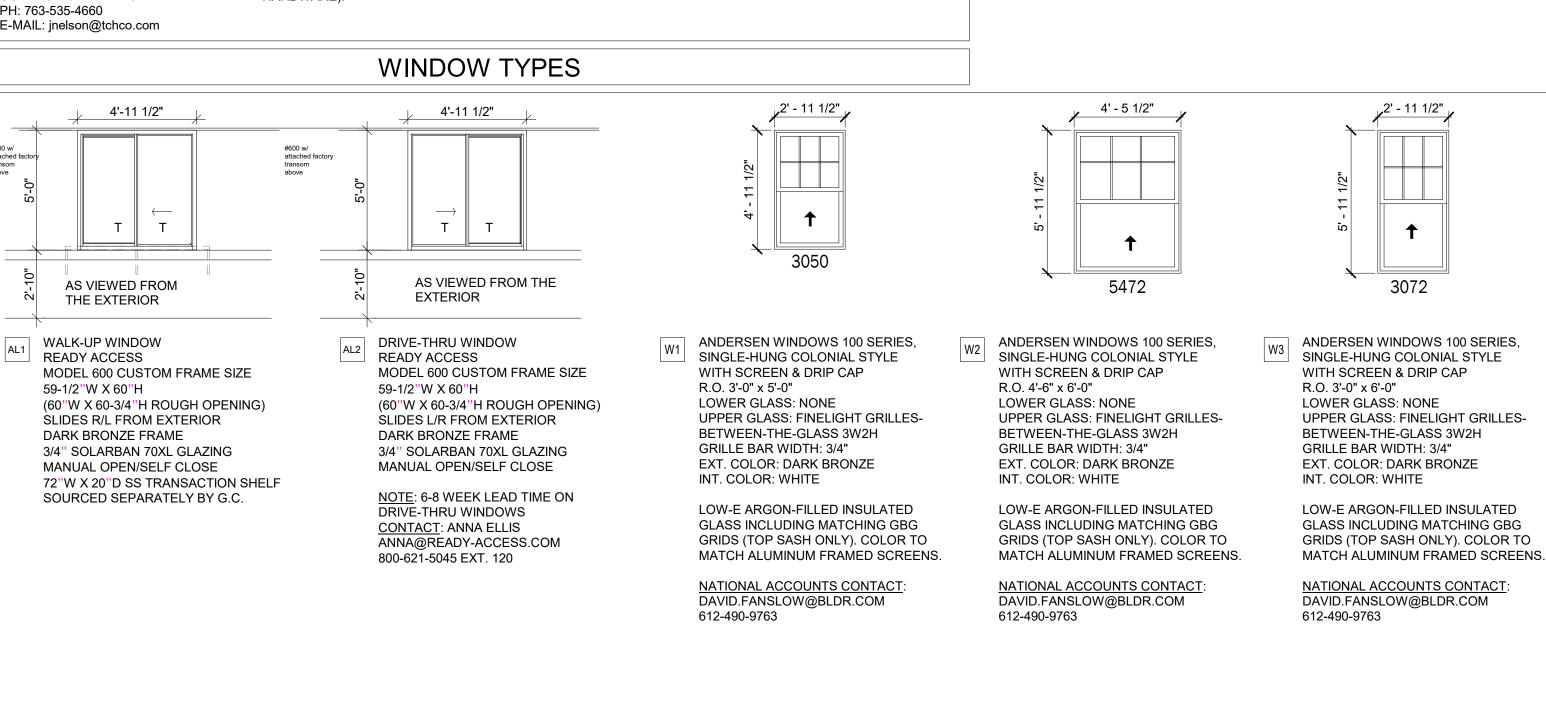

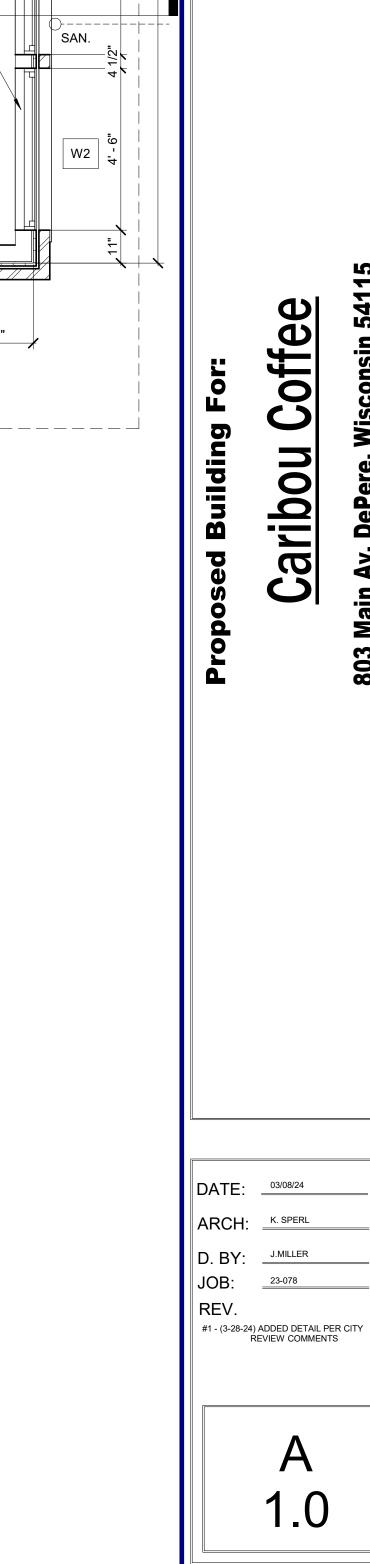


W2

3' - 5 1/2"

A 3.4/


WEST ELEVATION

Scale: 1/4" = 1'-0"

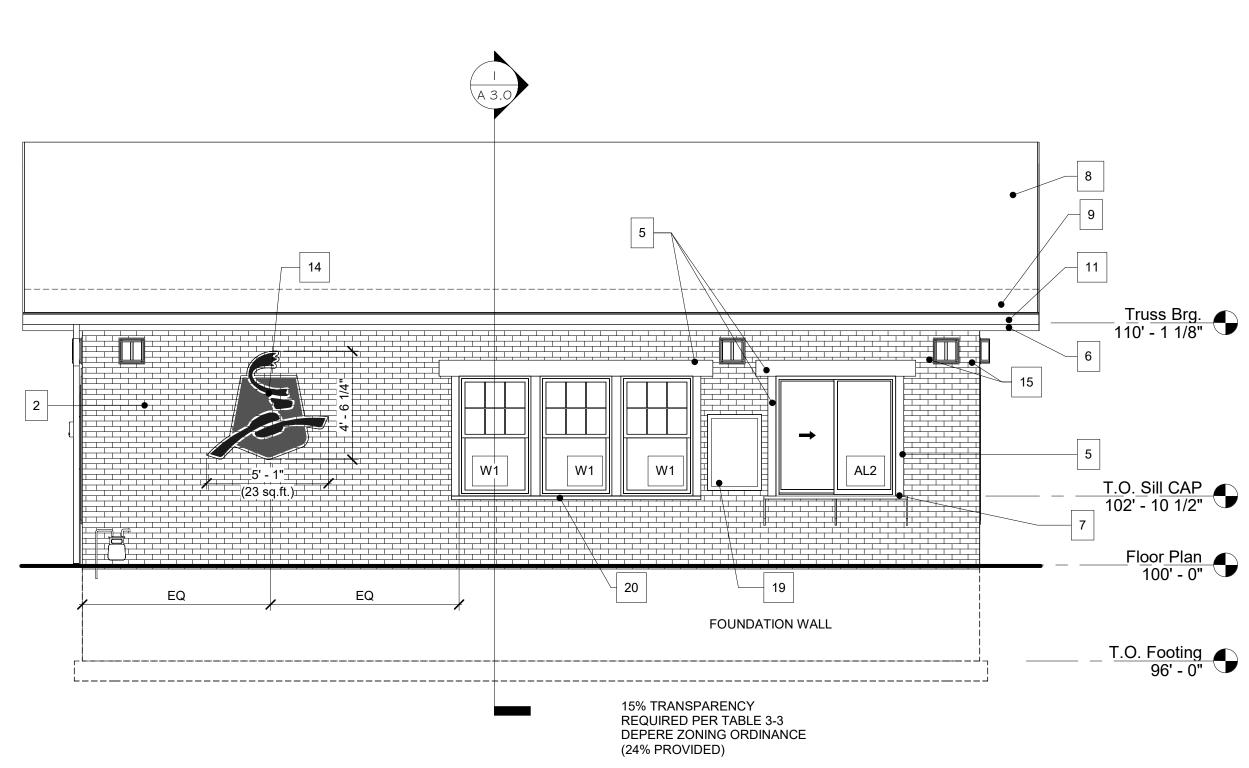


EAST ELEVATION

Scale: 1/4" = 1'-0"

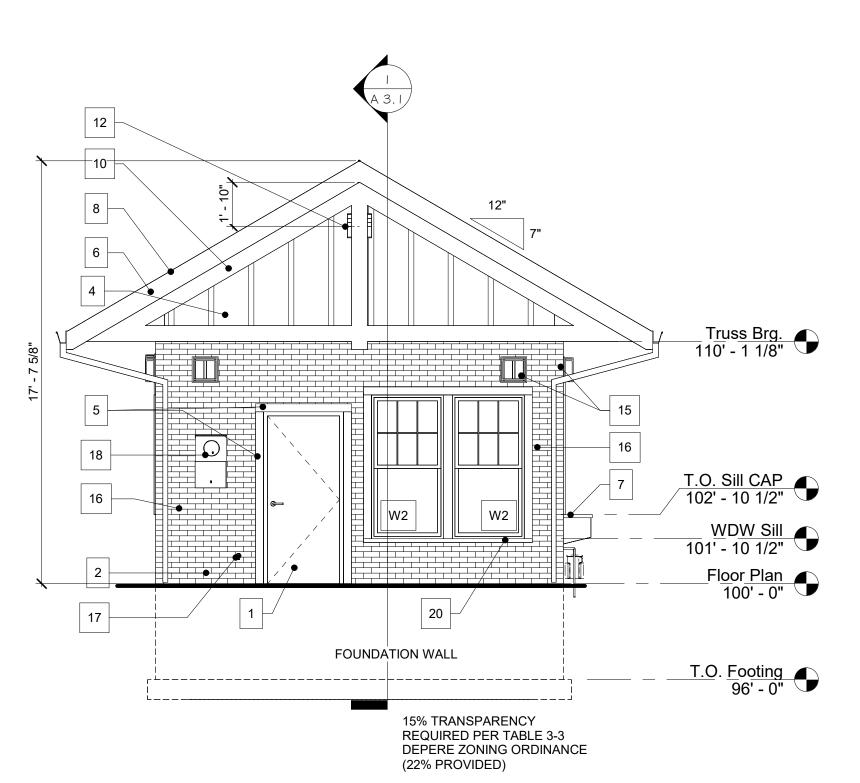

SOUTH ELEVATION

Scale: 1/4" = 1'-0"

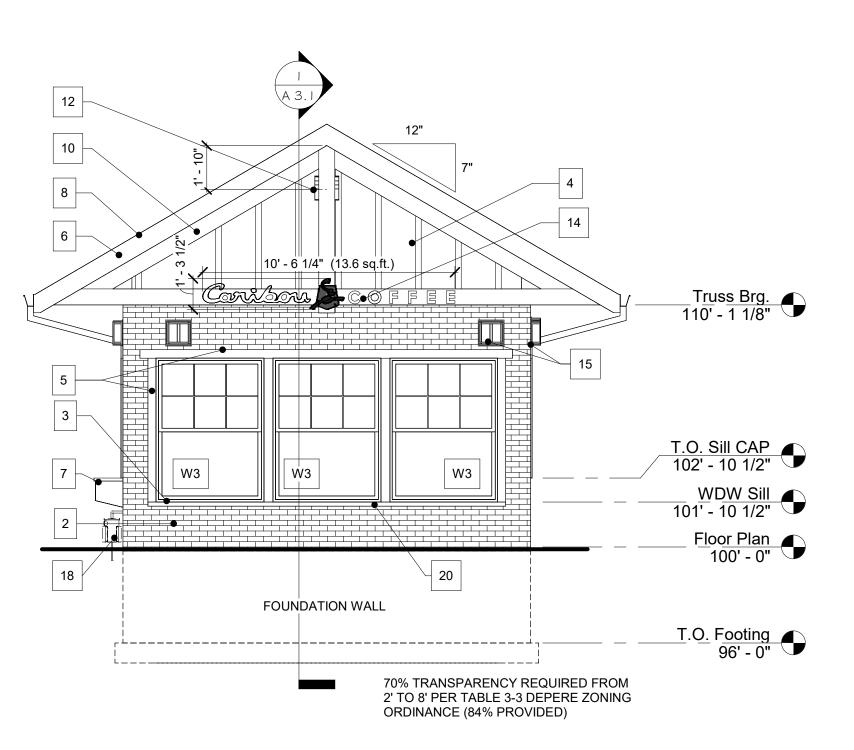

NORTH ELEVATION

Scale: 1/4" = 1'-0"

KEY NOTES

- INSULATED, PRE-FINISHED HM DOOR & FRAME COLOR: BENJAMIN MOORE: BITTERSWEET CHOCOLATE 2114-10. SEALANT AROUND FRAME: MASTERSEAL: SPECIAL BRONZE 259N (TO MATCH ADJACENT SIDING)
- STANDARD BRICK PAINTED BENJAMIN MOORE WHITE DOVE OC-17
- PREFINISHED METAL FLASHING COLOR TO MATCH ADJACENT STONE SILL CAP / DRIP LEDGE: EXCEPTIONAL METALS CHARCOAL GRAY OR FIRESTONE UNA-CLAD CHARCOAL GRAY
- COMPOSITE BOARD AND BATTEN STYLE: CEDARMILL COLOR: PRE-FINISHED (REQ'D, NO EXCEPTIONS) TO MATCH SHERWIN WILLIAMS PAINT COLOR 'CLOUDBURST' SW6487
- HARDIE TRIM BOARDS: 1x8, 1x6 & 1x4 STYLE: 4/4 RUSTIC. COLOR: PRE-FINISHED (REQ'D, NO EXCEPTIONS) TO MATCH BENJAMIN MOORE PAINT COLOR 2124-10 Wrought Iron 2114-10 ALTERNATE: LP SMARTSIDE TRIM BOARDS, CEDAR TEXTURE. SEE PRE-FINISHING NOTES FOR MORE INFORMATION.
- HARDIE TRIM FASCIA BOARDS: 1X10 STYLE: 4/4 RUSTIC. COLOR: PRE-FINISHED (REQ'D, NO EXCEPTIONS) TO MATCH BENJAMIN MOORE PAINT COLOR 2124-10 Wrought Iron 2114-10 ALTERNATE: LP SMARTSIDE FASCIA BOARDS, CEDAR TEXTURE. SEE PRE-FINISHING NOTES FOR MORE INFORMATION.
- STAINLESS STEEL TRANSACTION SHELF. SEE WINDOW TYPES ON A-100. NOTE: SHELF TO BE SOURCED AND INSTALLED BY G.C. SEE 1/A-304 FOR WALL DETAILS
- STANDING SEAM METAL ROOFING WITH RIDGE VENT: MATCH UNA-CLAD UC-4 SNAP-ON BATTEN ARCHITECTURAL SERIES ROOFING, 16" O.C., 24 GA. GALVANIZED STEEL W/ KYNAR 500 COATING. COLOR: CHARCOAL GRAY. ROOF METAL FLASHING COLOR: CHARCOAL GRAY TO MATCH ROOF
- METAL ROOFING SNOW GUARD: S-5 COLORGARD OR EQUAL. MATCH UNA-CLAD COLOR: CHARCOAL GRAY
- 10 DECORATIVE END TRUSS: LP SMARTSIDE 540 SERIES CEDAR TEXTURE TRIM, PRE-FINISHED (REQ'D, NO EXCEPTIONS) TO MATCH BENJAMIN MOORE PAINT COLOR 2124-10 Wrought Iron 2114-10 (SEE 1/A3.3 FOR DETAILS)
- 11 5" PRE-FINISHED METAL GUTTERS WITH 4"x4" OPEN-FACED DOWNSPOUT SYSTEM. 8'-6" CLEAR HEIGHT REQUIRED AT DOWNSPOUT CONNECTION. COLOR TO BE CHARCOAL GRAY TO MATCH STANDING SEAM ROOF. PROVIDE CONNECTION TO STORM SEWER SYSTEM AT DOWNSPOUTS -SEE CIVIL DRAWINGS FOR MORE INFORMATION. PROVIDE HEAT TAPE -SEE ELECTRICAL DRAWINGS FOR MORE INFORMATION.
- 12 INTAKE LOUVER AT GABLE END WALL. VERIFY SIZE WITH MEP. PAINT BENJAMIN MOORE PAINT COLOR 2124-10 Wrought Iron 2114-10. -SEE MECHANICAL DRAWINGS FOR MORE INFORMATION.
- WINDOW FILM WITH 'BOLD NORTH' DESIGN. SUPPLIED BY ARCHETYPE AND INSTALLED BY TENANT IMPROVEMENT G.C. CONTACT: JENNY KRUSE PHONE: 952-641-9602 EMAIL: JENNYK@ARCHETYPESIGN.COM PROJECTMANAGER@ARCHETYPESIGN.COM
- 14 ILLUMINATED CARIBOU SIGNAGE N.I.C. SUPPLIED AND INSTALLED BY SIGN VENDOR. PROVIDE ELECTRICAL AS SHOWN ON ELECTRICAL PLANS. G.C. TO VERIFY DESIGN, DIMENSIONS, BRACKET INSTALLATION REQUIREMENTS, AND ELECTRICAL REQUIREMENTS WITH SIGN VENDOR PRIOR TO ROOFING INSTALL.
- 15 LIGHT FIXTURES SEE ELECTRICAL PLANS INSTALL WALL SCONCES ON 4/4 SMOOTH HARDIE TRIM BOARD MOUNTING PLATE PAINTED BENJAMIN MOORE PAINT COLOR 2124-10 Wrought Iron 2114-10. SEE PRE-FINISHING NOTES FOR MORE INFORMATION. INSTALL EM PACK ABOVE REAR DOOR BEHIND DECORATIVE TRUSS.
- 16 5" PRE-FINISHED METAL GUTTERS WITH 4"x4" OPEN-FACED DOWNSPOUT SYSTEM. 8'-6" CLEAR HEIGHT REQUIRED AT DOWNSPOUT CONNECTION. COLOR TO BE CHARCOAL GRAY TO MATCH STANDING SEAM ROOF. PROVIDE CONNECTION TO STORM SEWER SYSTEM AT DOWNSPOUTS - SEE CIVIL DRAWINGS FOR MORE INFORMATION. PROVIDE HEAT TAPE - SEE ELECTRICAL DRAWINGS FOR MORE INFORMATION.
- 17 EXTERIOR HOSE-BIBB SEE PLUMBING PLANS FOR MORE INFORMATION
- 18 FIELD VERIFY AND COORDINATE LOCATION OF EXTERIOR ELECTRICAL AND OTHER UTILITY SERVICE EQUIPMENT WITH SITE CONDITIONS AND OTHER SITE AND BUILDING EQUIPMENT (I.E. ROOF DRAINAGE AND DOWNSPOUTS, ETC.) SEE MECHANICAL, ELECTRICAL AND PLUMBING PLANS FOR MORE INFORMATION
- 19 27"x38 WALK-UP MENU BOARD (PROVIDED BY CARIBOU, INSTALLED BY TENANT IMPROVEMENT G.C., VERIFY SIZE) -COORDINATE WITH OWNER PRIOR TO SIDING INSTALL.
- 20 CULTURED STONE SILL CAP

APPROVAL BY OWNER & ARCHITECT.

PRE-FINISHING NOTES

FOR KEYNOTE 5 & 6 (HARDIE TRIM BOARD MOUNTING PLATE, HARDIE TRIM BOARDS, & HARDIE TRIM FASCIA BOARDS: IF PRE-FINISHED BY FACTORY USE JAMES HARDIE SPEC DREAM COLLECTION, BLACK FIG. IF PRE-FINISHED IN SHOP BEFORE ARRIVING ON SITE USE BENJAMIN MOORE 2124-10 WROUGHT IRON. IF USING SHERWIN- WILLIAMS, MUST MATCH BM 2124-10 Wrought Iron.

FOR KEYNOTE 4 (HARDIE PLANK LAP SIDING OR VERTICAL PANEL SIDING): IF PRE-FINISHED BY FACTORY- USE JAMES HARDIE SPEC DREAM COLLECTION, COLONIAL BLUE. IF PRE-FINISHED IN SHOP BEFORE ARRIVING ON SITE, USE BENJAMIN MOORE TO MATCH SHERWIN-WILLIAMS PAINT COLOR 'CLOUDBURST' SW6487.

SUBMIT SAMPLES AND COLOR CHARTS FOR ALL BUILDING FINISHES. COLORS & FINISHES INCLUDING ROOFING, SIDING, TRIM AND CULTURED


ARE SUBJECT TO CHANGE PENDING LEAD TIMES AND FINAL REVIEW AND

offee 9 a

DATE: _______ ARCH: K. SPERL

D. BY: J.MILLER JOB: REV.

A

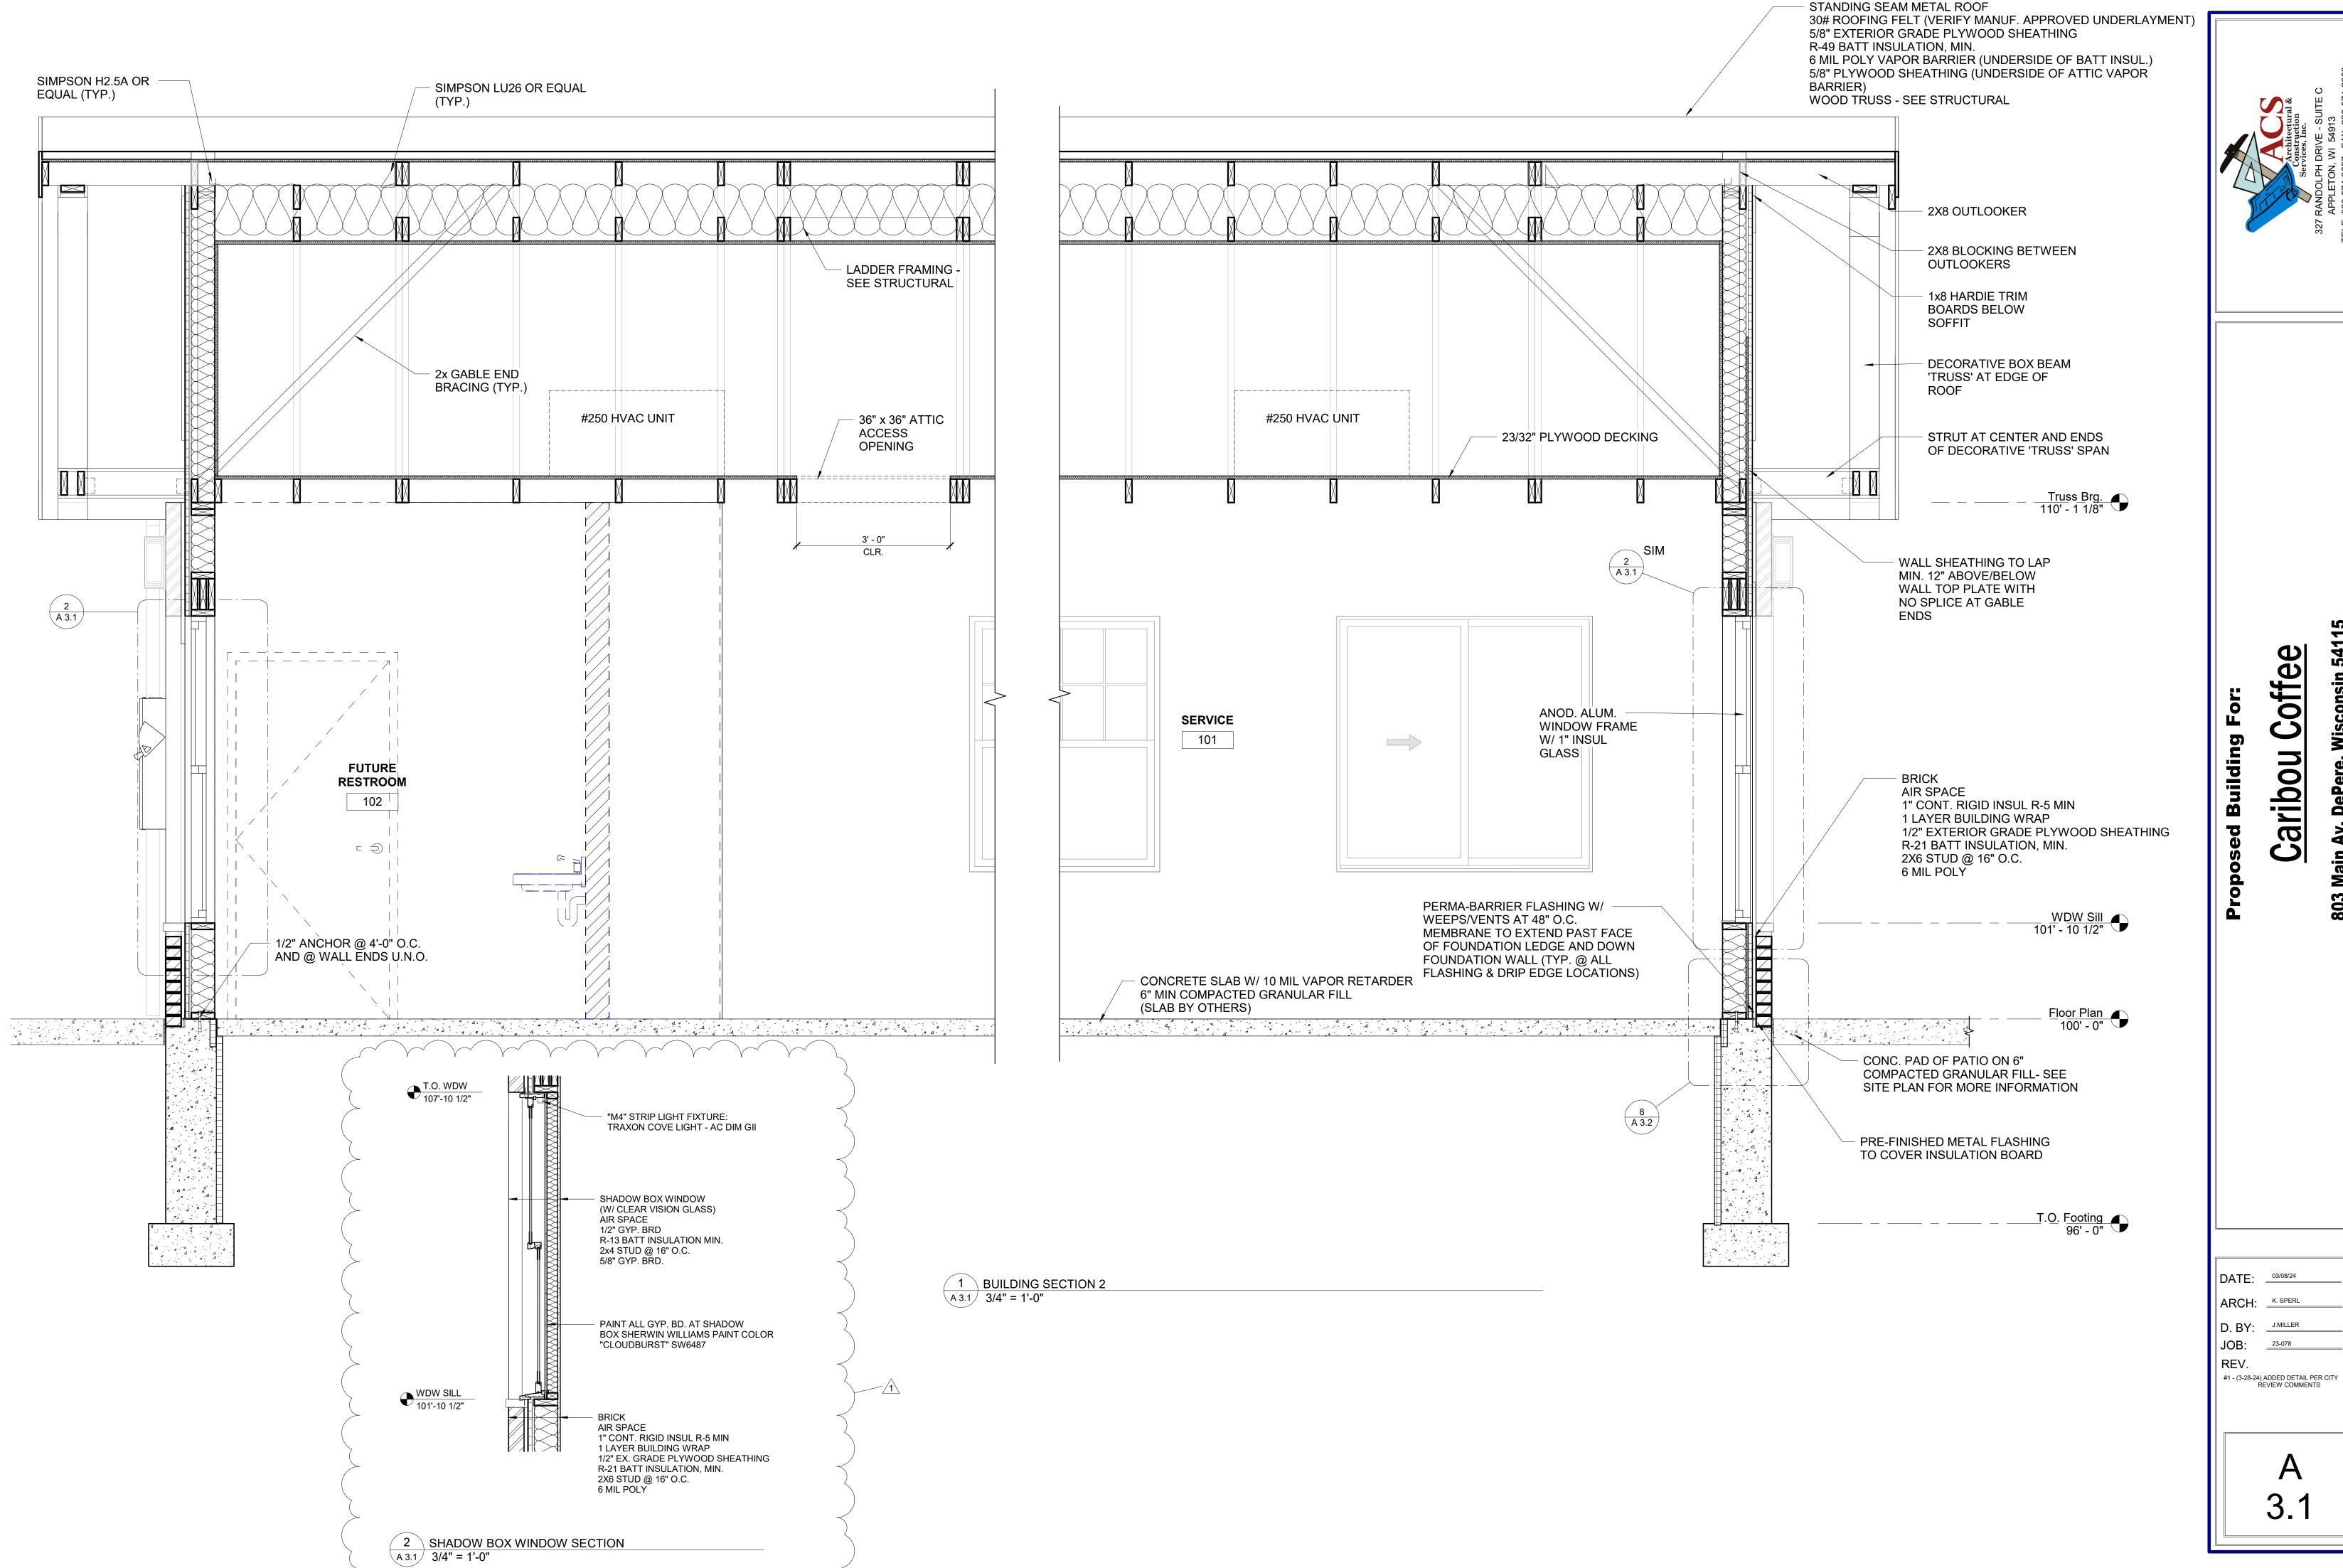

2902.2 SEPARATE FACILITIES, EXCEPTION 2: SEPARATE FACILITIES SHALL NOT BE REQUIRED IN STRUCTURES OR TENANT SPACES WITH A TOTAL OCCUPANT LOAD, INCLUDING EMPLOYEES AND CUSTOMERS, OF 25 OR LESS.

international PLUMBING CODE SECTION 410: WHERE WATER IS SERVED IN RESTAURANTS, DRINKING FOUNTAINS SHALL NOT BE REQUIRED.

DRINKING FOUNTAINS ('B' OCCUPANCY) I per 100 OCC = I DRINKING FOUNTAIN (ALSO SEE 410.1 OF THE INTERNATIONAL PLUMBING CODE,

TUAL FIXTURE COUNT PROVIDED TO SERVE CARIBOU COFFEE SHOP: SINGLE-USE TOILET ROOM: WC. = 1 WC

I SERVICE/MOP SINK WILL BE PROVIDED.


WATER WILL BE SERVED IN THE CARIBOU COFFEE SHOP - NO DRINKING FOUNTAIN WILL BE PROVIDED.

SERVICE SINKS - 1 REQUIRED (OR ALSO SEE TABLE 2902.1 KEYNOTE & FOR BUSINESS & MERCANTILE OCCUPANCIES)

LAV = 1 LAV.

THIS CODE REVIEW AND CODE REVIEW SHELL BUILDING FLOOR PLAN MUST BE REVIEWED, EDITED AND UPDATED BY THE ARCHITECT OR ENGINEER OF RECORD BASED ON PROJECT LOCATION AND STATE.

NOTE: CHECK FOR JURISDICTIONAL RECYCLING SPACE REQUIREMENTS BASED ON PROJECT STATE AND LOCATION.

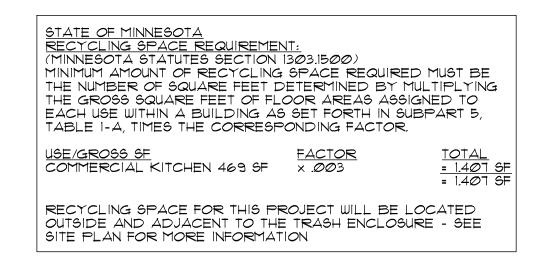


PROVIDE FIRE EXTINGUISHERS PER FIRE MARSHAL REQUIREMENTS. PROVIDE A 4A-20BC (10 LB) PORTABLE FIRE EXTINGUISHER IN KITCHEN AREA.

NOTE: NUMBER OF EXTERIOR SEASONAL PATIO

ALI FOR MORE INFORMATION.

SEATS IS 16. SEE SITE PLAN DRAWINGS A1.0 AND

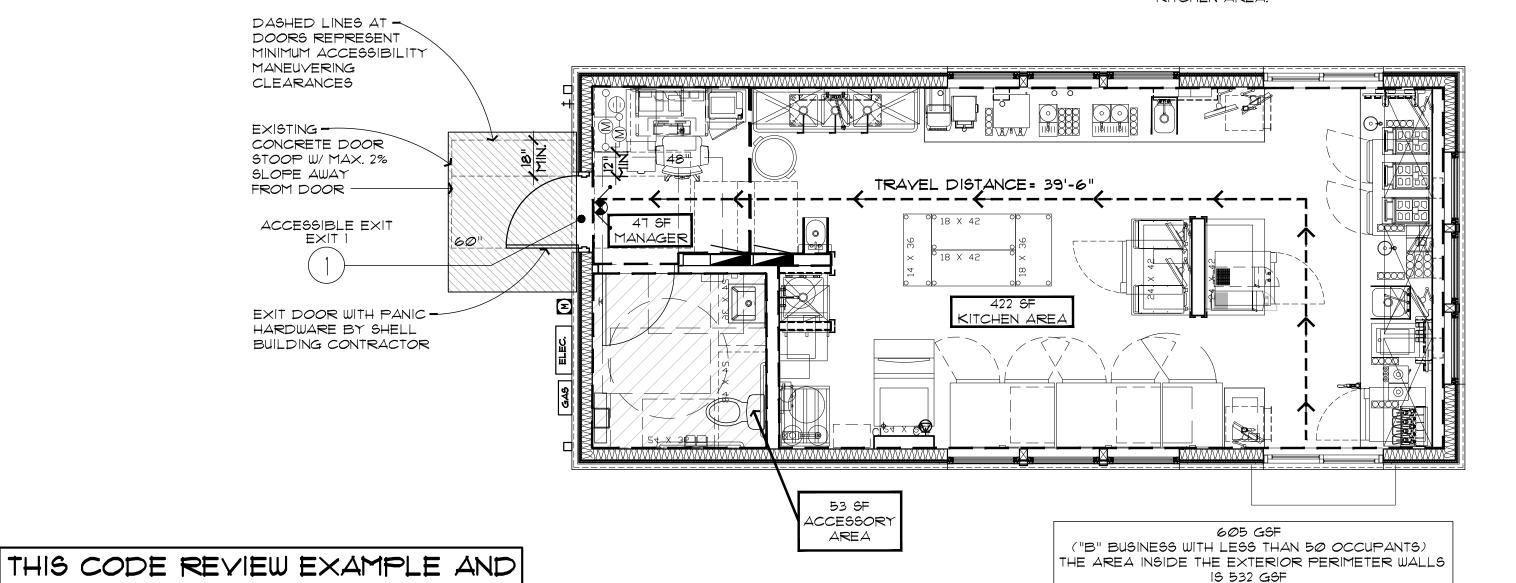

PLAN

NORTH

- FUTURE PATIO AREA -(AS SITE SPACE ALLOWS)

EXAMPLE ARE NOT FOR PERMIT OR CONSTRUCTION. THIS CODE REVIEW EXAMPLE IS BASED ON THE STATE OF MINNESOTA CODES AS OF MARCH 28, 2023. THIS CODE REVIEW MUST BE COMPLETED AND/OR MODIFIED BY A LICENSED ARCHITECT AND ENGINEER TO CONFORM TO ALL LOCAL AND APPLICABLE CODES AND SPECIFIC SITE CONDITIONS. THERE IS NO WARRANTY, WHETHER IMPLIED OR EXPRESSED THAT THIS CODE REVIEW MEETS THE APPLICABLE CODE REQUIREMENTS, LIABILITY FOR THE DESIGN AND ANY USE OF THIS

CODE REVIEW IS THE SOLE

ARCHITECT AND ENGINEER OF

RESPONSIBILITY OF THE

RECORD.

SHELL BUILDING FLOOR PLAN

CODE REVIEW - FLOOR PLAN

PATIO SEATS IS TO BE 16 IF SITE LAYOUT ALLOWS (4 TABLES AND 3 UMBRELLAS). VERIFY FINAL PATIO SEAT COUNT BASED ON SITE CONDITIONS.

OU -TH NUMBER OF

CHITECT / SS AND SP PRESSED LITY FOR TOF THE AF SE COMPLE TO CONFO THERE IS N MEET THE E OF THE DC A D C C Z

ON TC 1 Q Q F 0 FLO CO RU CARIBO DRIVE-DT RIGHT P CITY, STATE DE 0

COFFEE


Caribou Coffee Compan 3900 Lakebreeze Ave N Brooklyn Center, MN 55429

DATE ISSUED 2023 CABIN PROTOTYPE ISSUE 03-28-23

DRAWN BY CHECKED BY PROJECT LOCATION:

CITY, STATE

A0.2 CODE REVIEW

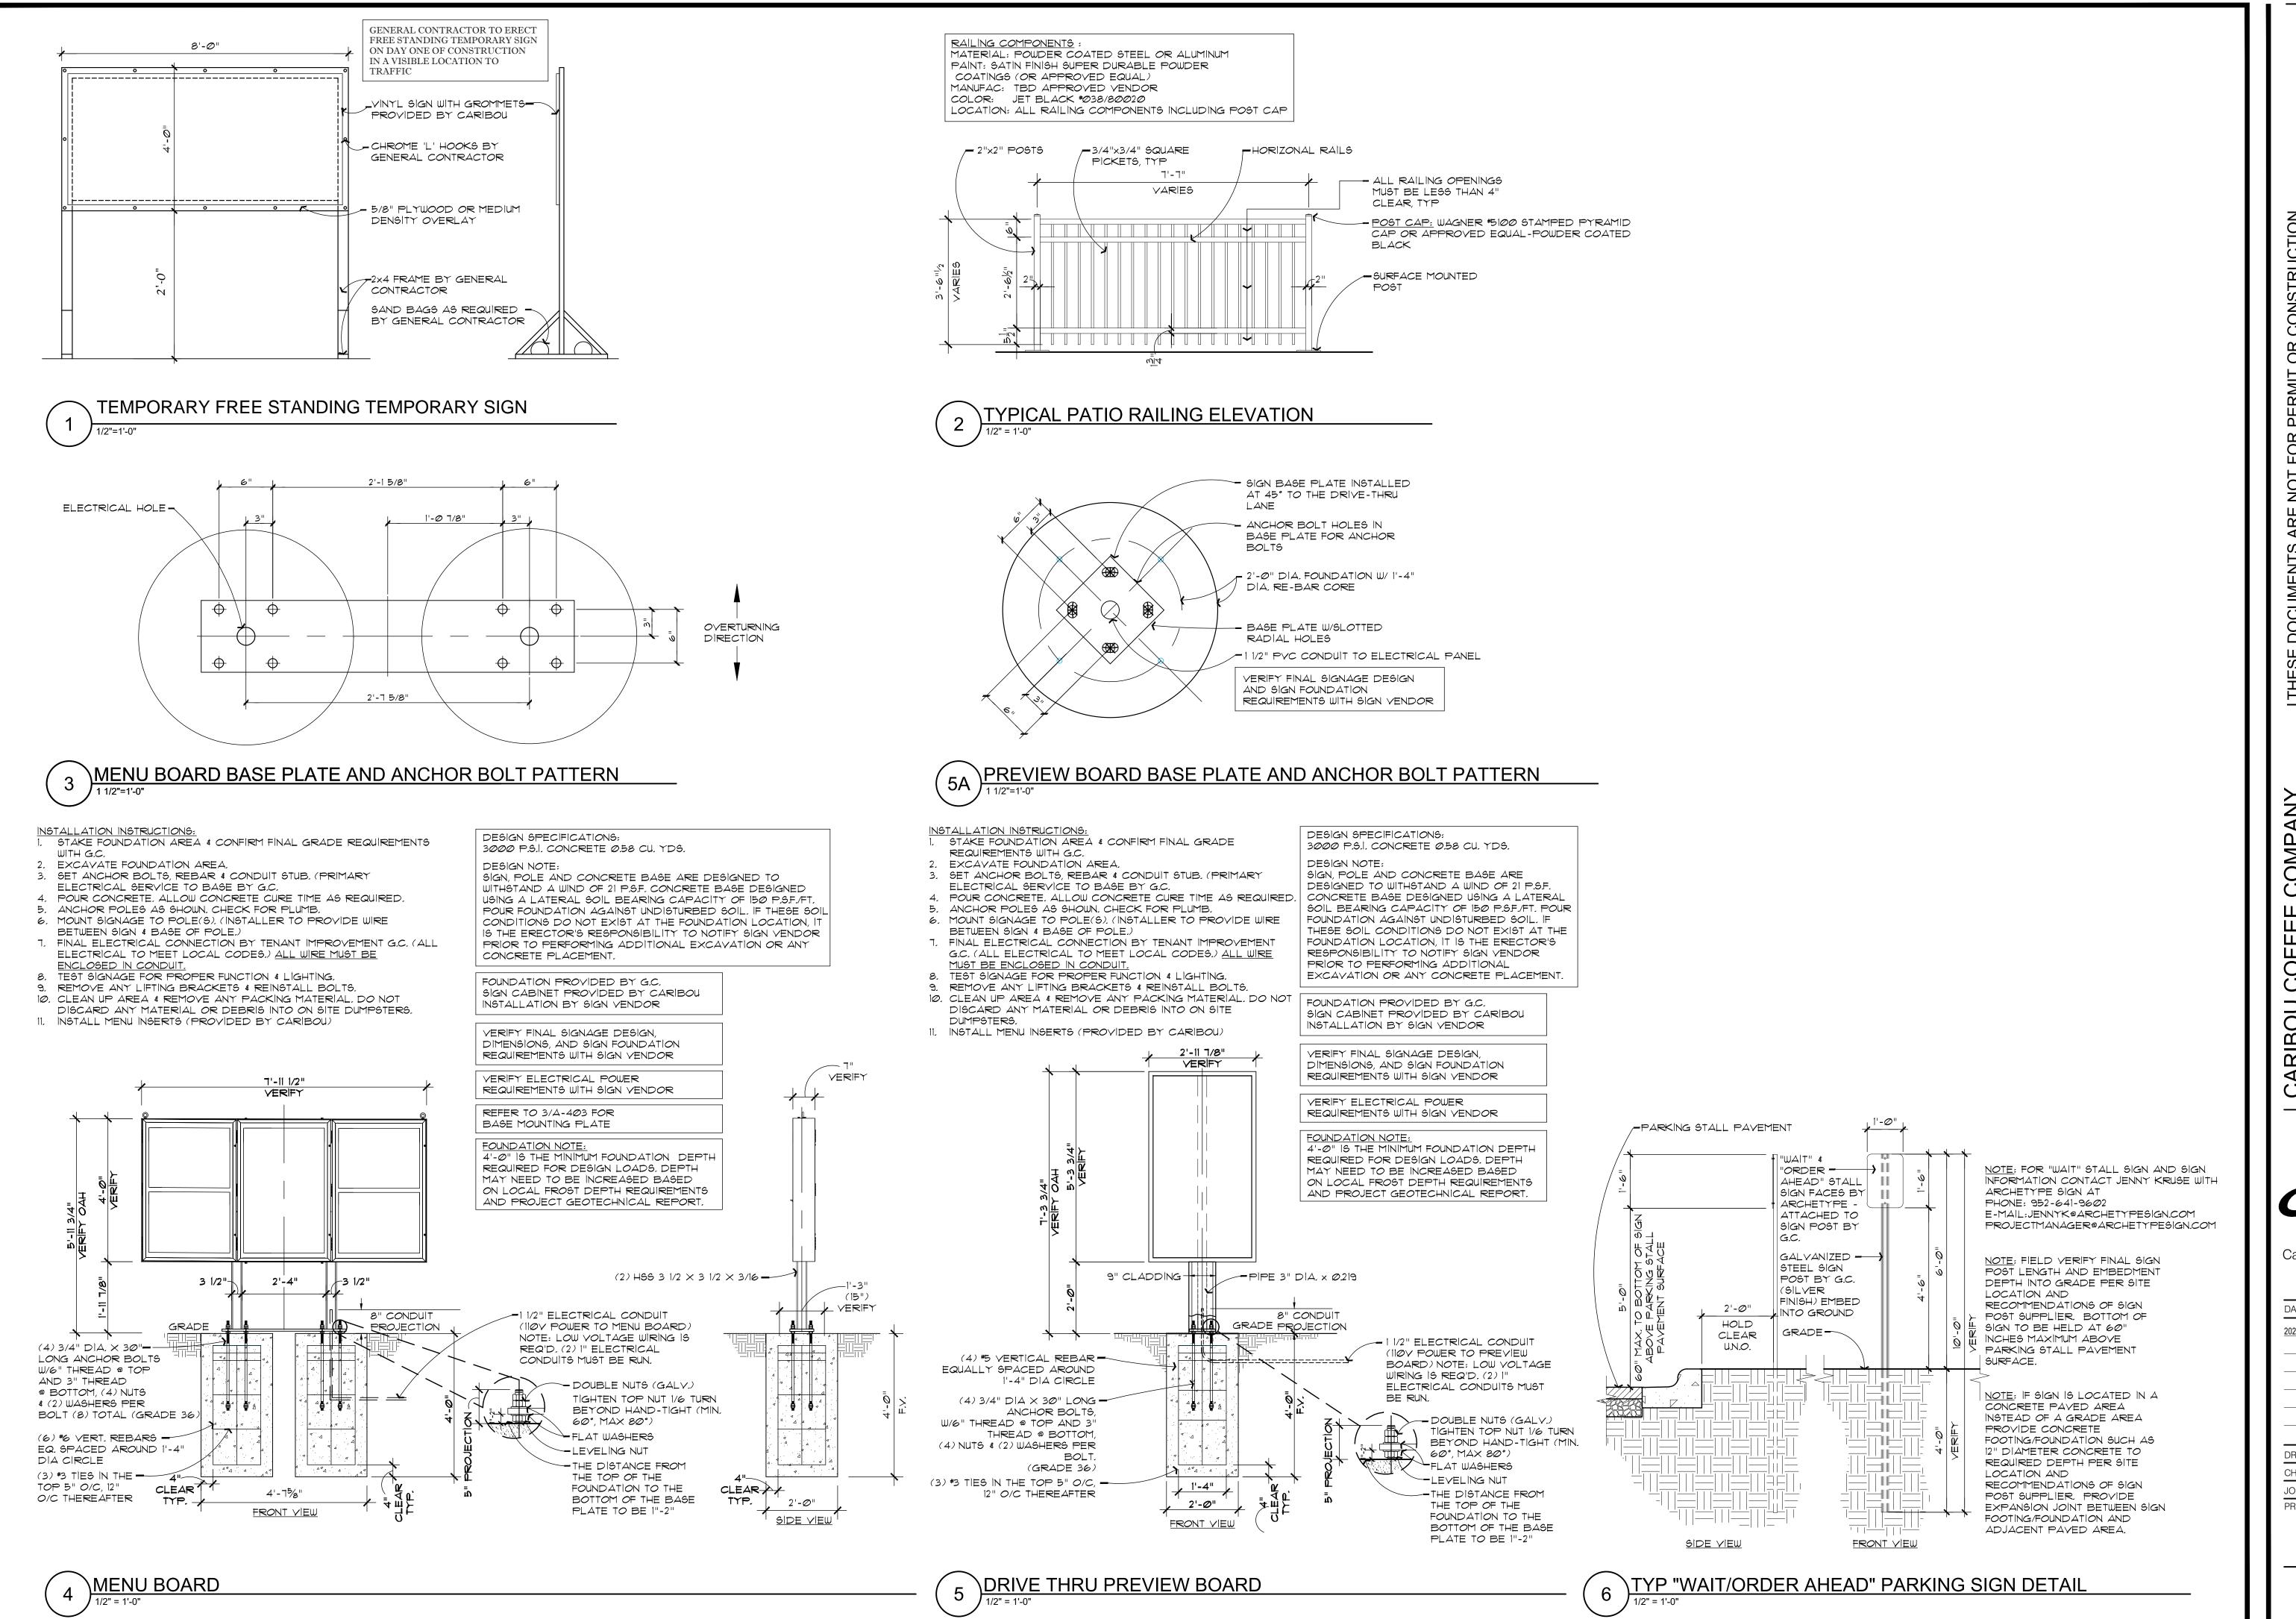

THEY MUST BE COMPLETED AND/OR MODIFIED BY A LICENSED ARCHITECT AND ENGINEERED TO CONFORM TO ALL LOCAL AND APPLICABLE CODES AND SPECIFIC SIT CONDITIONS. THERE IS NO WARRANTY, WHETHER IMPLIED OR EXPRESSED THAT THE DOCUMENTS MEET THE APPLICABLE CODE REQUIREMENTS. LIABILITY FOR THE DESIGNAND ANY USE OF THE DOCUMENTS IS THE SOLE RESPONSIBILITY OF THE ARCHITECT AND ENGINEER OF RECORD.

| CARIBOU COFFEE COMP,
| DRIVE-THRU ONLY STOR | DT RIGHT PROTOTYPE SHELL BUILDING CITY, STATE

Caribor

Caribou Coffee Company 3900 Lakebreeze Ave N Brooklyn Center, MN 55429

DATE ISSUED

2023 CABIN PROTOTYPE ISSUE 03-28-

2023 CABIN PROTOTYPE ISSUE 03-28-23

DRAWN BY

CHECKED BY

JOB NO. 2

PROJECT LOCATION:

CITY, STATE

A-403