

Planning/Zoning Application

Submitted On:

Nov 10, 2025, 06:03PM EST

Planning & Zoning Department

wd-864
Street Address: 665 W Grant St City: De Pere State: WI Zip: 54115
Site Plan
PI-1
Public & Civic
Public & Civic
Yes
Yes
First Name: School Distrcit of Last Name: West De Pere
Yes
920-371-4838
TVandeHey@wdpsd.com
Yes
First Name: Nathan Last Name: Stark
Bray Architects
Street Address: 829 S. 1st St City: Milwaukee State: WI Zip: 53204
414-290-1987

Authorized Representati Address:	ve's Email	nstark@brayarch.com
Upload File(s) Here		3697 - West De Pere High School Addition and Renovations_Drawing Set - 2025-10-31.pdf
Please attach a PDF cop plan.	y of the site	Bray 3697 SDWD 100_CD Civils.pdf
Please attach a CAD copproperty that shows the all hard, impervious surfone page needed, not the plan.)	footprint of aces. (Only	25.0092 - SD of West De Pere - HS Tech Ed Addition - Bray - CAD.dwg
Would you like a basic c information to include in plan?		No
How do you plan on pay application?	ing for your	Mail a check
Total Due:		\$350.00
Signature Data	First Name: N Last Name: S Email Addres	

Signed at: November 10, 2025 5:56pm America/New_York
IP Address: 12.174.56.220

Referrer URL:

User's Session Information



AUTO ADDITION AND RENOVATIONS TO:

WEST DE PERE HIGH SCHOOL

SCHOOL DISTRICT OF WEST DE PERE 665 GRANT STREET, DE PERE, WI 54115



Austin Straubel International IT2 Airport Ashwauberion A

CONSTRUCTION MANAGER

Miron Construction Co., Inc. 1471 McMahon Drive Neenah, WI 54946 (920) 969-7000

CONSULTANTS

Civil/Landscape

Point of Beginning, Inc. 4941 Kirschling Court Stevens Point, Wisconsin 54481 (715) 344-9999

<u>Structural</u>

Ambrose Engineering, Inc.
W66 N215 Commerce Court, Suite #100
Cedarburg, Wisconsin 53012
(262) 377-7602

Mechanical

MSA Professional Services, Inc. 12308 Corporate Parkway, Suite 400 Mequon, Wisconsin 53092 (262) 243-9090

<u>Plumbing</u>

MSA Professional Services, Inc. 247 W. Freshwater Way Milwaukee, WI 53204 (414) 296-4333

Electrical

MSA Professional Services, Inc. 116 Fremont Street, PO Box 235 Kiel, Wisconsin 53042 (920) 894-7800

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AUTO ADDITION AND RENOVATIONS TO:

WEST DE PERE HIGH SCHOOL

SCHOOL DISTRICT OF WEST DE PERE

665 GRANT STREET, DE PERE, WI 54115

Issued for:

CONSTRUCTION DOCUMENTS

Project Number: 3697


2025-10-31

Sheet Title:

COVER SHEET

Sheet Numb

G0.0

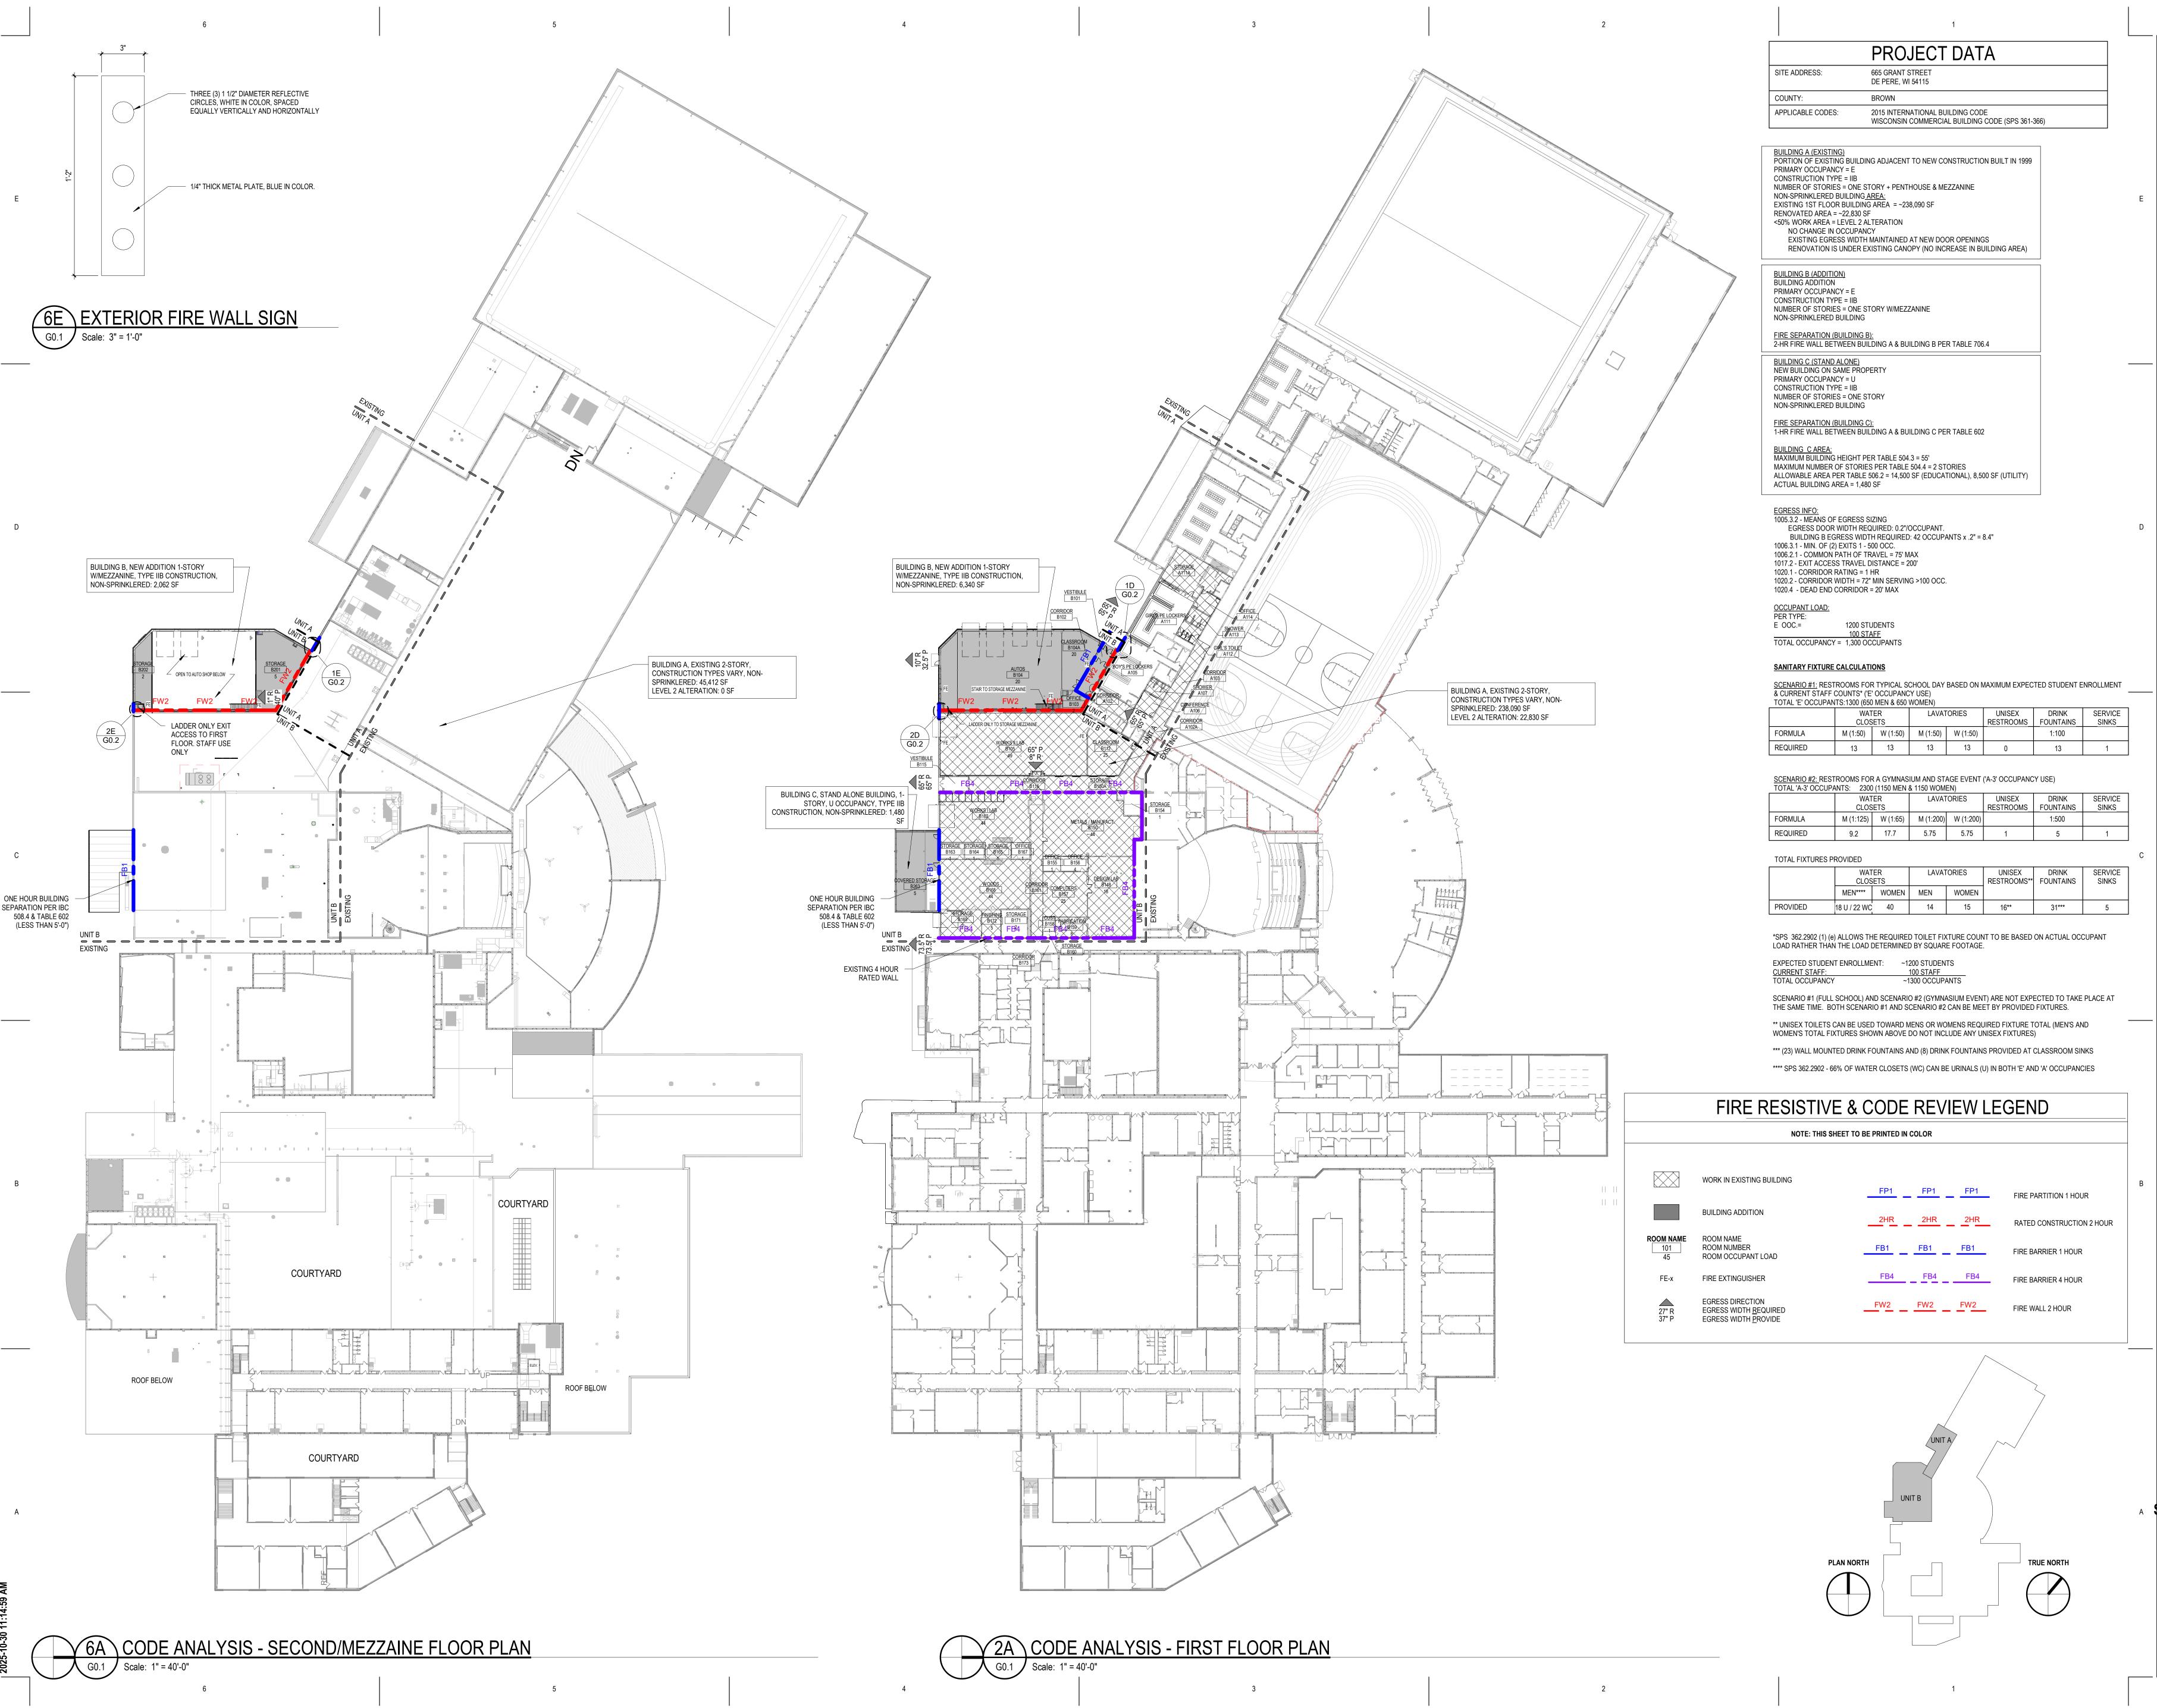

BRCHITECTS

Milwaukee 829 South 1st Street Milwaukee, Wisconsin 53204 T: 414.226.0200

Sheboygan • Davenport Milwaukee • Saint Paul

www.brayarch.com

TO ADDITION AND RENOVATIONS TO: ST DE PERE HIGH SCHOOL HOOL DISTRICT OF WEST DE PERE GRANT STREET, DE PERE, WI 54115

SSUANCES + REVISIONS:

DATE DESCRIPTION
08/15/2025 DESIGN DEVELOPMENT

2 8/25/2025 CONSTRUCTION DOCUMENTS
3 09/19/2025 50% CONSTRUCTION DOCUMENTS

CONSTRUCTION DOCUMENTS

Project Number: **3697**

2025-10-31


Sheet Title:

CODE REVIEW
FIRST &
SECOND/MEZZANINE

Sheet Number:

FLOOR PLANS

G0.1

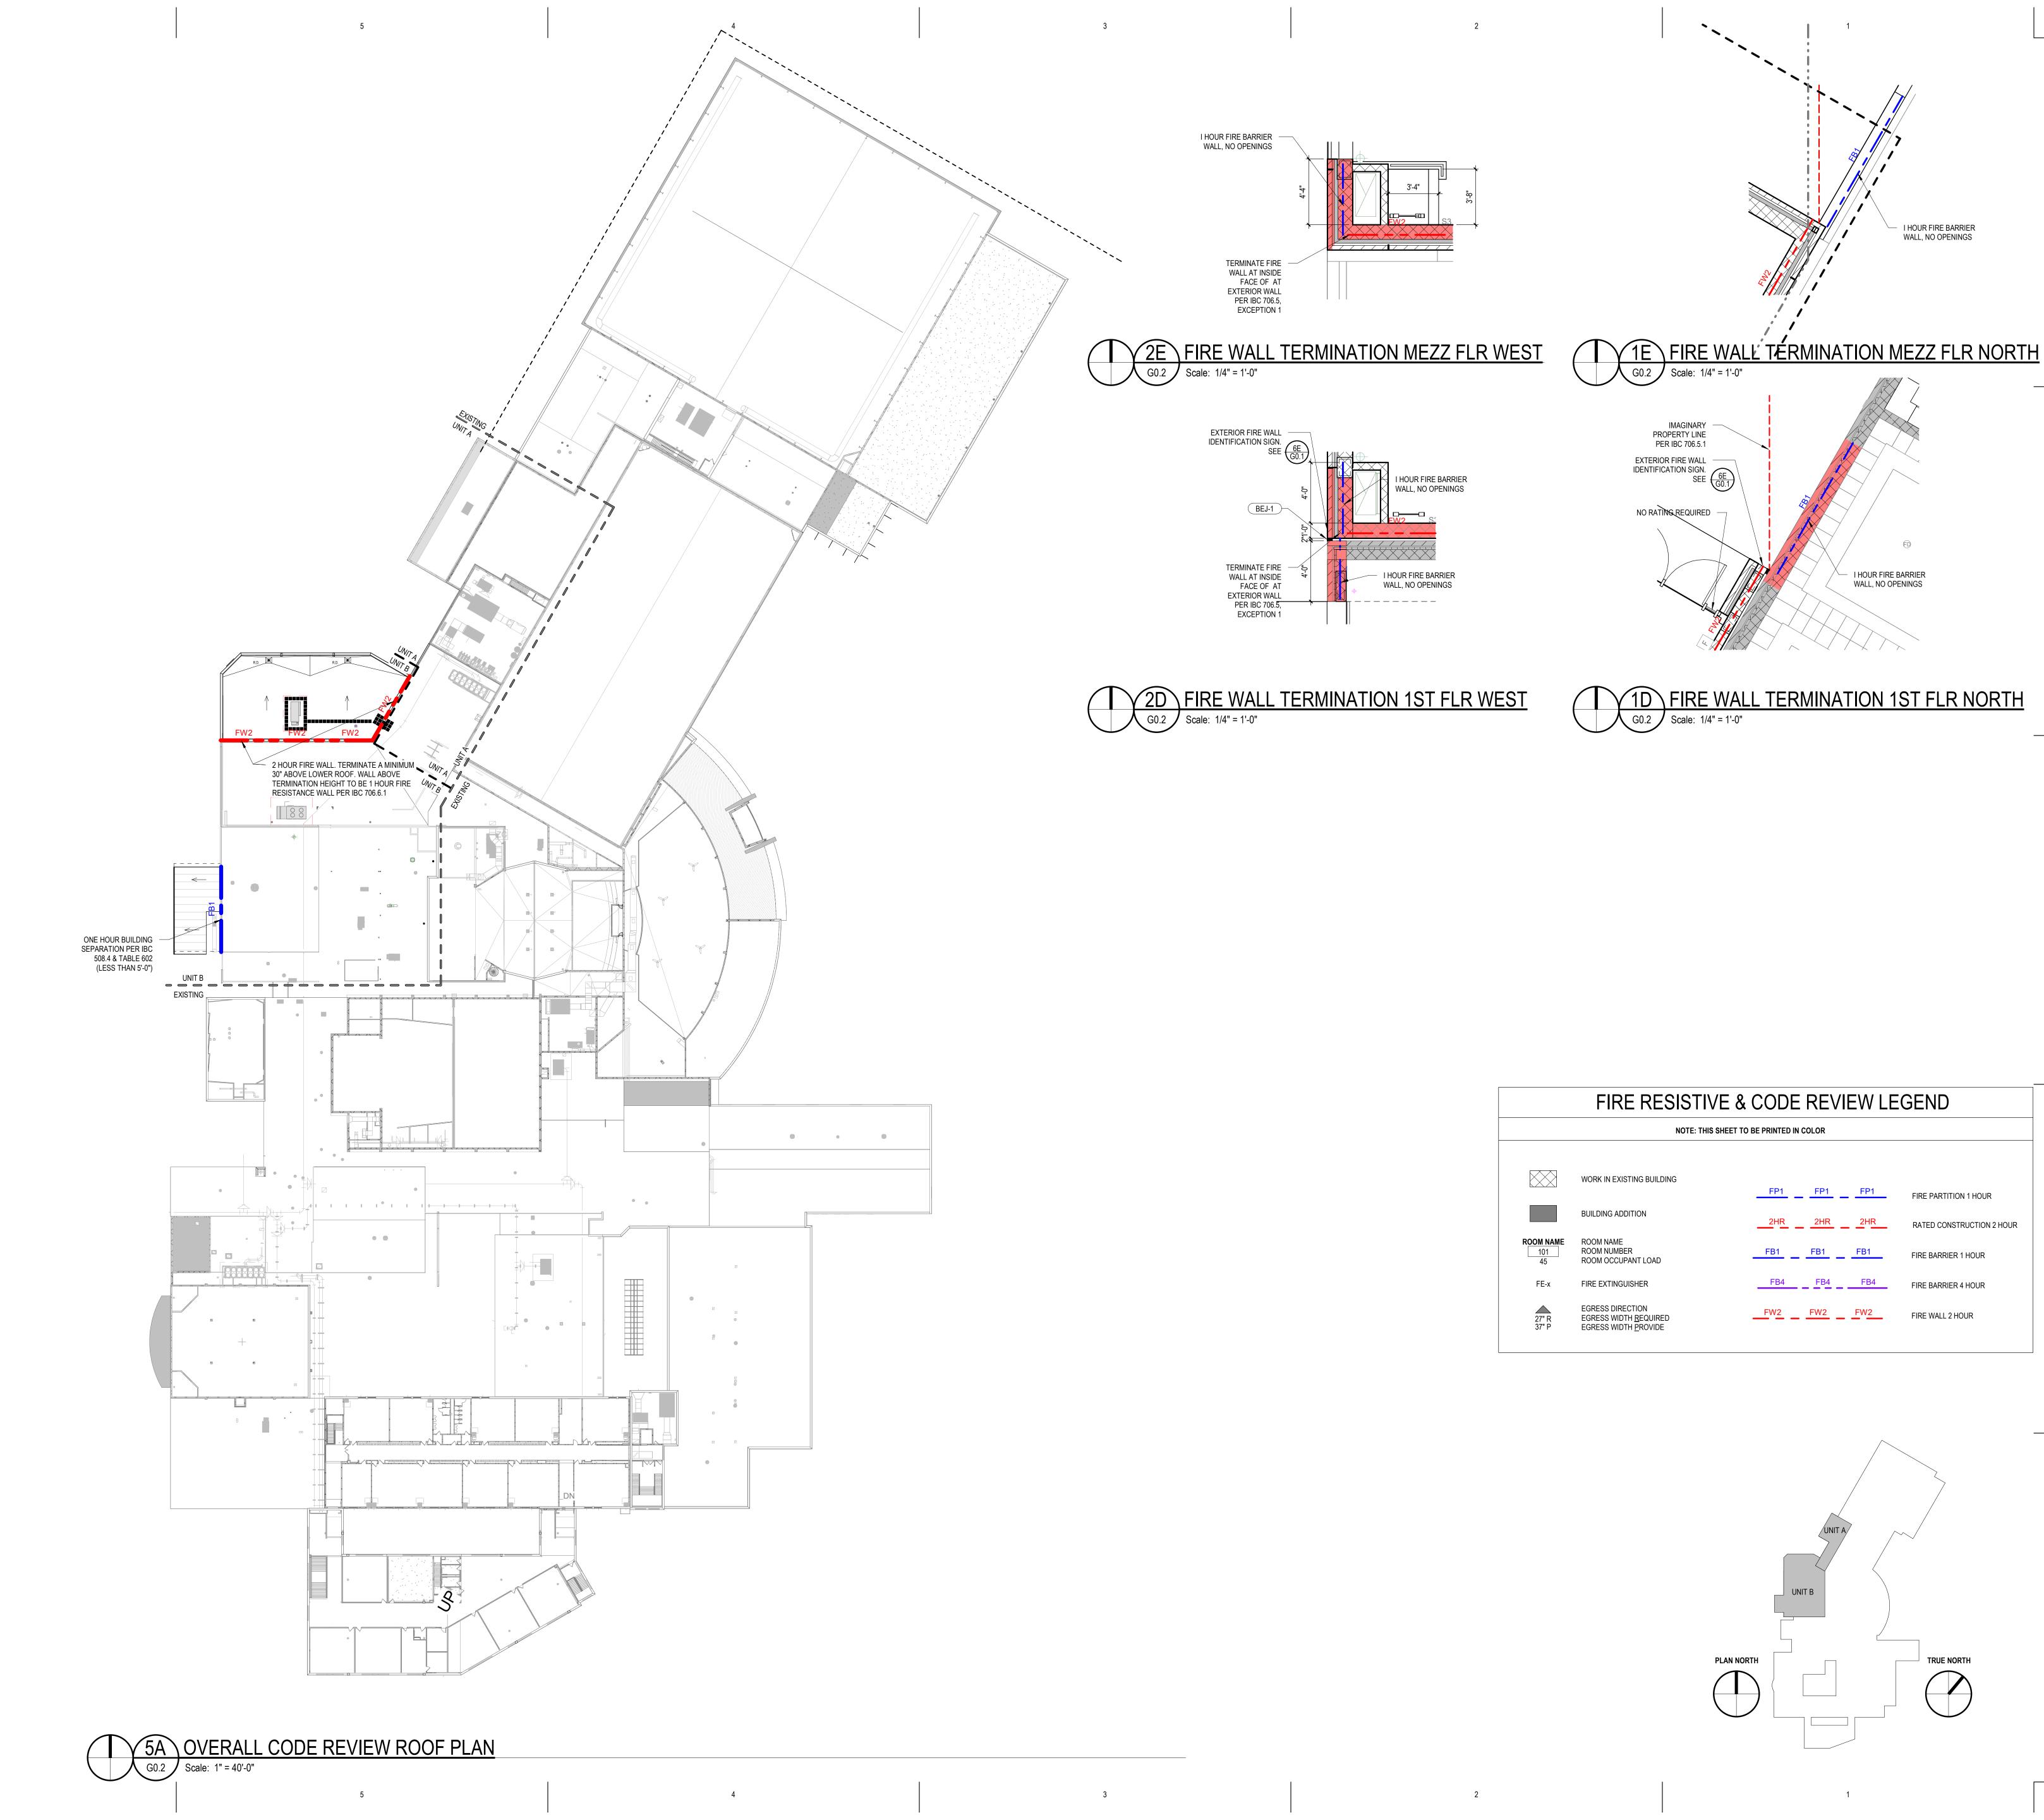

I HOUR FIRE BARRIER WALL, NO OPENINGS

I HOUR FIRE BARRIER WALL, NO OPENINGS

FIRE PARTITION 1 HOUR

FIRE BARRIER 1 HOUR

FIRE BARRIER 4 HOUR

FIRE WALL 2 HOUR

2HR 2HR 2HR RATED CONSTRUCTION 2 HOUR

FW2 FW2 FW2

Milwaukee 829 South 1st Street Milwaukee, Wisconsin 53204 T: 414.226.0200

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ISSUANCES + REVISIONS:

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1 08/15/2025 DESIGN DEVELOPMENT
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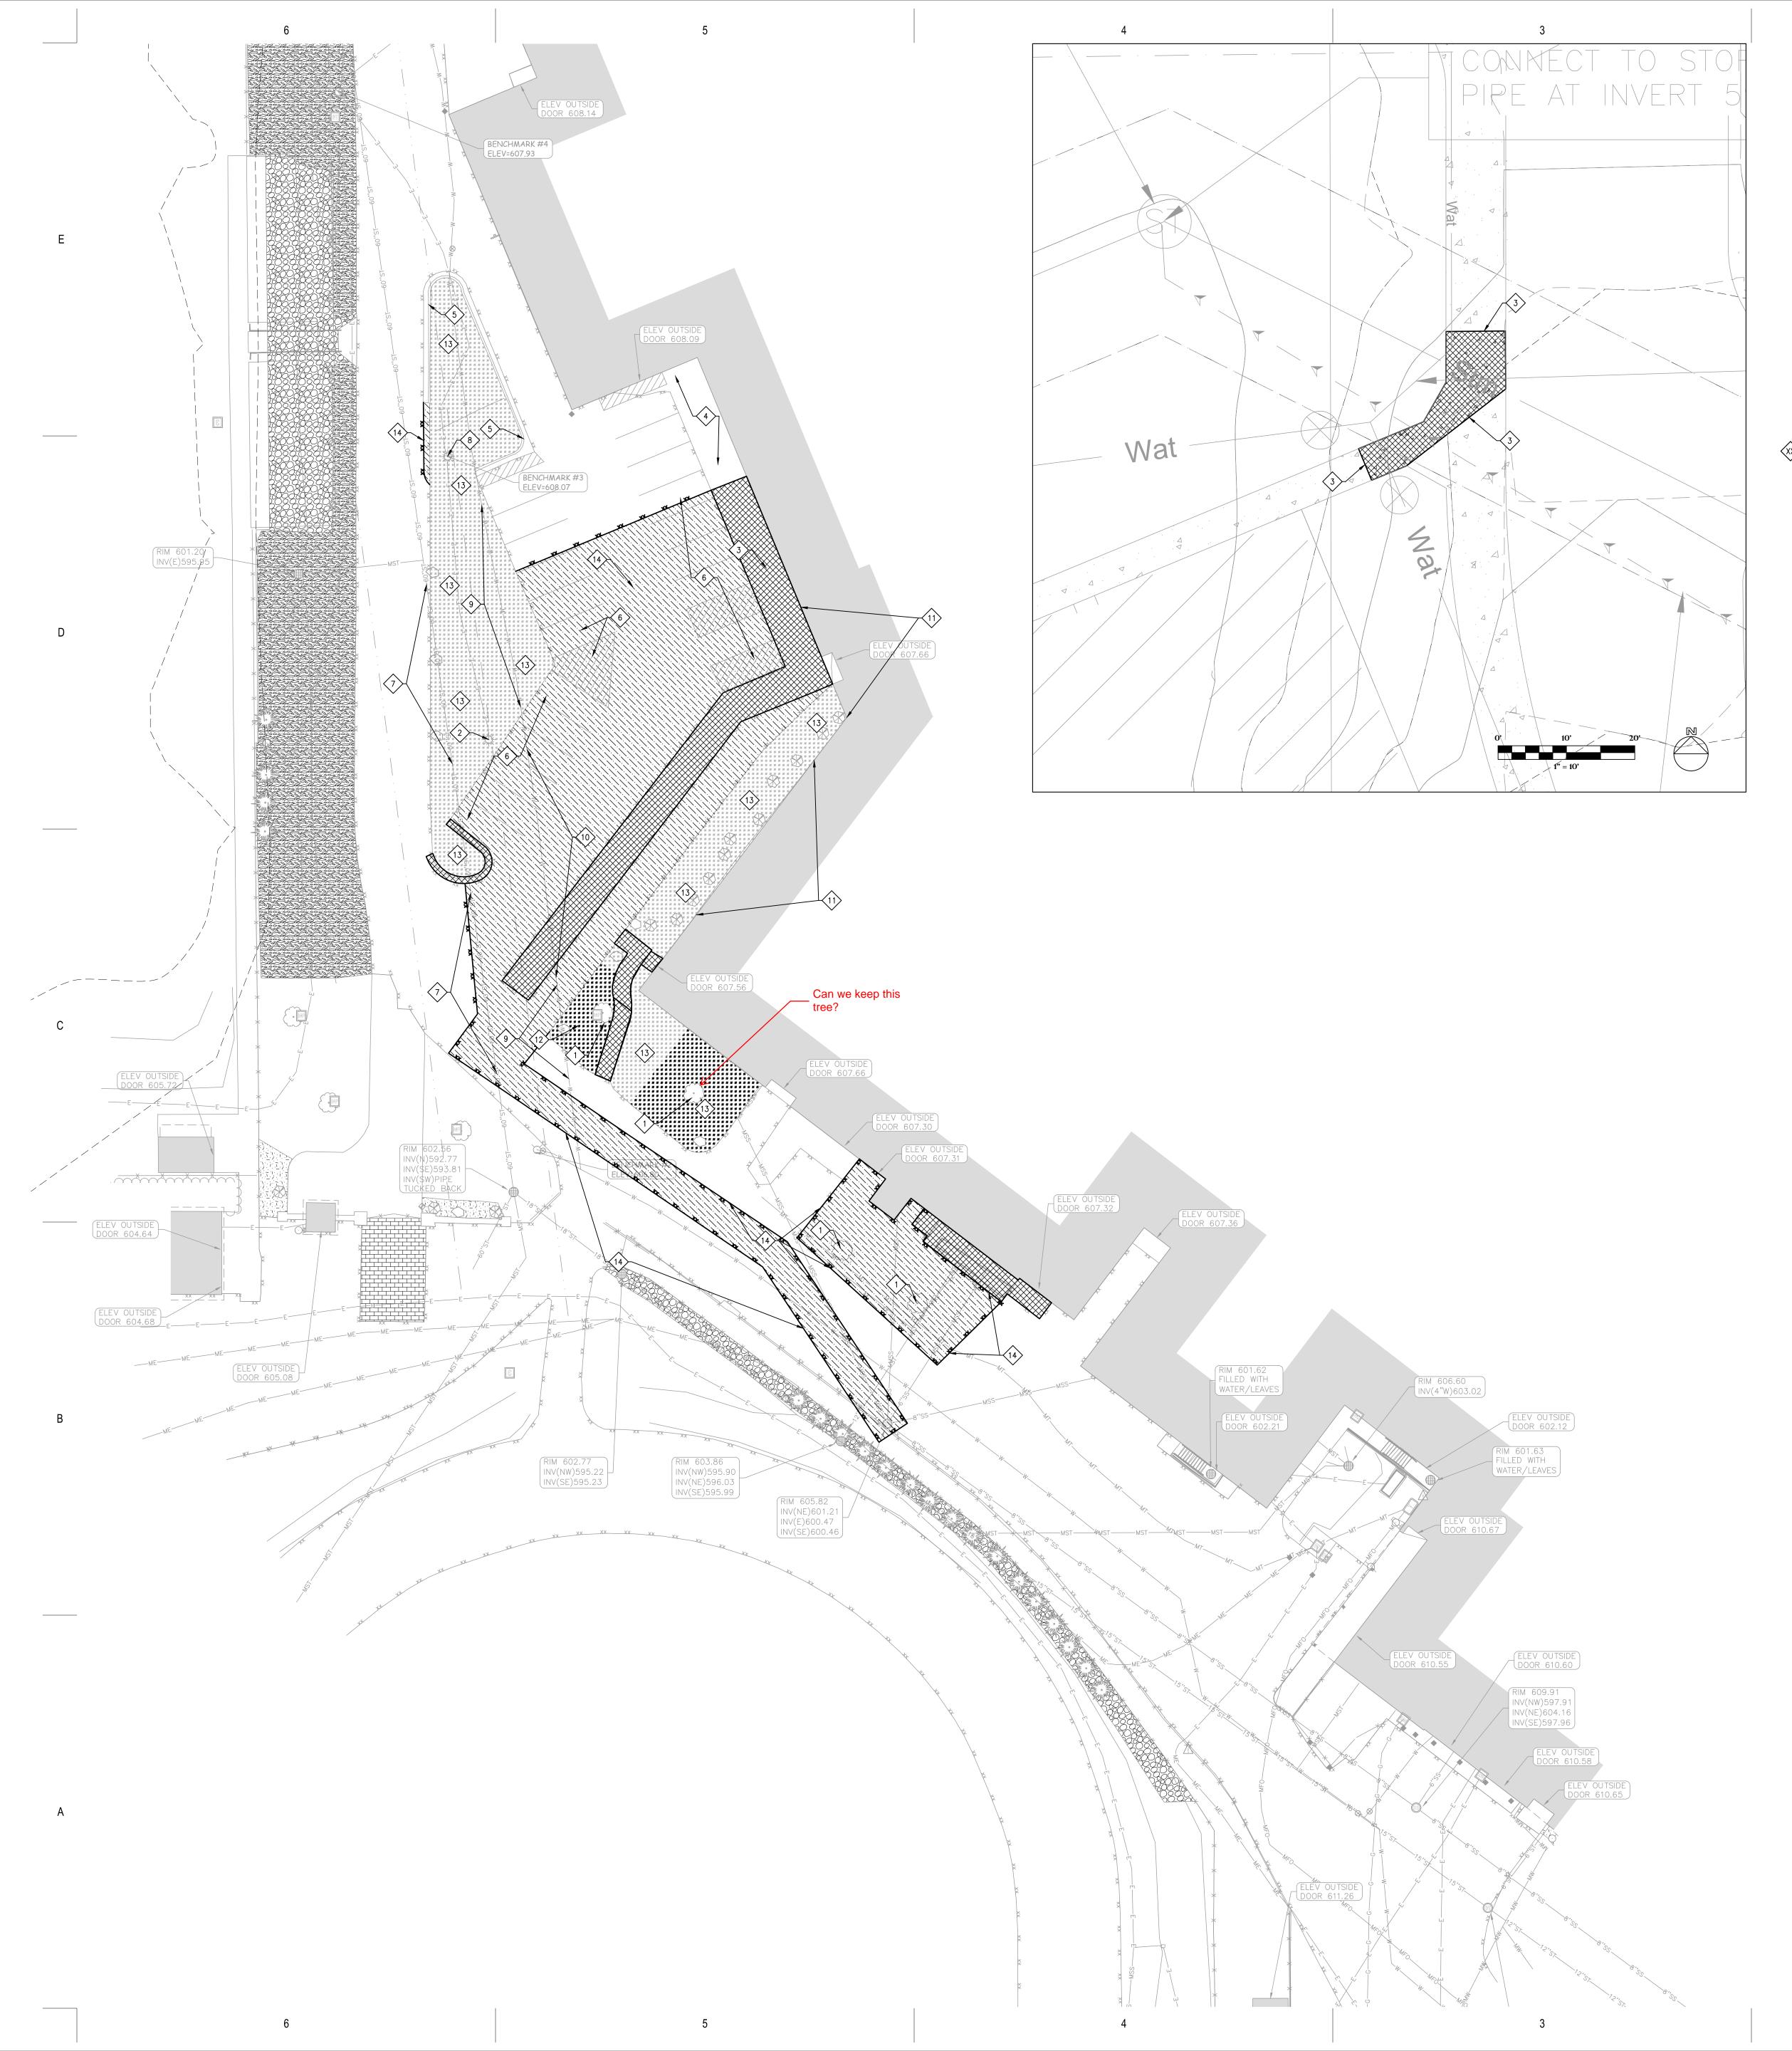
CONSTRUCTION **DOCUMENTS**

2025-10-31

Project Number: 3697

Sheet Title: **CODE REVIEW ROOF PLAN & FIRE WALL TERMINATION DETAILS**

Sheet Number:



- 1. CONTRACTOR SHALL LOCATE ALL PUBLIC AND PRIVATE UTILITIES PRIOR TO COMMENCEMENT OF WORK. 2. ALL DEMOLITION MATERIALS SHALL BE REMOVED FROM THE SITE AND DISPOSED OF IN A LEGAL MANNER EXCEPT
- FOR THOSE ITEMS NOTED TO BE SALVAGED, WHICH SHOULD BE TURNED OVER TO THE OWNER. 3. INSTALL AND MAINTAIN ALL REQUIRED EROSION CONTROL MEASURES FOR PERIMETER PROTECTION PRIOR TO THE
- START OF DEMOLITION/CONSTRUCTION, IN ACCORDANCE WITH THE LOCAL AND STATE GOVERNING AUTHORITIES. 4. BIDDERS SHALL VISIT THE SITE AND REVIEW EXISTING CONDITIONS PRIOR TO THE BID DATE.
- 5. ANY EXISTING PUBLIC & PRIVATE UTILITIES NOT SHOWN ON THIS DOCUMENT WHICH NEED TO BE REMOVED, RELOCATED, AND/OR ADJUSTED SHALL BE THE RESPONSIBILITY OF THE SITE GRADING CONTRACTOR.
- 6. COORDINATE ALL PRIVATE & PUBLIC UTILITY REMOVAL, DISCONNECTION, &/OR RECONNECTION WITH RESPECTIVE UTILITY COMPANIES PRIOR TO BEGINNING WORK.
- 7. COORDINATE UTILITY SERVICE DISCONNECTIONS/OUTAGES WITH OWNER AND ANY IMPACTED NEIGHBORS. MINIMIZE DISRUPTIONS TO THE MAXIMUM EXTENT PRACTICAL.
- 8. ANY EXISTING UTILITIES NOT EXPRESSLY LABELED FOR DEMOLITION/REMOVAL ON THIS DOCUMENT SHALL BE LEFT IN PLACE AND IN THEIR CURRENT STATE OF OPERATION. CONTACT ENGINEER WHEREVER CLARIFICATION IS NEEDED.
 9. PRIOR TO PERFORMING WORK WITHIN PUBLIC RIGHT OF WAYS, NOTIFY AND COORDINATE WORK WITH THE LOCAL

KEYNOTES:


- REMOVE TREE
- 2. REMOVE AND RELOCATE EXISTING
- POWER/LIGHT POLE
- 3. SAWCUT EXISTING CONCRETE WALK
- 4. MAINTAIN EXISTING CONCRETE WALK
- 5. MAINTAIN EXISTING CONCRETE CURBING
- 6. REMOVE EXISTING PARKING LOT STRIPING
- 7. MAINTAIN EXISTING STORM SEWER PIPE
- 8. MAINTAIN EXISTING ELECTRICAL
- 9. MAINTAIN EXISTING WATER SERVICE

10. REMOVE EXISTING WATER SERVICE


- 11. MAINTAIN EXISTING BUILDING
- 12. MAINTAIN EXISTING LANDSCAPE AREA: TREES, SHRUBS, MULCH AND FILTER FABRIC- VERIFY WITH LANDSCAPE PLAN
- 13. REMOVE EXISTING LANDSCAPE AREA: SHRUBS, MULCH AND FILTER FABRIC
- 14. SAWCUT EXISTING ASPHALT

DEMOLITION HATCH PATTERNS:

BITUMINOUS REMOVAL

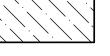

CONCRETE REMOVAL

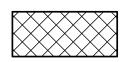

CIVIL SHEET INDEX:

- **DEMOLITION PLAN**
- LAYOUT PLAN
- 3. GRADING PLAN
- UTILITY PLAN 5. DETAILS

BENCHMARK:

ELEVATIONS ARE REFERENCED TO NAVD 88 DATUM.

BURY BOLT ON HYDRANT, LOCATED APPROXIMATELY 30 FEET EAST OF THE SHED ON THE EAST SIDE OF THE TRACK AND FIELD.

ELEVATION = 611.64

BURY BOLT ON HYDRANT, Located on the North Side of the track and field, located approximately 60 feet northeast of the ticket stand. Elevation = 606.80

BENCHMARK#3
CHISELED SQUARE ON WEST SIDE OF LIGHT POLE BASE,
LOCATED BETWEEN THE BLEACHERS ON THE EAST SIDE OF THE SOCCER FIELD AND THE WEST DE PERE HIGH ELEVATION = 608.07


CHISELED SQUARE ON WEST SIDE OF LIGHT POLE BASE, LOCATED NORTH OF THE BLEACHERS ON THE EAST SIDE OF THE SOCCER FIELD.

UTILITY DISCLAIMER:

THE LOCATIONS, SIZES, AND TYPES OF UNDERGROUND PUBLIC AND PRIVATE UTILITIES OR SUBSTRUCTURES SHOW HEREON WERE OBTAINED FROM VISUAL INSPECTION, FIELD MEASUREMENTS, AND/OR AS-BUILT PLANS. SANITARY SEWER AND STORM SEWER PIPE SIZES, INVERTS, DIRECTION, AND LOCATIONS BETWEEN MANHOLES ARE SUPPLEMENTED BY AS-BUILT PLANS AND/OR ESTIMATED BASED ON FIELD OBSERVATIONS. PRIOR TO CONSTRUCTION IN THE VICINITY OF ANY UTILITIES SHOWN HEREON, IT IS RECOMMENDED THAT THE LOCATIONS, DEPTHS, AND SIZES BE FIELD VERIFIED. THE LOCATIONS SHOWN HEREON ARE ONLY APPROXIMATE, WITH POSSIBILITY THAT ADDITIONAL UTILITY LINES NOT DISCOVERED, OR MARKED, DURING THE SEARCH OF RECORDS AND THE FIELD SURVEY MAY EXIST. ANY CONTRACTOR USING THE INFORMATION SHOWN HEREON IS HEREBY FOREWARNED THAT ANY EXCAVATION UPON THIS SITE MAY RESULT IN THE DISCOVERY OF ADDITIONAL UNDERGROUND UTILITIES NOT SHOWN HEREON. IN GENERAL, UNDERGROUND UTILITY LOCATIONS ARE SHOWN FROM UTILITY MARKINGS,

BY OTHERS, AND/OR AS-BUILT PLANS, PROVIDED BY OTHERS. POINT OF BEGINNING MAKES NO WARRANTY OF ANY KIND, EXPRESS OR IMPLIED, WITH RESPECT TO THE EXISTING UTILITIES SHOWN HEREON, AND BELIEVES THAT THE INFORMATION CONTAINED HEREIN IS RELIABLE

AND GENERALLY ACCURATE FOR THE PURPOSE INTENDED.

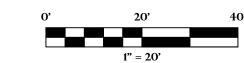





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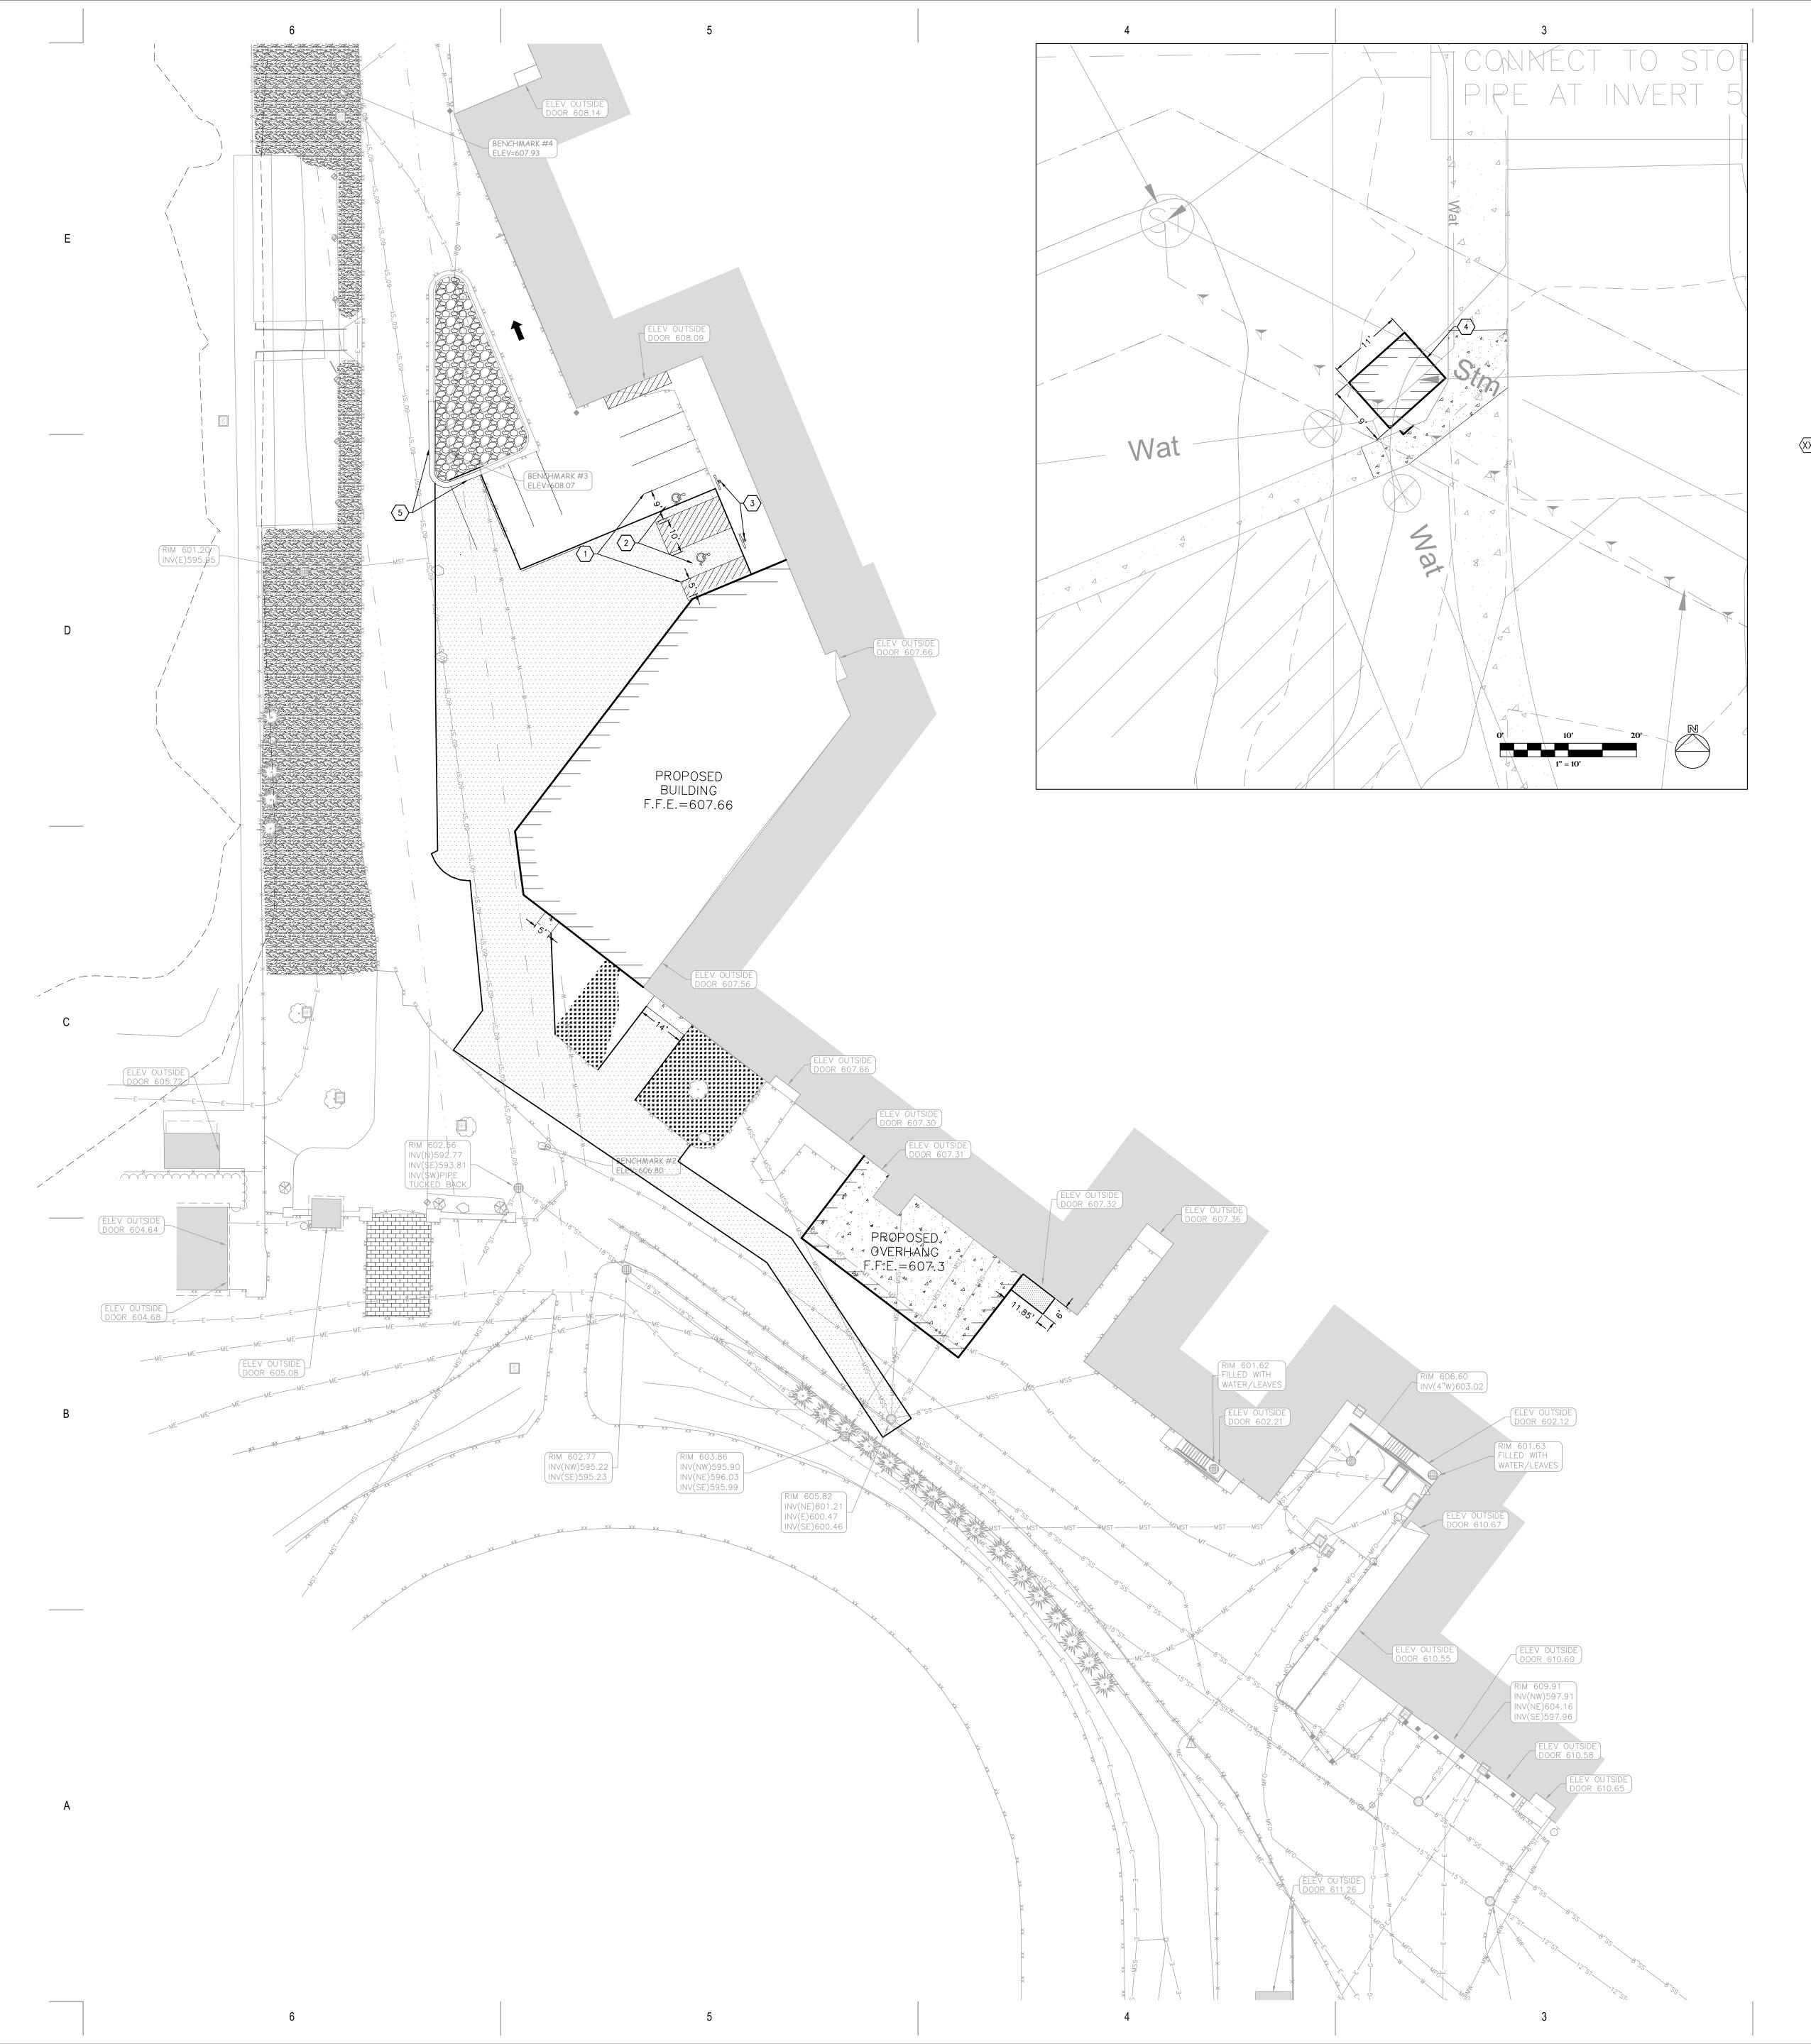
> Project Number: 3697

10/10/2025

Sheet Title:

DEMOLITIAN

Sheet Number:



ACCORDANCE WITH THE PROJECT SPECIFICATIONS.

- CONTRACTOR SHALL LOCATE ALL PUBLIC AND PRIVATE UTILITIES PRIOR TO COMMENCEMENT OF WORK. GRADE, LINE, AND LEVEL TO BE REVIEWED IN THE FIELD BY THE CONSTRUCTION MANAGER. 3. ALL REQUIRED EROSION CONTROL MEASURES SHALL BE INSTALLED AND MAINTAINED IN ACCORDANCE WITH
- LOCAL MUNICIPAL AND DEPARTMENT OF NATURAL RESOURCES REGULATIONS. 4. ANY EXISTING UTILITIES NOT SHOWN ON THIS DOCUMENT WHICH NEED TO BE REMOVED, RELOCATED AND OR ADJUSTED SHALL BE THE RESPONSIBILITY OF THE SITE GRADING CONTRACTOR. 5. VERIFY THE LOCATION OF ALL EXISTING UTILITIES PRIOR TO THE START OF DEMOLITION/CONSTRUCTION.
- 6. BIDDERS SHALL VISIT THE SITE AND REVIEW EXISTING CONDITIONS PRIOR TO THE BID DATE. 7. PRIOR TO STARTING WORK, VERIFY WITH THE LOCAL AUTHORITIES THAT ALL REQUIRED PERMITS HAVE
- 8. COORDINATE CONSTRUCTION IN THE RIGHT OF WAY WITH THE LOCAL AUTHORITIES. 9. PROVIDE PROPER BARRICADES, SIGNS, AND TRAFFIC CONTROL TO MAINTAIN THRU TRAFFIC ALONG
- ADJACENT STREETS IN ACCORDANCE WITH LOCAL MUNICIPAL REQUIREMENTS. 10. ALL GENERAL LANDSCAPE AREAS SHALL BE SEEDED, FERTILIZED, AND CRIMP HAY MULCHED IN

KEYNOTES:


1. PARKING LOT STRIPING

2. HANDICAP PARKING STALL

3. HANDICAP PARKING SIGN

4. CONCRETE VAULT

5. CONCRETE CURB & GUTTER

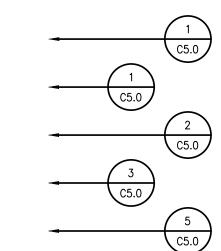


PAVEMENT HATCH PATTERNS:

PROPOSED HEAVY DUTY ASPHALT PAVEMENT

PROPOSED CONCRETE PAVEMENT

PROPOSED RIPRAP LANDSCAPED



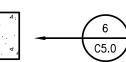

BENCHMARK:

ELEVATIONS ARE REFERENCED TO NAVD 88 DATUM.

BURY BOLT ON HYDRANT, LOCATED APPROXIMATELY 30 FEET EAST OF THE SHED ON THE EAST SIDE OF THE TRACK AND FIELD. ELEVATION = 611.64


BURY BOLT ON HYDRANT, Located on the north side of the track and field, located approximately 60 feet northeast of the ticket stand. Elevation = 606.80

BENCHMARK#3 Chiseled square on west side of light pole base, Located between the bleachers on the east side of the soccer field and the west de pere high ELEVATION = 608.07

CHISELED SQUARE ON WEST SIDE OF LIGHT POLE BASE,
LOCATED NORTH OF THE BLEACHERS ON THE EAST SIDE OF THE SOCCER FIELD.

UTILITY DISCLAIMER:

THE LOCATIONS, SIZES, AND TYPES OF UNDERGROUND PUBLIC AND PRIVATE UTILITIES OR SUBSTRUCTURES SHOW HEREON WERE OBTAINED FROM VISUAL INSPECTION, FIELD MEASUREMENTS, AND/OR AS-BUILT PLANS. SANITARY SEWER AND STORM SEWER PIPE SIZES, INVERTS, DIRECTION, AND LOCATIONS BETWEEN MANHOLES ARE SUPPLEMENTED BY AS-BUILT PLANS AND/OR ESTIMATED BASED ON FIELD OBSERVATIONS. PRIOR TO CONSTRUCTION IN THE VICINITY OF ANY UTILITIES SHOWN HEREON, IT IS RECOMMENDED THAT THE LOCATIONS, DEPTHS, AND SIZES BE FIELD VERIFIED. THE LOCATIONS SHOWN HEREON ARE ONLY APPROXIMATE, WITH POSSIBILITY THAT ADDITIONAL UTILITY LINES NOT DISCOVERED, OR MARKED, DURING THE SEARCH OF RECORDS AND THE FIELD SURVEY MAY EXIST. ANY CONTRACTOR USING THE INFORMATION SHOWN HEREON IS HEREBY FOREWARNED THAT ANY EXCAVATION UPON THIS SITE MAY RESULT IN THE DISCOVERY OF ADDITIONAL UNDERGROUND UTILITIES NOT SHOWN HEREON. IN GENERAL, UNDERGROUND UTILITY LOCATIONS ARE SHOWN FROM UTILITY MARKINGS, BY OTHERS, AND/OR AS-BUILT PLANS, PROVIDED BY OTHERS. POINT OF BEGINNING MAKES NO WARRANTY OF ANY KIND, EXPRESS OR IMPLIED, WITH RESPECT TO THE EXISTING UTILITIES SHOWN HEREON, AND BELIEVES THAT THE INFORMATION CONTAINED HEREIN IS RELIABLE AND GENERALLY ACCURATE FOR THE PURPOSE INTENDED.

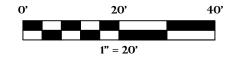





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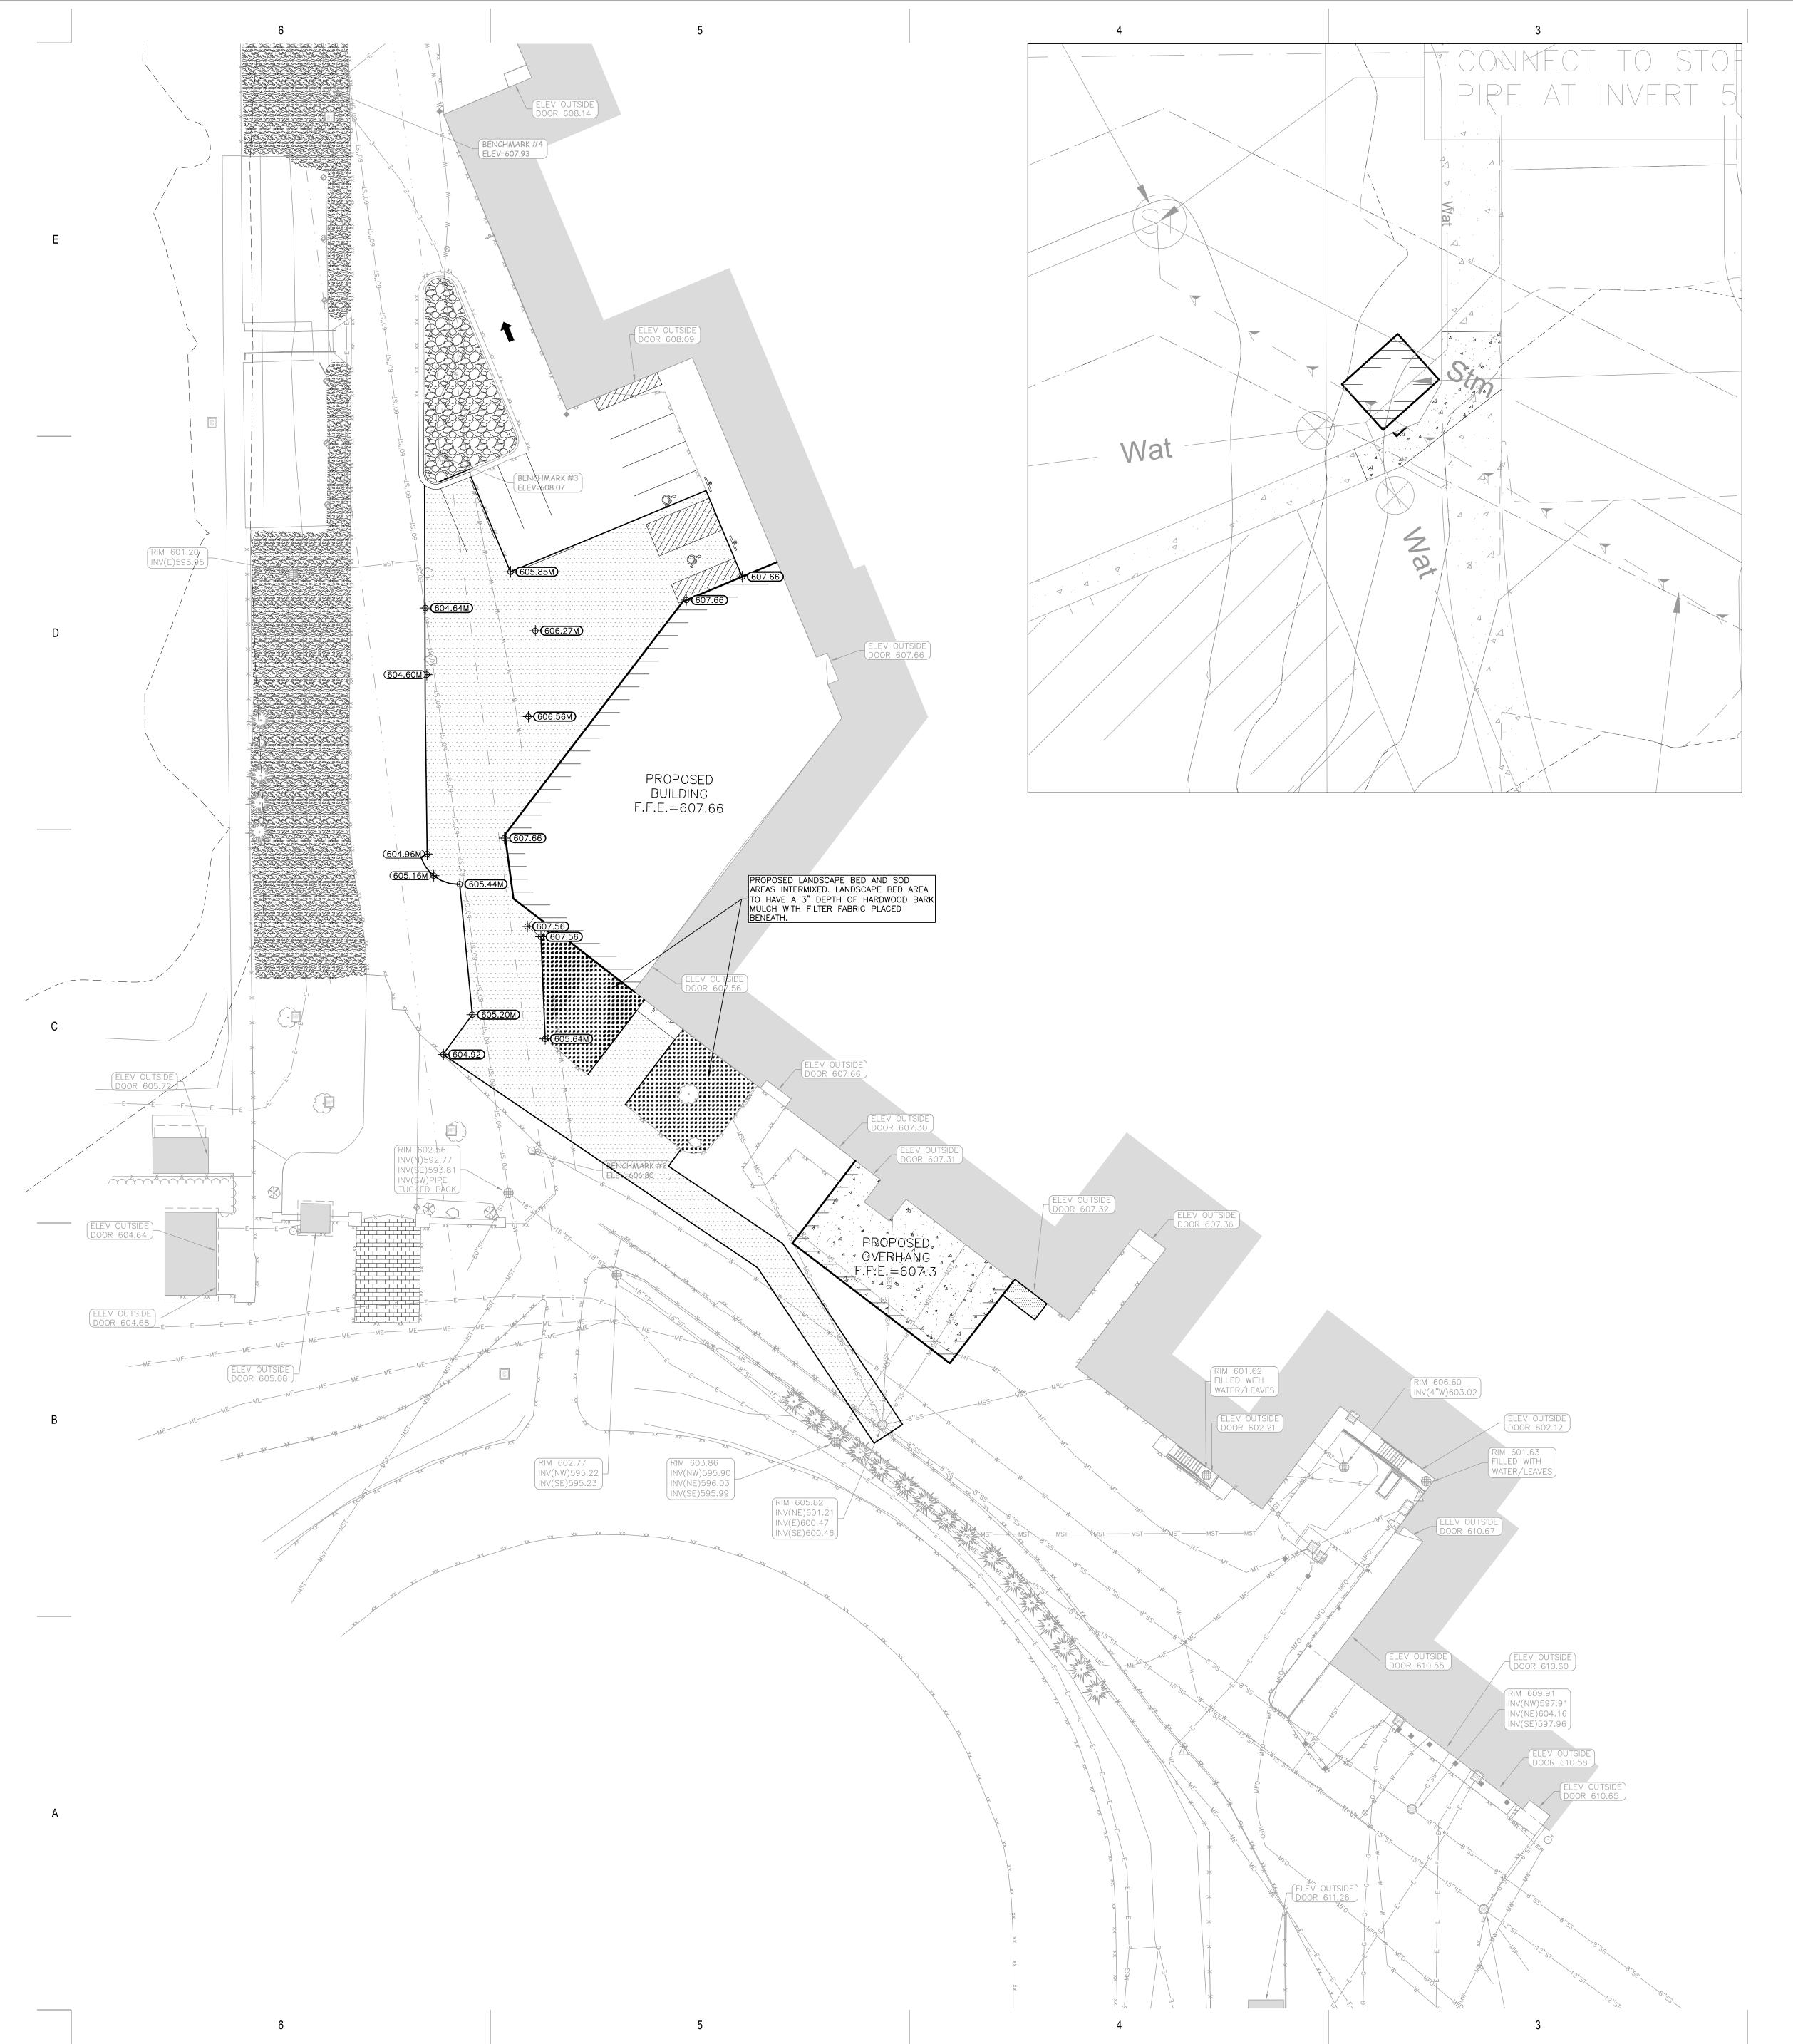
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> Project Number: 3697

Sheet Title:

LAYOUT PLAN

Sheet Number:



- 1. CONTRACTOR SHALL LOCATE ALL PUBLIC AND PRIVATE UTILITIES PRIOR TO COMMENCEMENT OF WORK. 2. THE PROPOSED SITE PLAN FINISH FLOOR ELEVATION OF _____ EQUALS THE PROPOSED BUILDING
- ARCHITECTURAL FINISH FLOOR ELEVATION OF 100.00'.

 3. GRADE, LINE, AND LEVEL SHALL BE REVIEWED IN THE FIELD BY THE CONSTRUCTION MANAGER.

 4. INSTALL AND MAINTAIN ALL REQUIRED EROSION CONTROL MEASURES IN ACCORDANCE WITH LOCAL MUNICIPAL AND DEPARTMENT OF NATURAL RESOURCES REGULATIONS.
- 5. 6" OF TOPSOIL SHALL BE PROVIDED IN ALL GENERAL LAWN AREAS AND 12" SHALL BE PROVIDED IN ALL PLANTING BED AREAS.
- 6. ANY EXISTING UTILITIES NOT SHOWN ON THIS DOCUMENT WHICH NEED TO BE REMOVED, RELOCATED, AND/OR ADJUSTED SHALL BE THE RESPONSIBILITY OF THE SITE GRADING CONTRACTOR.
- 7. COORDINATE ALL EARTHWORK ACTIVITIES WITH THE RESPECTIVE TRADES RESPONSIBLE FOR THE INSTALLATION OF GAS, CABLE, TELEPHONE AND ELECTRICAL (INCLUDING MAIN SERVICE, SITE LIGHTING, CONDUITS AND
- 8. ALL TESTING AND INSPECTION SHALL BE DONE IN ACCORDANCE WITH SPS 382.21.
 9. THE LOCAL MUNICIPALITY SHALL BE CONTACTED PRIOR TO ANY EXCAVATION IN THE PUBLIC RIGHT—OF—WAY.
 10. THE CONTRACTOR SHALL HAVE A TRAFFIC CONTROL PLAN APPROVED PRIOR TO WORK COMMENCING.
 11. THE LOCAL MUNICIPALITY SHALL OPERATE ALL EXISTING WATER VALVES IF NEEDED.

GRADING LEGEND:

EXISTING CONTOUR PROPOSED CONTOUR PROPOSED SPOT ELEVATION PROPOSED MATCH ELEVATION (CONTRACTOR TO VERIFY)

BENCHMARK:

ELEVATIONS ARE REFERENCED TO NAVD 88 DATUM.

BURY BOLT ON HYDRANT, LOCATED APPROXIMATELY 30 FEET EAST OF THE SHED ON THE EAST SIDE OF THE TRACK AND FIELD. ELEVATION = 611.64

BURY BOLT ON HYDRANT, Located on the north side of the track and field, located approximately 60 feet northeast of the ticket stand. Elevation = 606.80


CHISELED SQUARE ON WEST SIDE OF LIGHT POLE BASE,
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CHISELED SQUARE ON WEST SIDE OF LIGHT POLE BASE, LOCATED NORTH OF THE BLEACHERS ON THE EAST SIDE OF THE SOCCER FIELD.

UTILITY DISCLAIMER:

THE LOCATIONS, SIZES, AND TYPES OF UNDERGROUND PUBLIC AND PRIVATE UTILITIES OR SUBSTRUCTURES SHOW HEREON WERE OBTAINED FROM VISUAL INSPECTION, FIELD MEASUREMENTS, AND/OR AS-BUILT PLANS. SANITARY SEWER AND STORM SEWER PIPE SIZES, INVERTS, DIRECTION, AND LOCATIONS BETWEEN MANHOLES ARE SUPPLEMENTED BY AS-BUILT PLANS AND/OR ESTIMATED BASED ON FIELD OBSERVATIONS. PRIOR TO CONSTRUCTION IN THE VICINITY OF ANY UTILITIES SHOWN HEREON, IT IS RECOMMENDED THAT THE LOCATIONS, DEPTHS, AND SIZES BE FIELD VERIFIED. THE LOCATIONS SHOWN HEREON ARE ONLY APPROXIMATE, WITH POSSIBILITY THAT ADDITIONAL UTILITY LINES NOT DISCOVERED, OR MARKED, DURING THE SEARCH OF RECORDS AND THE FIELD SURVEY MAY EXIST. ANY CONTRACTOR USING THE INFORMATION SHOWN HEREON IS HEREBY FOREWARNED THAT ANY EXCAVATION UPON THIS SITE MAY RESULT IN THE DISCOVERY OF ADDITIONAL UNDERGROUND UTILITIES NOT SHOWN HEREON. IN GENERAL, UNDERGROUND UTILITY LOCATIONS ARE SHOWN FROM UTILITY MARKINGS, BY OTHERS, AND/OR AS-BUILT PLANS, PROVIDED BY OTHERS. POINT OF BEGINNING MAKES NO WARRANTY OF ANY KIND, EXPRESS OR IMPLIED, WITH RESPECT TO THE EXISTING UTILITIES SHOWN HEREON, AND BELIEVES THAT THE INFORMATION CONTAINED HEREIN IS RELIABLE

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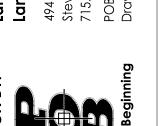




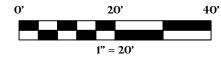

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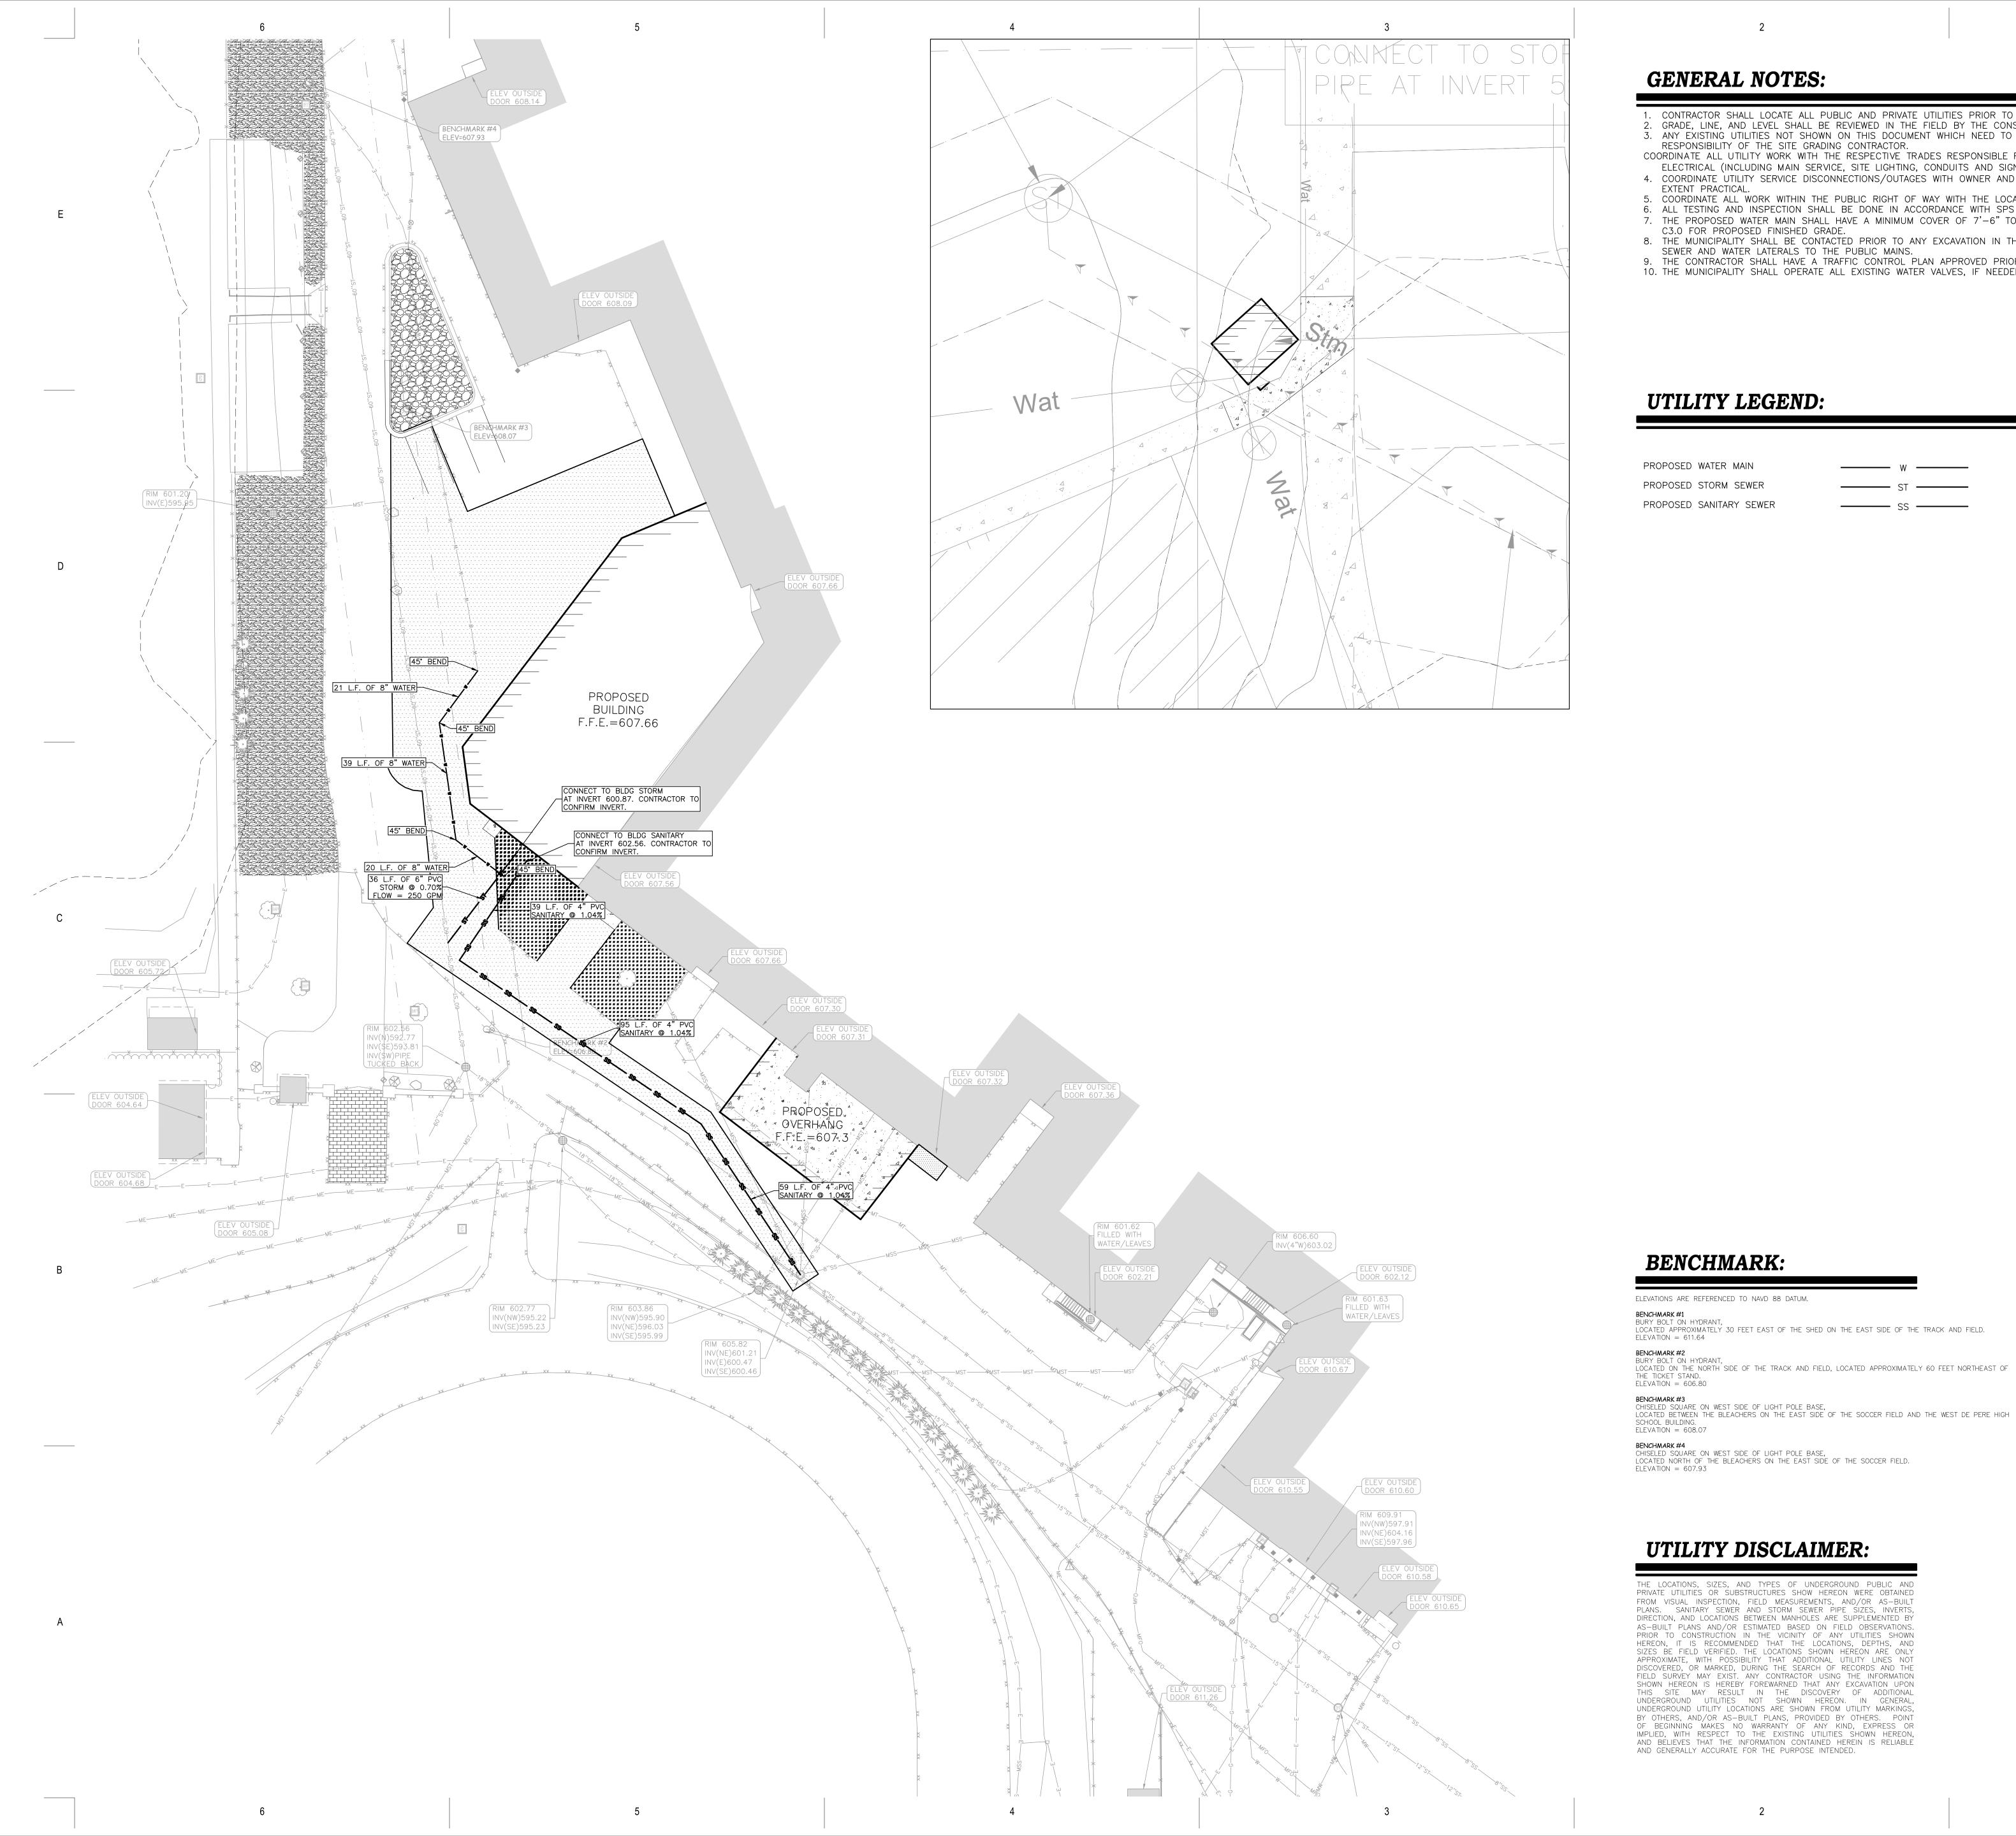
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GRADING

Sheet Number:



- 1. CONTRACTOR SHALL LOCATE ALL PUBLIC AND PRIVATE UTILITIES PRIOR TO COMMENCEMENT OF WORK. 2. GRADE, LINE, AND LEVEL SHALL BE REVIEWED IN THE FIELD BY THE CONSTRUCTION MANAGER.
- 3. ANY EXISTING UTILITIES NOT SHOWN ON THIS DOCUMENT WHICH NEED TO BE REMOVED, RELOCATED AND OR ADJUSTED SHALL BE THE
- RESPONSIBILITY OF THE SITE GRADING CONTRACTOR. COORDINATE ALL UTILITY WORK WITH THE RESPECTIVE TRADES RESPONSIBLE FOR THE INSTALLATION OF GAS, CABLE, TELEPHONE AND
- ELECTRICAL (INCLUDING MAIN SERVICE, SITE LIGHTING, CONDUITS AND SIGNAGE). 4. COORDINATE UTILITY SERVICE DISCONNECTIONS/OUTAGES WITH OWNER AND ANY IMPACTED NEIGHBORS. MINIMIZE DISRUPTIONS TO THE MAXIMUM
- 5. COORDINATE ALL WORK WITHIN THE PUBLIC RIGHT OF WAY WITH THE LOCAL MUNICIPALITY. 6. ALL TESTING AND INSPECTION SHALL BE DONE IN ACCORDANCE WITH SPS 382.21.
- 7. THE PROPOSED WATER MAIN SHALL HAVE A MINIMUM COVER OF 7'-6" TO THE TOP OF PIPE FROM PROPOSED FINISHED GRADE. SEE SHEET C3.0 FOR PROPOSED FINISHED GRADE.
- 8. THE MUNICIPALITY SHALL BE CONTACTED PRIOR TO ANY EXCAVATION IN THE PUBLIC RIGHT-OF-WAY, AND PRIOR TO CONNECTING SANITARY
- SEWER AND WATER LATERALS TO THE PUBLIC MAINS. 9. THE CONTRACTOR SHALL HAVE A TRAFFIC CONTROL PLAN APPROVED PRIOR TO WORK COMMENCING. 10. THE MUNICIPALITY SHALL OPERATE ALL EXISTING WATER VALVES, IF NEEDED.

UTILITY LEGEND:

BENCHMARK:

UTILITY DISCLAIMER:

PROPOSED WATER MAIN PROPOSED STORM SEWER PROPOSED SANITARY SEWER

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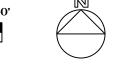
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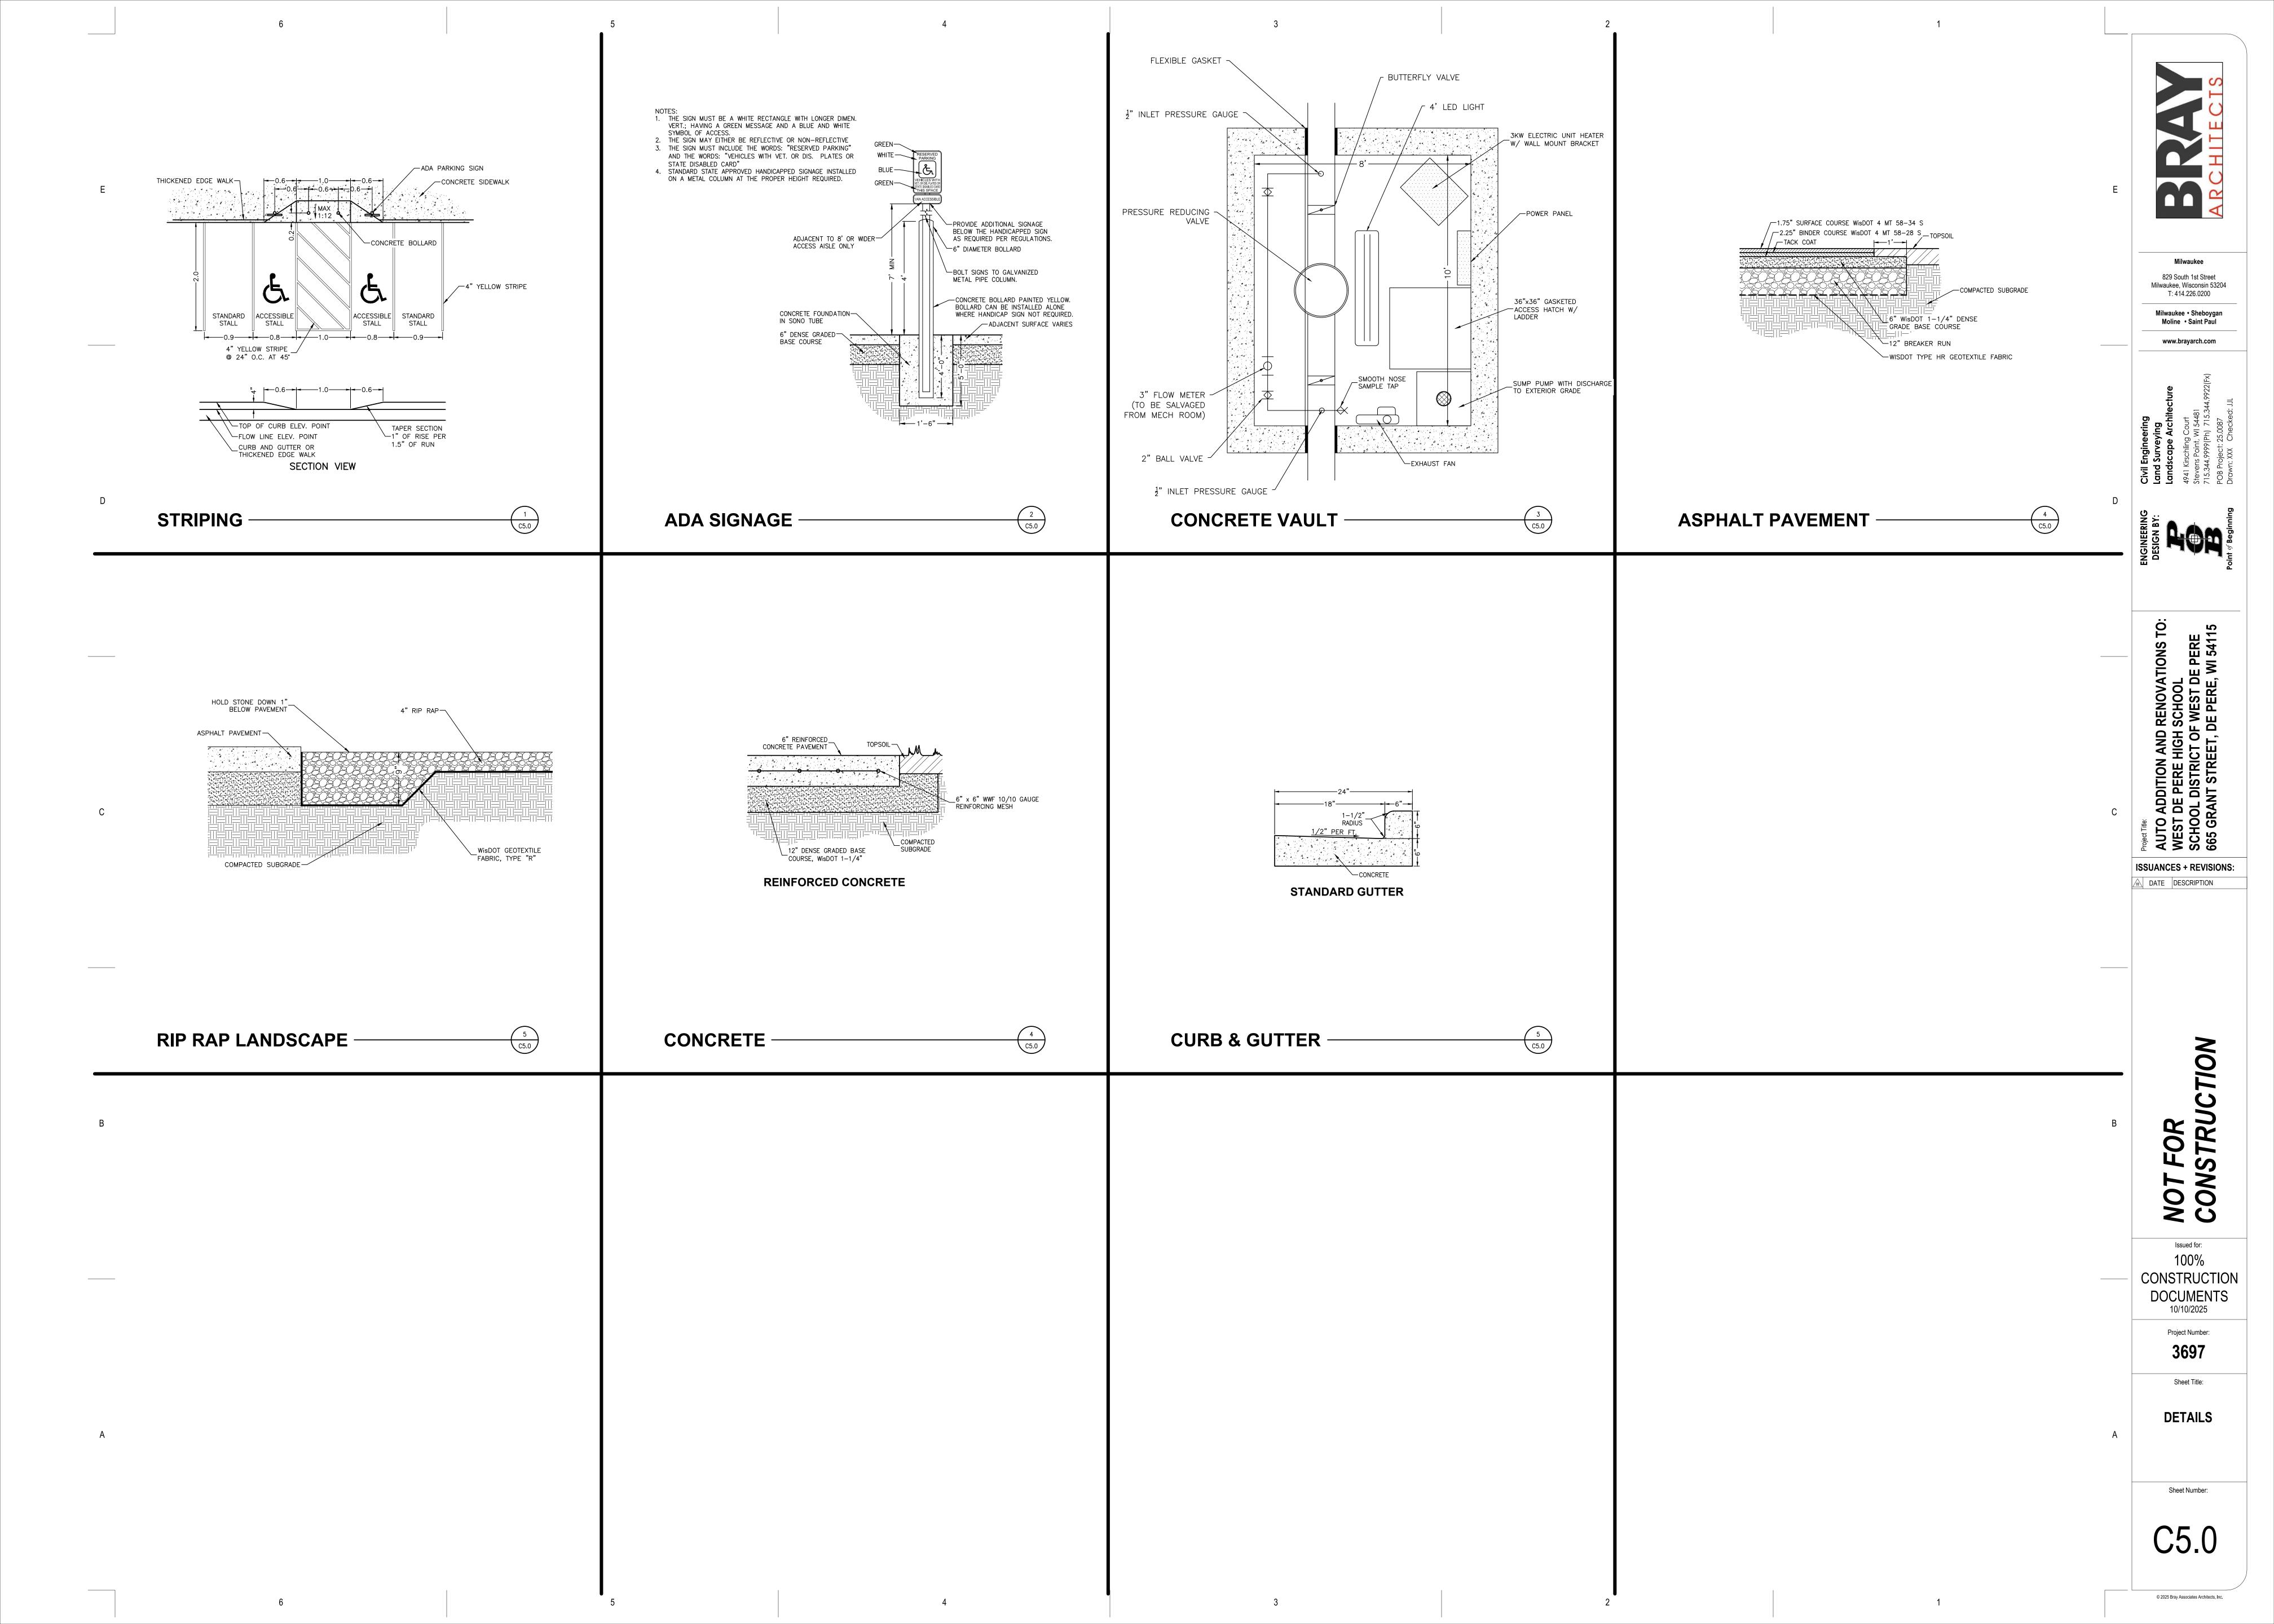
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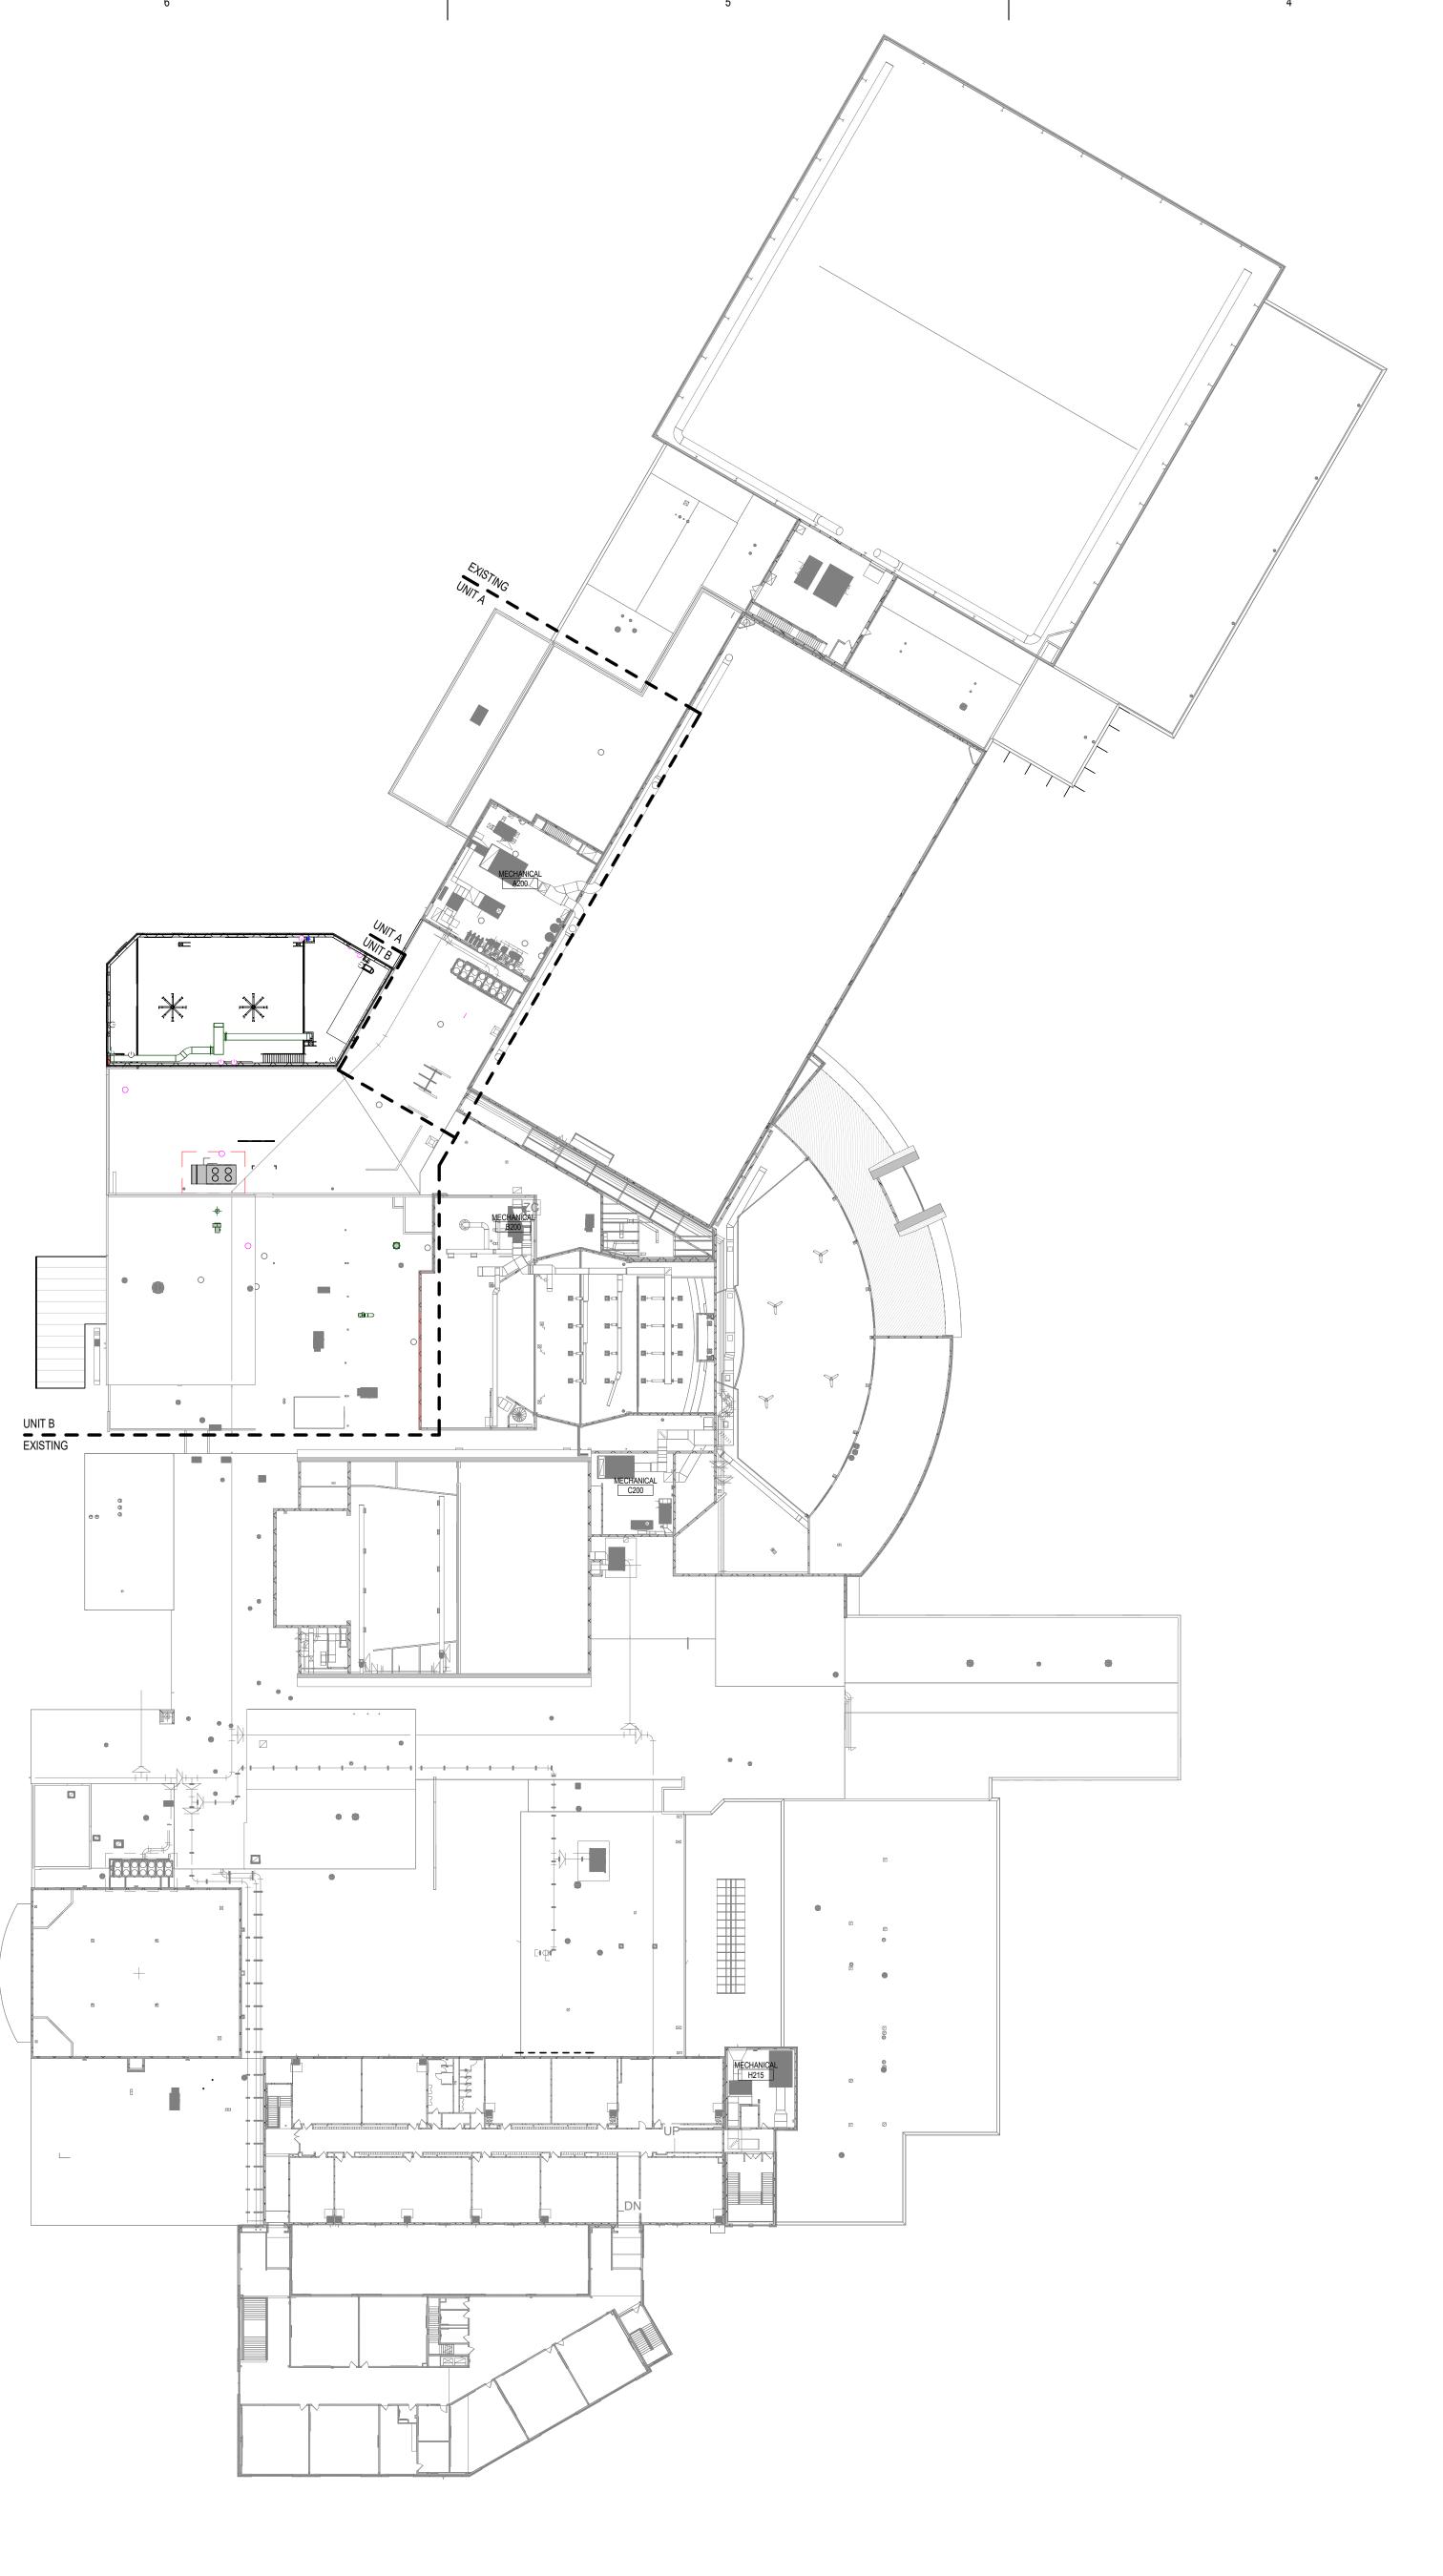
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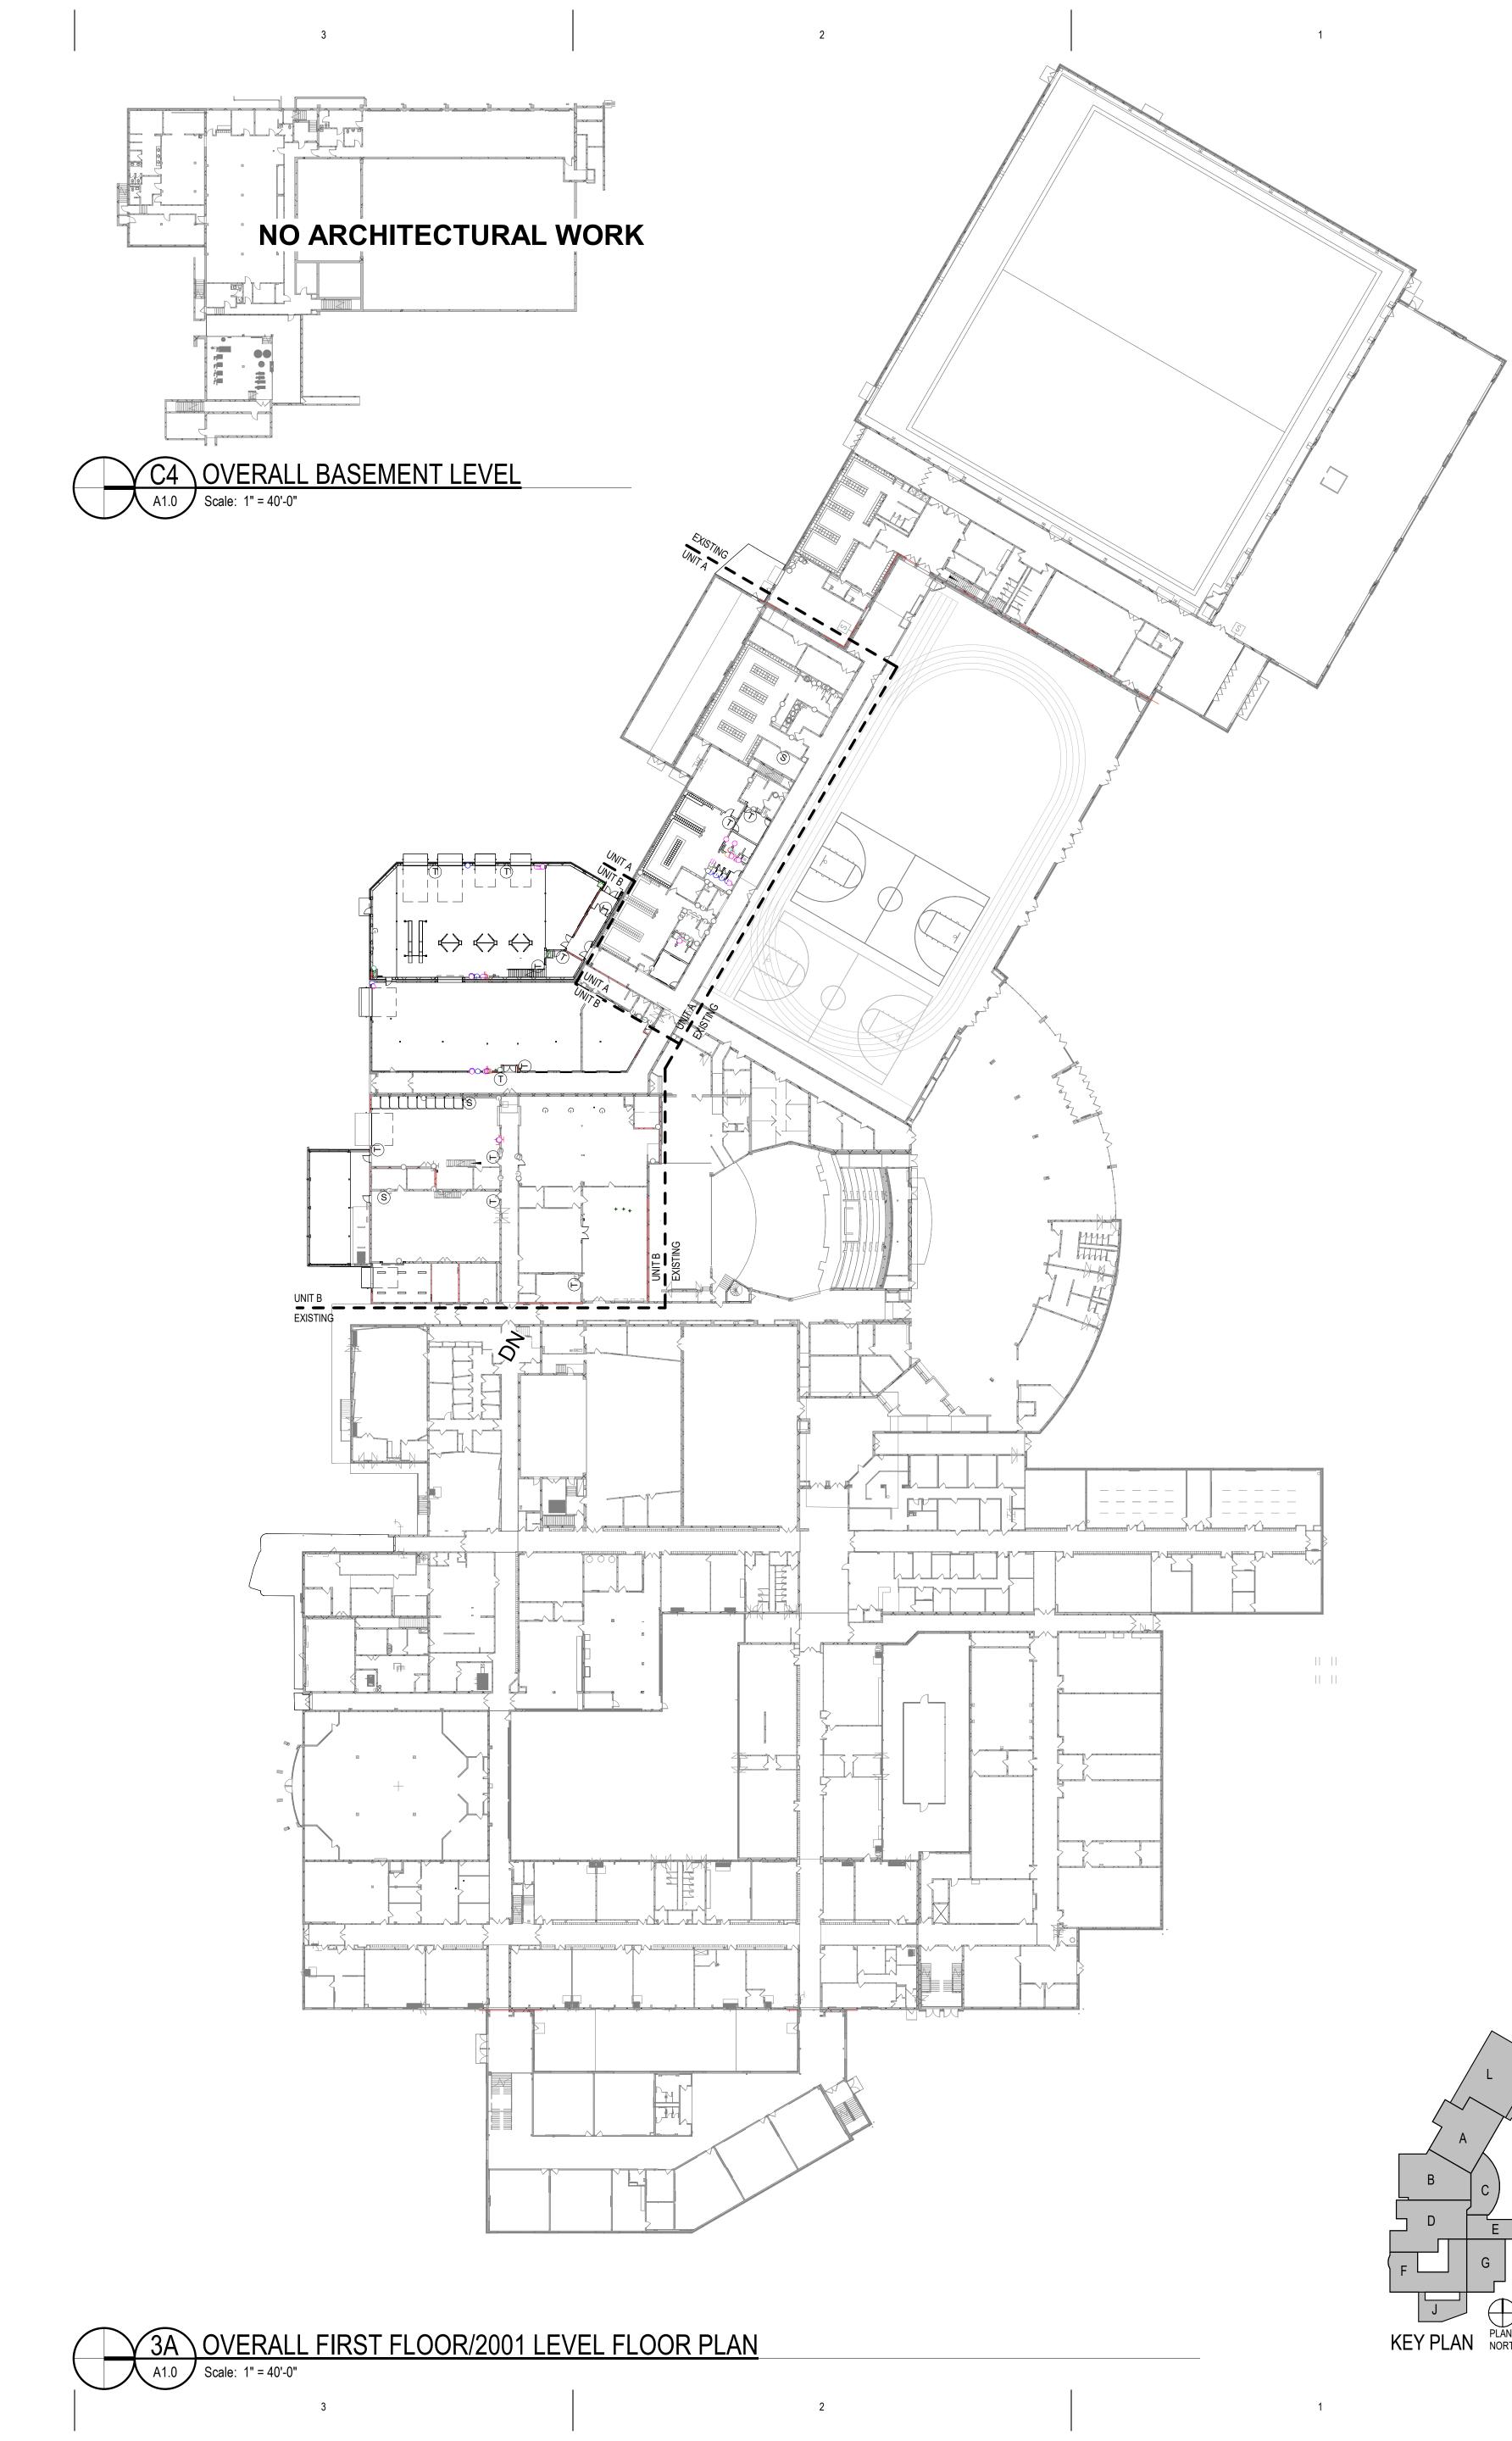
UTILITY

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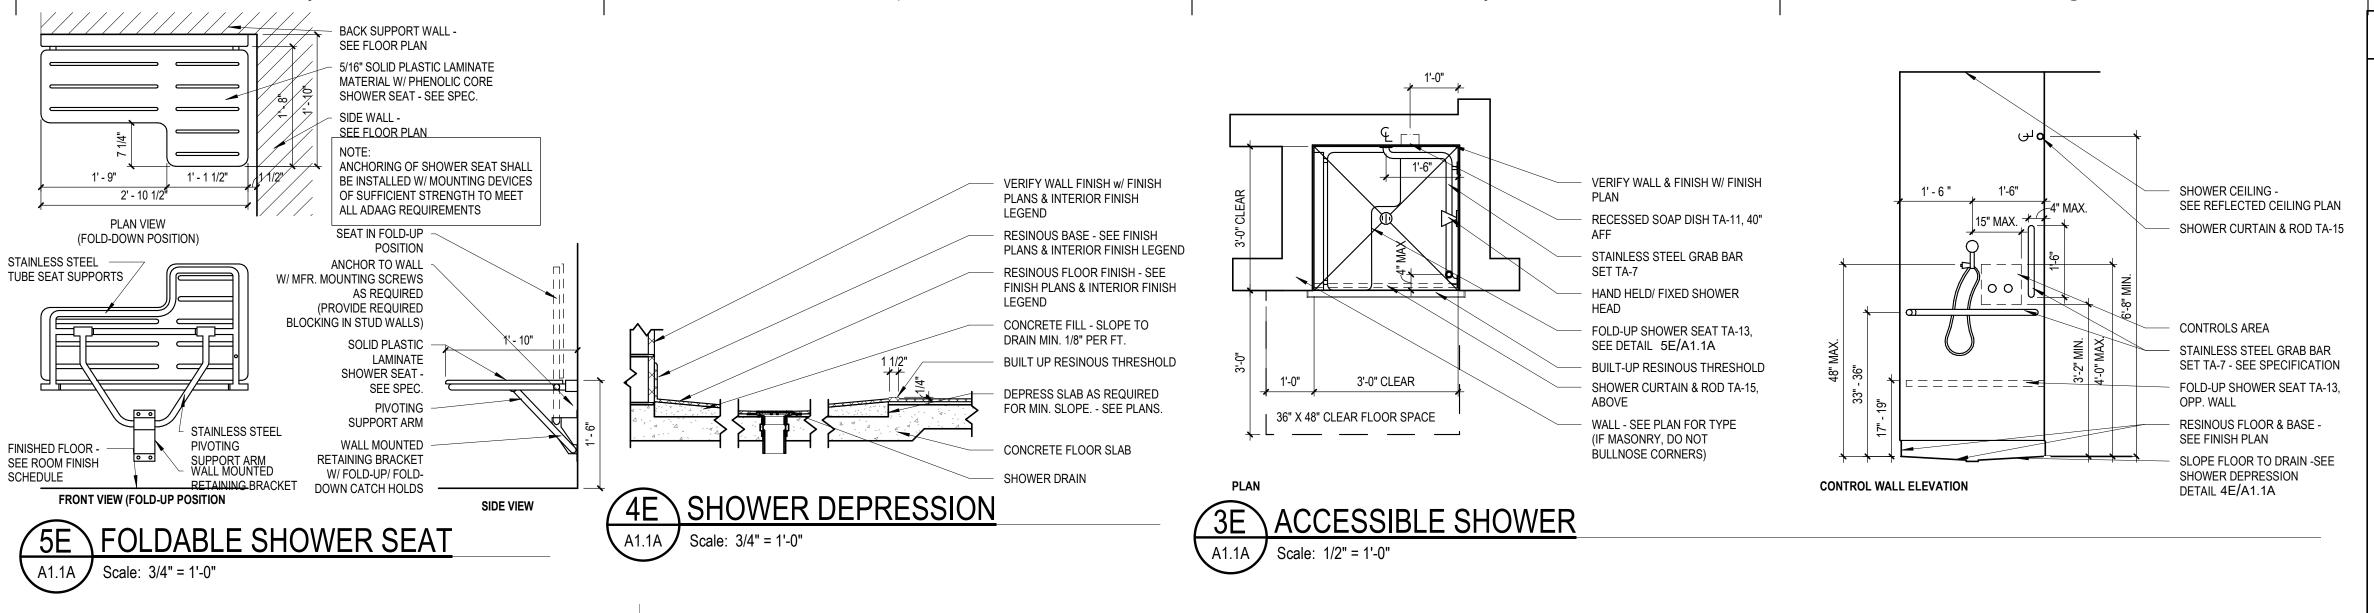
3697

OVERALL FLOOR PLANS

Sheet Number:

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6A OVERALL SECOND / MEZZANINE FLOOR PLAN



- 1. DO NOT SCALE FROM DRAWINGS.
- EXISTING CONDITIONS: EXISTING CONDITIONS SHOWN ON DRAWINGS REPRESENT CURRENT BUILDING. IT IS THE RESPONSIBILITY OF THE CONTRACTOR TO FIELD VERIFY EXISTING CONDITIONS PRIOR TO PERFORMING WORK. REPORT ANY DISCREPANCIES TO THE ARCHITECT FOR REVIEW. WORK DONE WITHOUT RESOLUTION OF DISCREPANCIES MUST BE REDONE AT THE REQUEST OF THE ARCHITECT AT NO ADDITIONAL COST TO THE CONTRACT.
- REFER TO SHEET AG1.2 FOR WALL TYPES. REFER TO SHEET G0.1 FOR RATED WALL LOCATIONS.
- REFER TO SHEET AG1.1 FOR TYPICAL MOUNTING HEIGHTS. REFER TO INTERIOR ELEVATION SHEETS FOR ROOM SPECIFIC FIXTURE MOUNTING HEIGHTS.
- REFER TO SHEET A9.0 FOR FLOOR TRANSITION DETAILS.
- REFER TO SHEET A9.0 FOR TYPICAL FLOOR/BASE CONDITIONS.
- DIMENSIONS FOR INTERIOR STUD WALLS ARE TO FACE OF WALL. EXTERIOR STUD WALLS ARE DIMENSIONED TO INTERIOR FACE OF STUDS. CMU WALLS ARE DIMENSIONED TO FACE OF WALL.
- IDENTIFY ALL RATED WALLS AND PARTITIONS WITH PAINTED LETTERING THAT READS "FIRE AND/OR SMOKE BARRIER - PROTECT ALL OPENINGS" ABOVE CEILINGS. LETTERING TO BE LOCATED WITHIN 15 FEET OF THE END OF EACH WALL AND AT INTERVALS NOT EXCEEDING 30'-0" O.C. HORIZONTALLY, BOTH SIDES OF WALL. LETTERING TO BE NOT LESS THAN 3" IN HEIGHT WITH A 3/8" MINIMUM STROKE IN A CONTRASTING COLOR. SEE SHEET G0.1 PLANS FOR LOCATION OF RATED
- REFER TO STRUCTURAL DRAWINGS FOR FIREPROOFING LOCATIONS. PROVIDE INTUMESCENT PAINT AT EXPOSED STEEL COLUMNS AND AT THE BOTTOM FLANGE OF STEEL LINTELS. PROVIDE SPRAYED FIRE-RESISTIVE MATERIAL AT STEEL BEAMS, ROOF DECK AND ROOF JOISTS UNLESS NOTED OTHERWISE.
- 10. REFER TO REFLECTED CEILING PLANS FOR LOCATION OF ALL WINDOW TREATMENTS.
- REQUIRED MEANS OF EGRESS FROM THE EXISTING BUILDING SHALL BE MAINTAINED AT ALL TIMES DURING CONSTRUCTION WHEN THE BUILDING REMAINS OCCUPIED. IN THE EVENT THAT AN EXISTING MEANS OF EGRESS CANNOT BE MAINTAINED, CONTRACTOR SHALL PROVIDE AN APPROVED TEMPORARY MEANS OF EGRESS.




SHOWER CURTAIN, CURTAIN ROD AND ACCESSORIES

TOILET COMPARTMENT (PARTITION)

 EXISTING MIRRORS INSTALLED BY OWNER EXISTING SHOWER STALL, SEE FINISH PLANS FOR FLOOR & BASE WORK

\UNIT A - 2001 LEVEL ENLARGED PLAN - A112 & A113

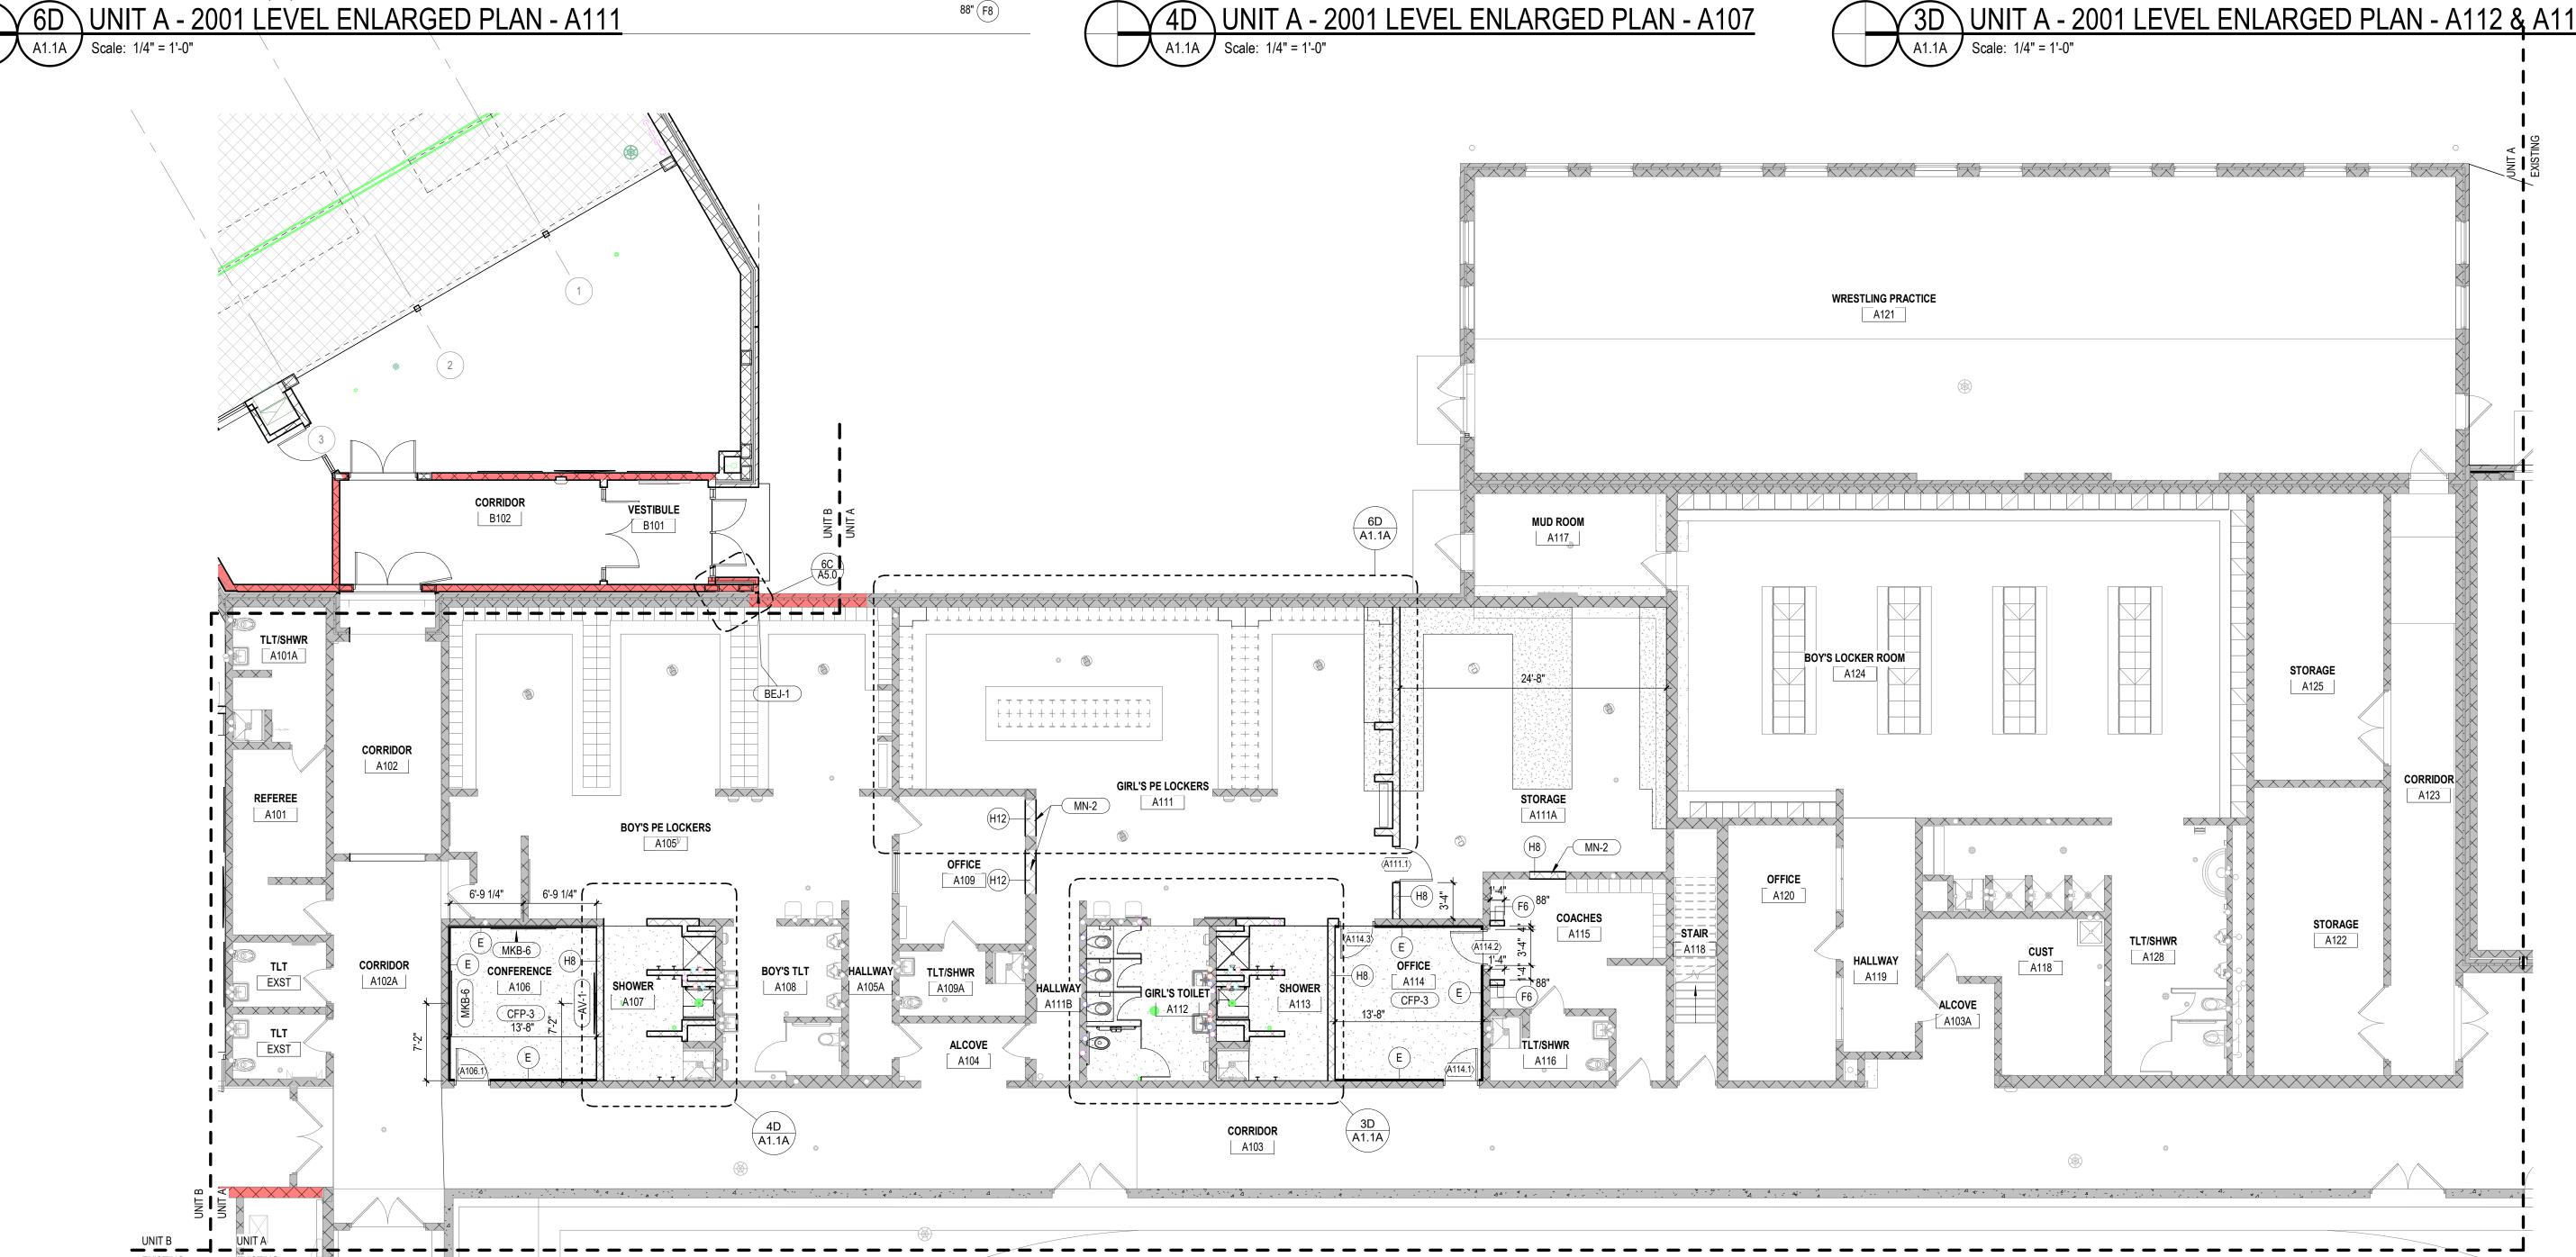

EXISTING SHOWER STALL, SEE FINISH PLANS FOR FLOOR & BASE WORK

UNIT A - 2001 LEVEL ENLARGED PLAN - A107

+ + +

+ + +

EXISTING BENCH

10'-8"

REINSTALLED BY


++++++++++++++

EXISTING CONCRETE BENCH,

GIRL'S PE LOCKERS

A111

PAINT, PT-2

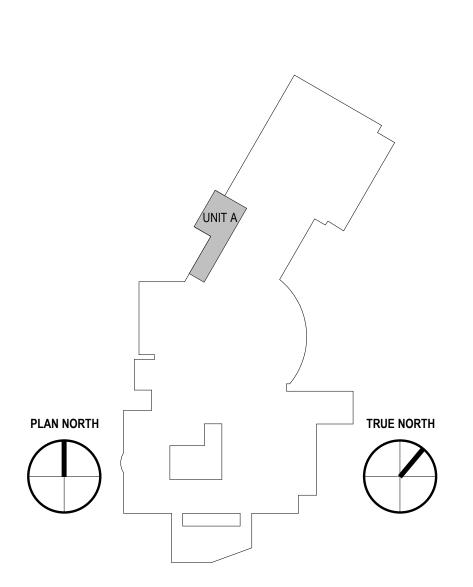

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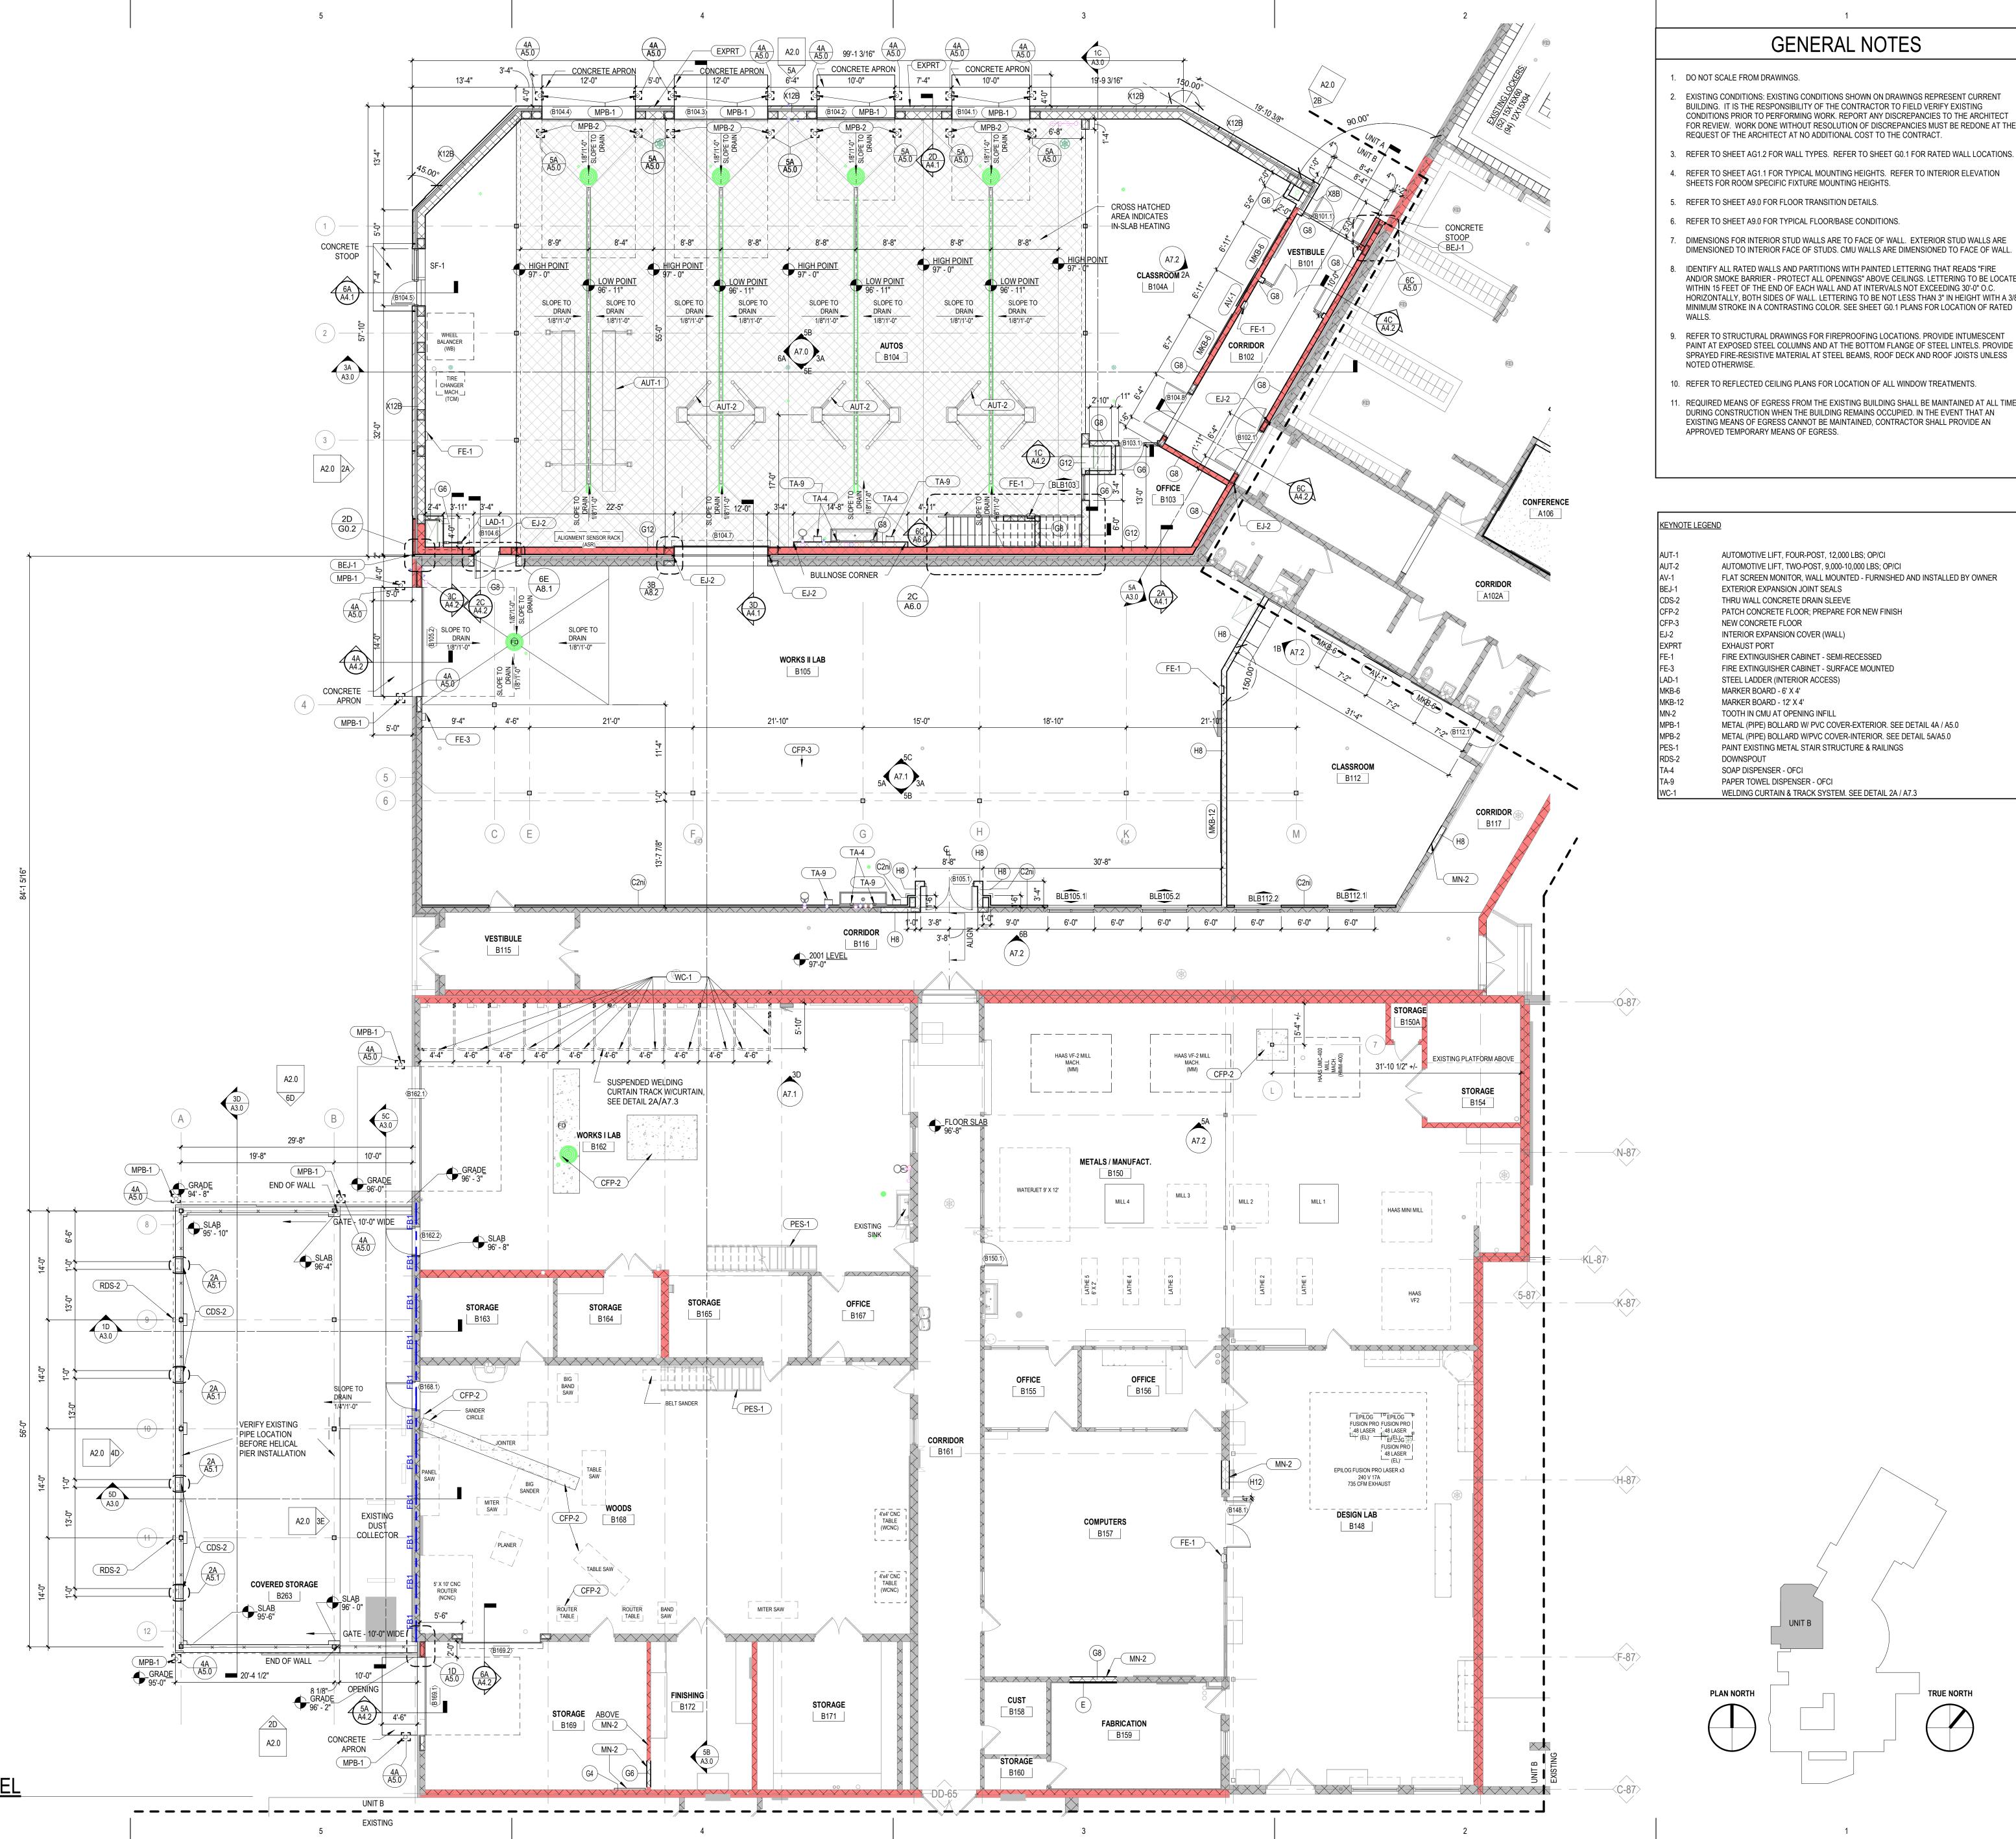
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Sheet Title:

UNIT A - 2001 LEVEL FLOOR PLAN

Sheet Number:

\ UNIT A - 2001 LEVEL



- 1. DO NOT SCALE FROM DRAWINGS.
- EXISTING CONDITIONS: EXISTING CONDITIONS SHOWN ON DRAWINGS REPRESENT CURRENT BUILDING. IT IS THE RESPONSIBILITY OF THE CONTRACTOR TO FIELD VERIFY EXISTING CONDITIONS PRIOR TO PERFORMING WORK. REPORT ANY DISCREPANCIES TO THE ARCHITECT FOR REVIEW. WORK DONE WITHOUT RESOLUTION OF DISCREPANCIES MUST BE REDONE AT THE REQUEST OF THE ARCHITECT AT NO ADDITIONAL COST TO THE CONTRACT.
- REFER TO SHEET AG1.2 FOR WALL TYPES. REFER TO SHEET G0.1 FOR RATED WALL LOCATIONS.
- REFER TO SHEET AG1.1 FOR TYPICAL MOUNTING HEIGHTS. REFER TO INTERIOR ELEVATION SHEETS FOR ROOM SPECIFIC FIXTURE MOUNTING HEIGHTS.
- 5. REFER TO SHEET A9.0 FOR FLOOR TRANSITION DETAILS.
- 6. REFER TO SHEET A9.0 FOR TYPICAL FLOOR/BASE CONDITIONS.
- DIMENSIONS FOR INTERIOR STUD WALLS ARE TO FACE OF WALL. EXTERIOR STUD WALLS ARE
- IDENTIFY ALL RATED WALLS AND PARTITIONS WITH PAINTED LETTERING THAT READS "FIRE AND/OR SMOKE BARRIER - PROTECT ALL OPENINGS" ABOVE CEILINGS. LETTERING TO BE LOCATED WITHIN 15 FEET OF THE END OF EACH WALL AND AT INTERVALS NOT EXCEEDING 30'-0" O.C. HORIZONTALLY, BOTH SIDES OF WALL. LETTERING TO BE NOT LESS THAN 3" IN HEIGHT WITH A 3/8" MINIMUM STROKE IN A CONTRASTING COLOR. SEE SHEET G0.1 PLANS FOR LOCATION OF RATED
- REFER TO STRUCTURAL DRAWINGS FOR FIREPROOFING LOCATIONS. PROVIDE INTUMESCENT PAINT AT EXPOSED STEEL COLUMNS AND AT THE BOTTOM FLANGE OF STEEL LINTELS. PROVIDE SPRAYED FIRE-RESISTIVE MATERIAL AT STEEL BEAMS, ROOF DECK AND ROOF JOISTS UNLESS NOTED OTHERWISE.
- 10. REFER TO REFLECTED CEILING PLANS FOR LOCATION OF ALL WINDOW TREATMENTS.
- I. REQUIRED MEANS OF EGRESS FROM THE EXISTING BUILDING SHALL BE MAINTAINED AT ALL TIMES DURING CONSTRUCTION WHEN THE BUILDING REMAINS OCCUPIED. IN THE EVENT THAT AN EXISTING MEANS OF EGRESS CANNOT BE MAINTAINED, CONTRACTOR SHALL PROVIDE AN APPROVED TEMPORARY MEANS OF EGRESS.

KEYNOTE LEGEND

AUTOMOTIVE LIFT, FOUR-POST, 12,000 LBS; OP/CI

AUTOMOTIVE LIFT, TWO-POST, 9,000-10,000 LBS; OP/CI FLAT SCREEN MONITOR, WALL MOUNTED - FURNISHED AND INSTALLED BY OWNER

EXTERIOR EXPANSION JOINT SEALS

THRU WALL CONCRETE DRAIN SLEEVE PATCH CONCRETE FLOOR; PREPARE FOR NEW FINISH

NEW CONCRETE FLOOR INTERIOR EXPANSION COVER (WALL)

EXHAUST PORT FIRE EXTINGUISHER CABINET - SEMI-RECESSED

FIRE EXTINGUISHER CABINET - SURFACE MOUNTED

STEEL LADDER (INTERIOR ACCESS)

MARKER BOARD - 6' X 4' MARKER BOARD - 12' X 4'

TOOTH IN CMU AT OPENING INFILL

METAL (PIPE) BOLLARD W/ PVC COVER-EXTERIOR. SEE DETAIL 4A / A5.0 METAL (PIPE) BOLLARD W/PVC COVER-INTERIOR. SEE DETAIL 5A/A5.0

PAINT EXISTING METAL STAIR STRUCTURE & RAILINGS DOWNSPOUT

SOAP DISPENSER - OFCI PAPER TOWEL DISPENSER - OFCI

PLAN NORTH

WELDING CURTAIN & TRACK SYSTEM. SEE DETAIL 2A / A7.3



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JTO ADDITION AND RENOVATI EST DE PERE HIGH SCHOOL HOOL DISTRICT OF WEST DE 5 GRANT STREET, DE PERE, M

DATE DESCRIPTION

1 08/15/2025 DESIGN DEVELOPMENT

2 09/19/2025 50% CONSTRUCTION DOCUMENTS

3 10/10/2025 DOCUMENTS

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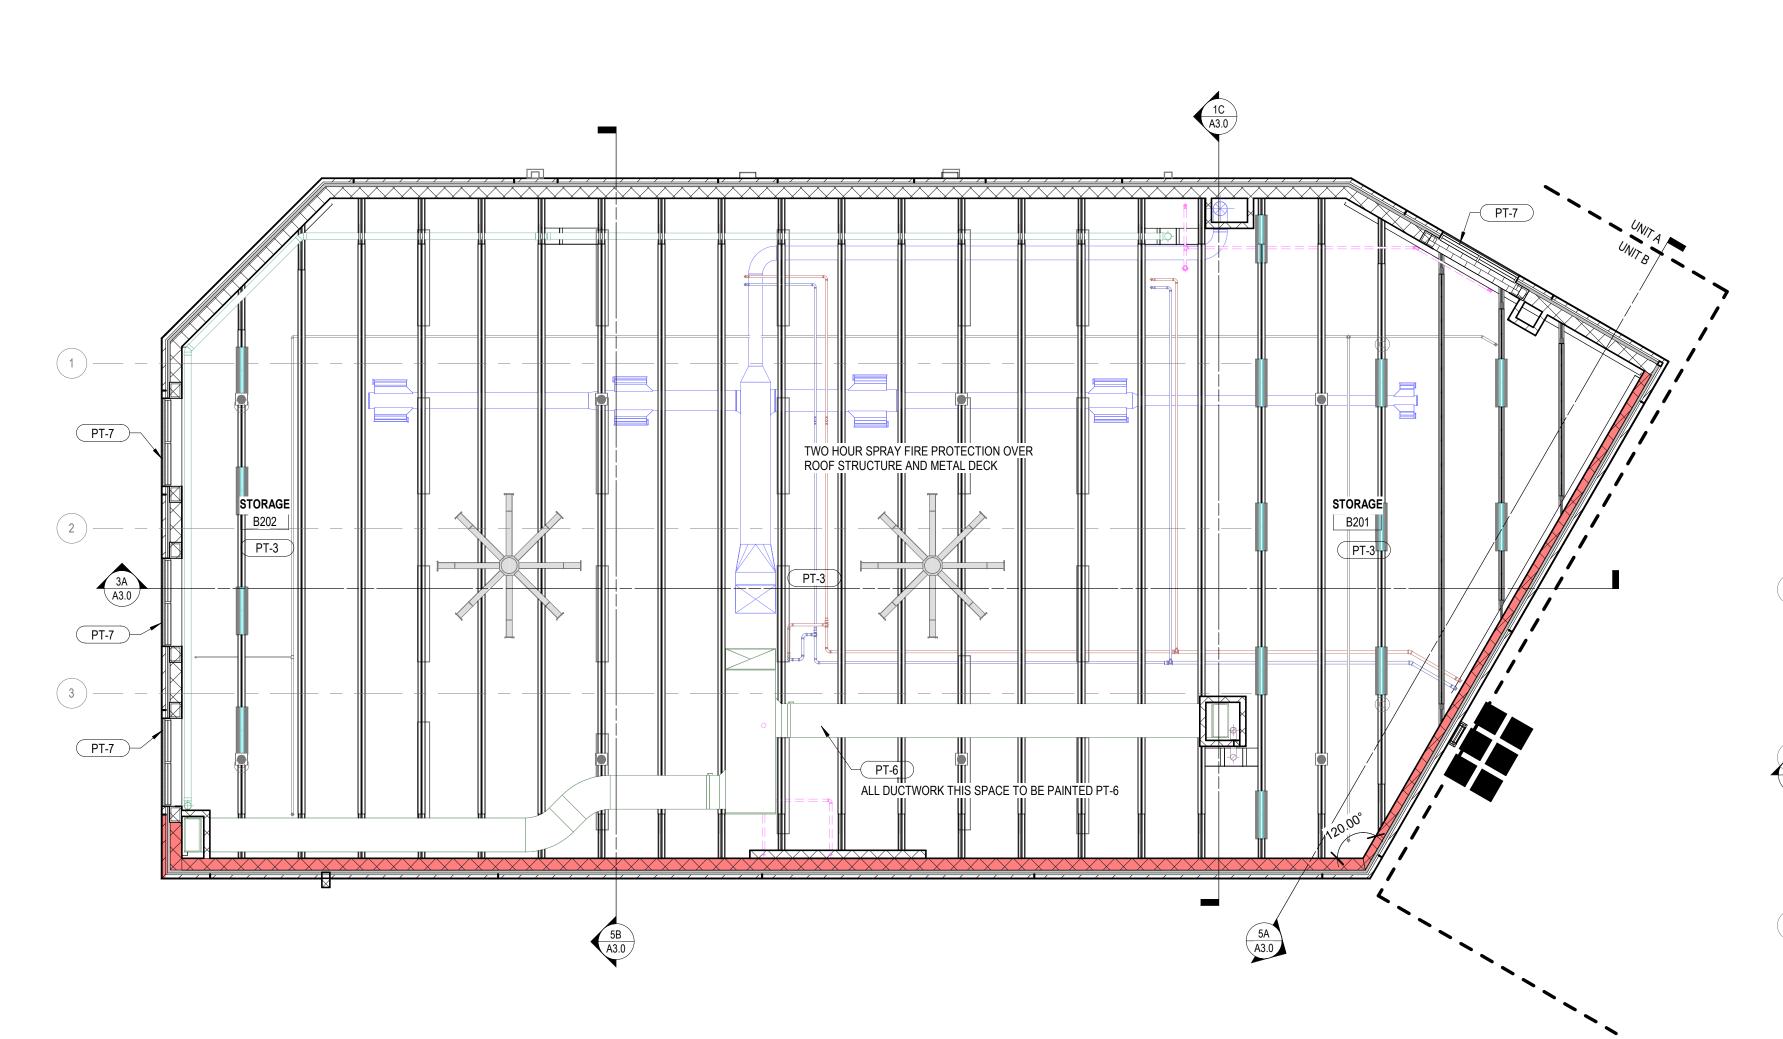
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2025-10-31


Sheet Title:

UNIT B - 2001 LEVEL FLOOR PLAN

Sheet Number:



6C UNIT B - AUTO SHOP MEZZANINE RCP Scale: 1/8" = 1'-0"

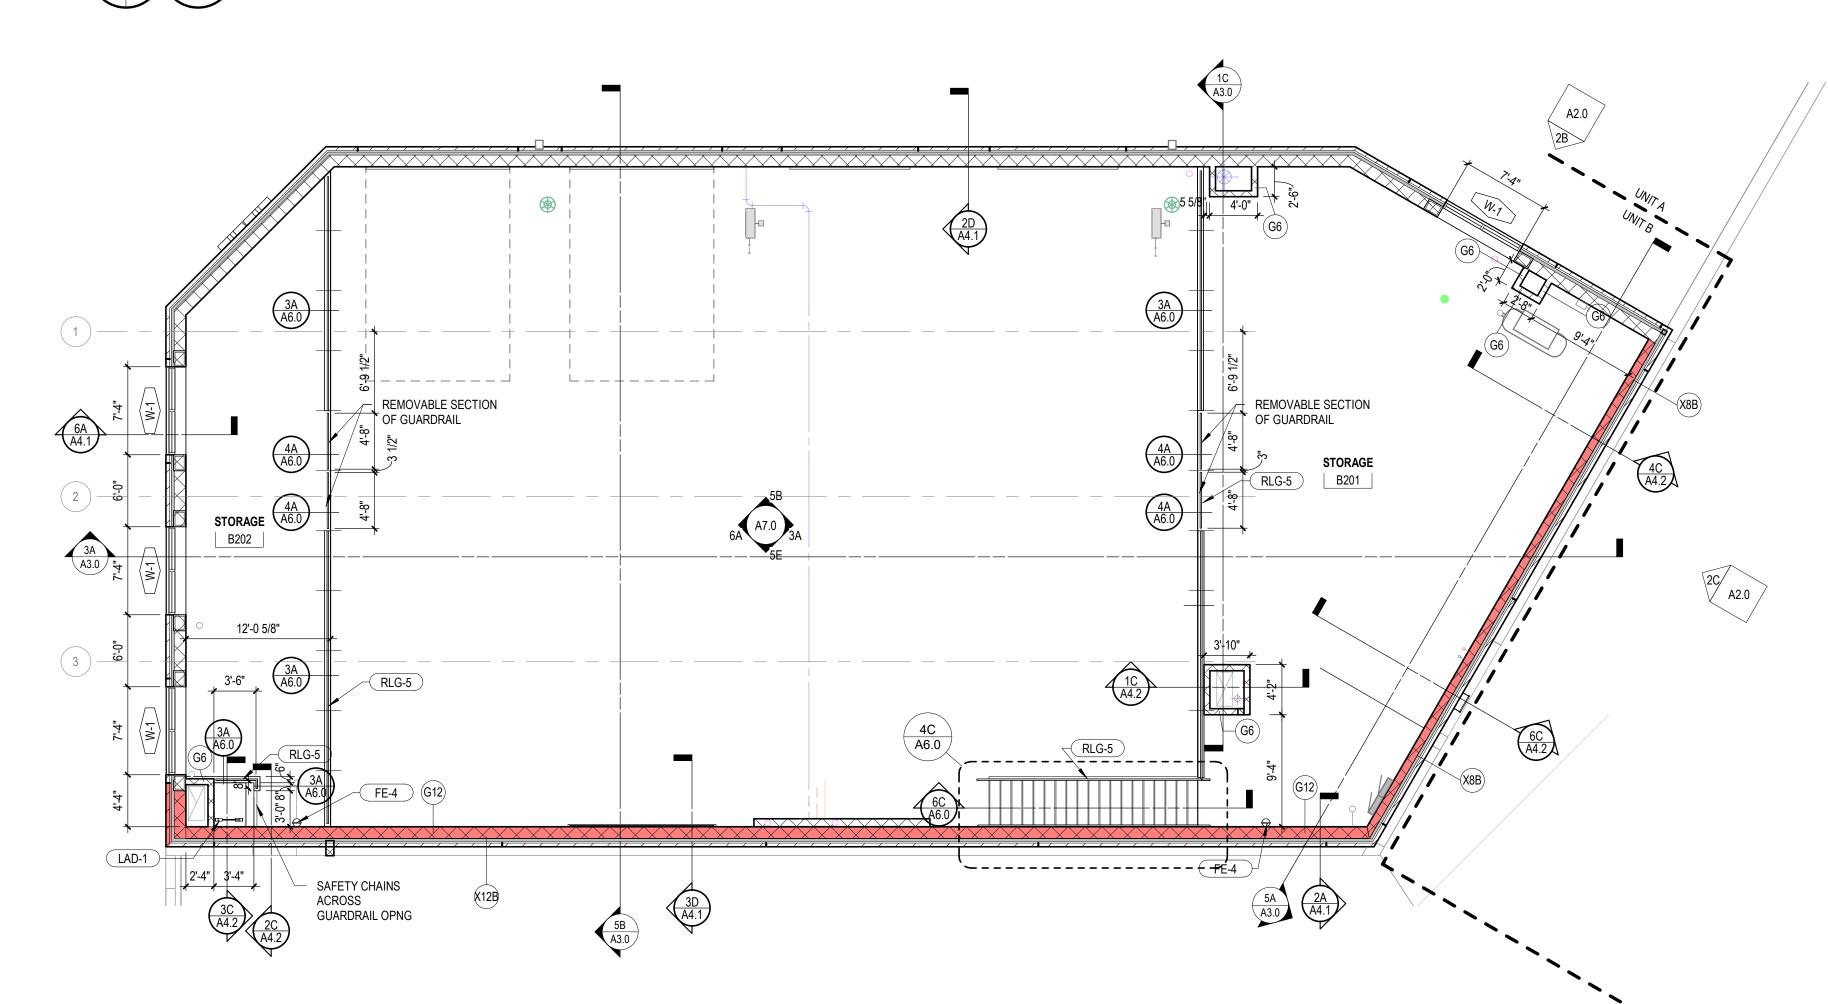

6A UNIT B - AUTO SHOP MEZZANINE A1.2B / Scale: 1/8" = 1'-0"

GENERAL NOTES

- 1. DO NOT SCALE FROM DRAWINGS.
- EXISTING CONDITIONS: EXISTING CONDITIONS SHOWN ON DRAWINGS REPRESENT CURRENT BUILDING. IT IS THE RESPONSIBILITY OF THE CONTRACTOR TO FIELD VERIFY EXISTING CONDITIONS PRIOR TO PERFORMING WORK. REPORT ANY DISCREPANCIES TO THE ARCHITECT FOR REVIEW. WORK DONE WITHOUT RESOLUTION OF DISCREPANCIES MUST BE REDONE AT THE REQUEST OF THE ARCHITECT AT NO ADDITIONAL COST TO THE CONTRACT.
- REFER TO SHEET AG1.2 FOR WALL TYPES. REFER TO SHEET G0.1 FOR RATED WALL LOCATIONS.
- REFER TO SHEET AG1.1 FOR TYPICAL MOUNTING HEIGHTS. REFER TO INTERIOR ELEVATION SHEETS FOR ROOM SPECIFIC FIXTURE MOUNTING HEIGHTS.
- 5. REFER TO SHEET A9.0 FOR FLOOR TRANSITION DETAILS.
- 6. REFER TO SHEET A9.0 FOR TYPICAL FLOOR/BASE CONDITIONS.
- DIMENSIONS FOR INTERIOR STUD WALLS ARE TO FACE OF WALL. EXTERIOR STUD WALLS ARE
- IDENTIFY ALL RATED WALLS AND PARTITIONS WITH PAINTED LETTERING THAT READS "FIRE AND/OR SMOKE BARRIER - PROTECT ALL OPENINGS" ABOVE CEILINGS. LETTERING TO BE LOCATED WITHIN 15 FEET OF THE END OF EACH WALL AND AT INTERVALS NOT EXCEEDING 30'-0" O.C. HORIZONTALLY, BOTH SIDES OF WALL. LETTERING TO BE NOT LESS THAN 3" IN HEIGHT WITH A 3/8" MINIMUM STROKE IN A CONTRASTING COLOR. SEE SHEET G0.1 PLANS FOR LOCATION OF RATED

DIMENSIONED TO INTERIOR FACE OF STUDS. CMU WALLS ARE DIMENSIONED TO FACE OF WALL.

- REFER TO STRUCTURAL DRAWINGS FOR FIREPROOFING LOCATIONS. PROVIDE INTUMESCENT PAINT AT EXPOSED STEEL COLUMNS AND AT THE BOTTOM FLANGE OF STEEL LINTELS. PROVIDE SPRAYED FIRE-RESISTIVE MATERIAL AT STEEL BEAMS, ROOF DECK AND ROOF JOISTS UNLESS NOTED OTHERWISE.
- 10. REFER TO REFLECTED CEILING PLANS FOR LOCATION OF ALL WINDOW TREATMENTS. 11. REQUIRED MEANS OF EGRESS FROM THE EXISTING BUILDING SHALL BE MAINTAINED AT ALL TIMES DURING CONSTRUCTION WHEN THE BUILDING REMAINS OCCUPIED. IN THE EVENT THAT AN EXISTING MEANS OF EGRESS CANNOT BE MAINTAINED, CONTRACTOR SHALL PROVIDE AN

KEYNOTE LEGEND

PAINT ALL EXPOSED DECK, STRUCTURE, PIPES, DUCTS, AND CONDUIT. SEE RCP FOR PAINT

FIRE EXTINGUISHER AND BRACKET

APPROVED TEMPORARY MEANS OF EGRESS.

PAINT EXISTING METAL STAIR STRUCTURE & RAILINGS

PAINT EXISTING METAL GUARD & HANDRAIL

PAINT - SEE INTERIOR FINISH LEGEND


STEEL LADDER (INTERIOR ACCESS) PAINT - SEE INTERIOR FINISH LEGEND

PAINT - SEE INTERIOR FINISH LEGEND PIPE AND TUBE METAL GUARDRAIL

PLAN NORTH

___MM-65 WOODS MEZZ. WORKS II MEZZ. <20-65>

3C UNIT B - WOODS MEZZANINE RCP

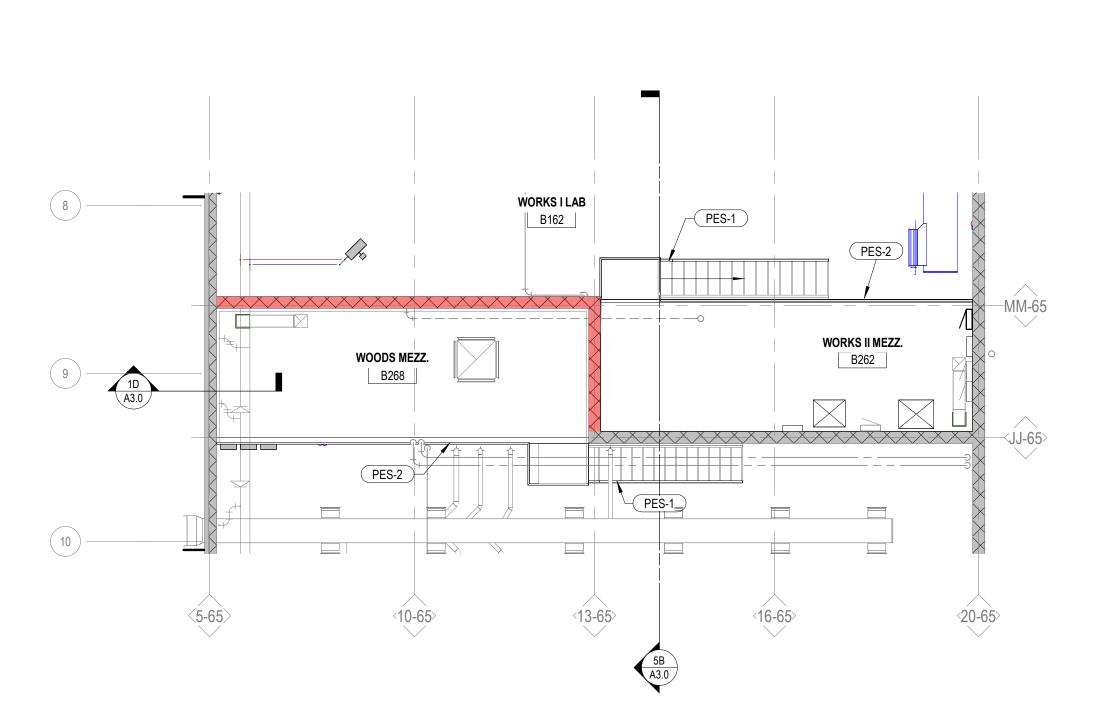

3A WOOD SHOP MEZZANINE



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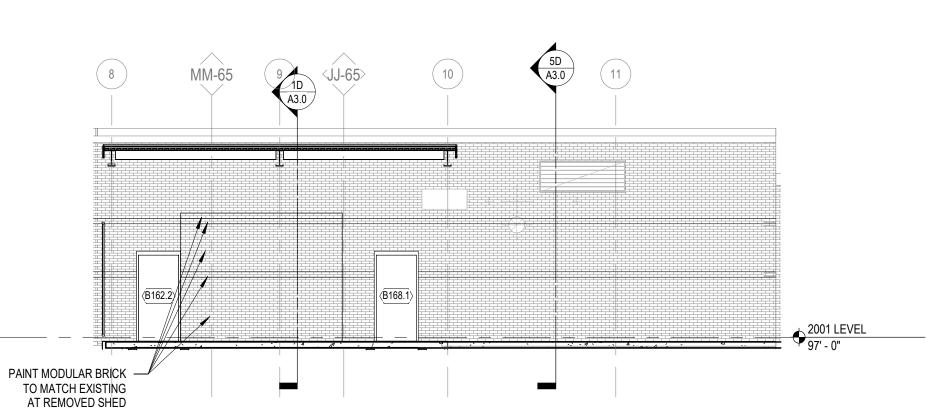
CONSTRUCTION **DOCUMENTS**

> Project Number: 3697

Sheet Title: UNIT B -**MEZZANINE PLAN & RCP**


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A1.2B




3E UNIT B - COVERED STORAGE WEST

A2.0 Scale: 1/8" = 1'-0"

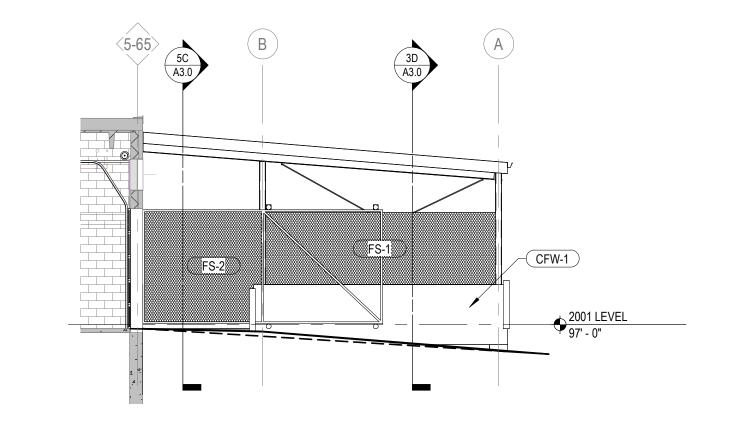


6D UNIT B - SHED ADDITION - NORTH

A2.0 Scale: 1/8" = 1'-0"

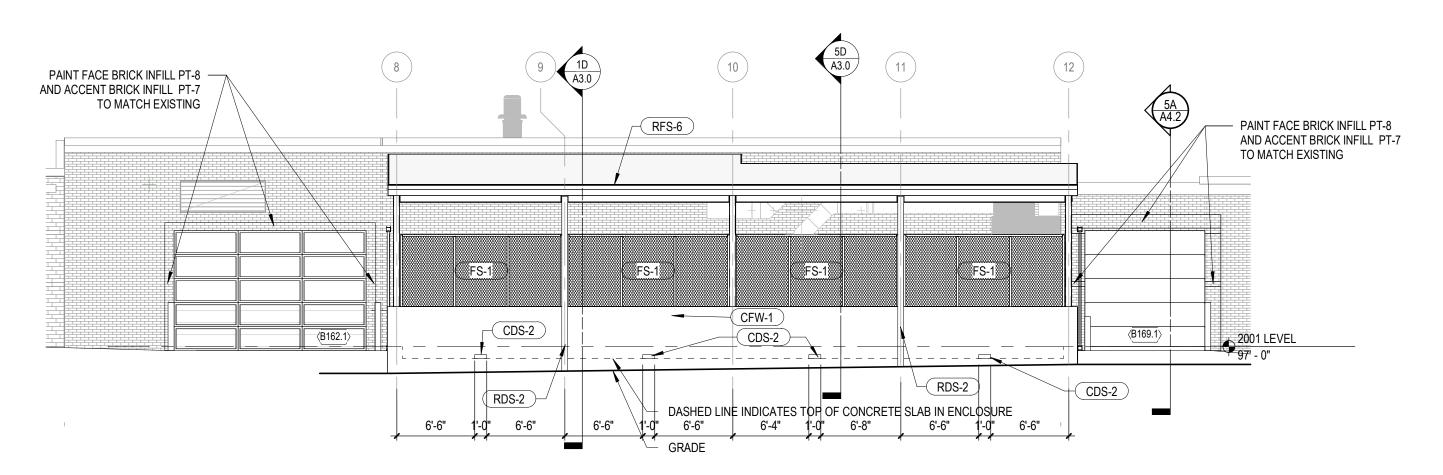

4D UNIT B - SHED ADDITION -WEST

A2.0 Scale: 1/8" = 1'-0"

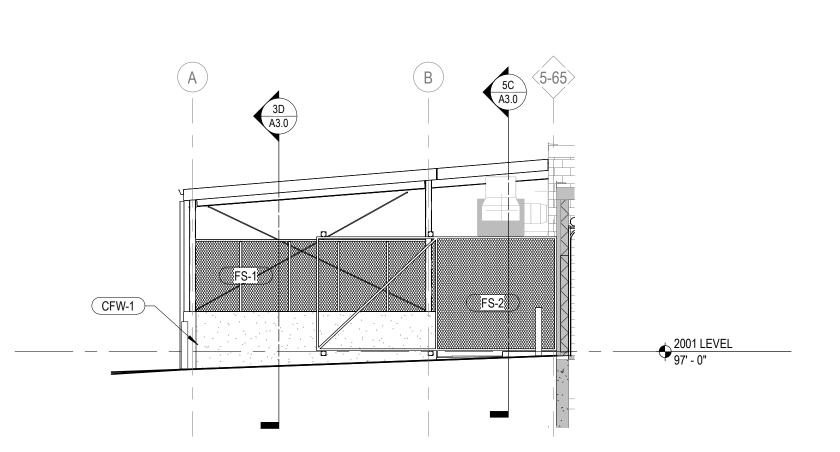

2D UNIT B - SHED ADDITION - SOUTH
A2.0 Scale: 1/8" = 1'-0"

KEYNOTE LEGEND

THRU WALL CONCRETE DRAIN SLEEVE

FACE BRICK, 1/2" RECESS WITH MORTAR WASH

MASONRY MOVEMENT JOINT (EXPANSION)

STEEL LADDER (ROOF). SEE 1B / A5.0

FACE BRICK

FLASHING


GUTTER


ROOF EDGE FASCIA
THRU WALL SCUPPER UNIT


CAST-IN-PLACE CONCRETE FOUNDATION WALL. FILL AND RUB CONCRETE. PAINT PT-7

6'-0" H CHAIN LINK FENCE SYSTEM, SEE CIVIL PLANS AND SPECIFICATIONS 9'-6" "H SLIDING CHAIN LINK GATE. SEE CIVIL PLANS AND SPECIFICATIONS.

METAL (PIPE) BOLLARD W/ PVC COVER-EXTERIOR. SEE DETAIL 4A / A5.0

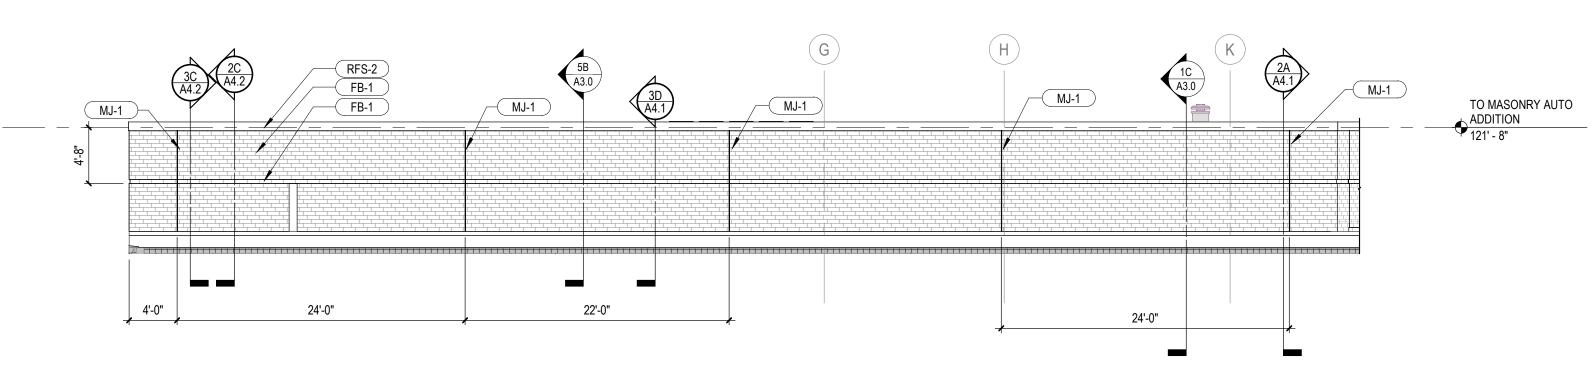


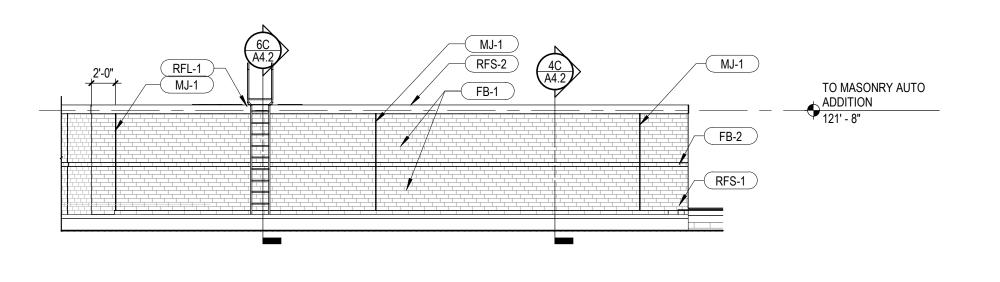

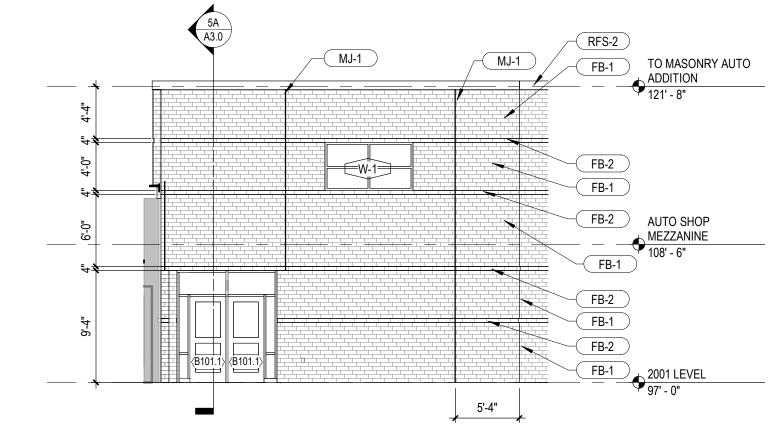



6B UNIT B - SOUTH ELEVATION

A2.0 Scale: 1/8" = 1'-0"

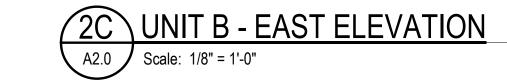



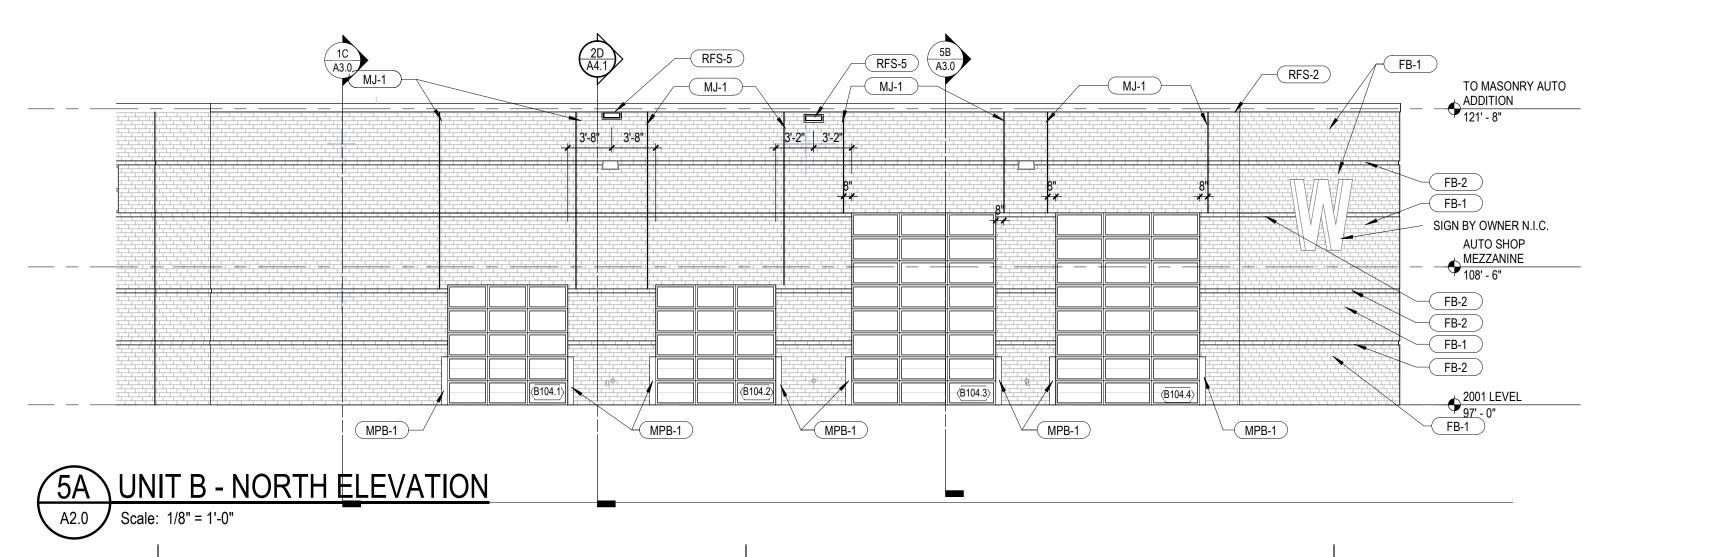

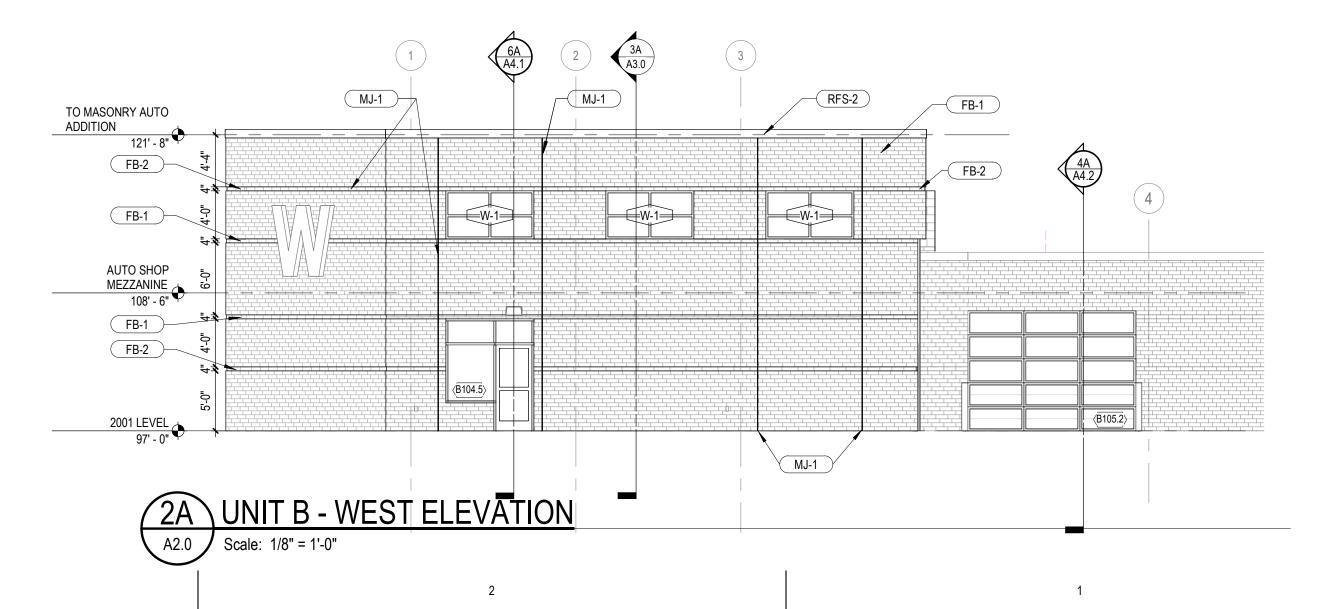

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AUTO ADDITION AND RENOVATIONS TO:
WEST DE PERE HIGH SCHOOL
SCHOOL DISTRICT OF WEST DE PERE
665 GRANT STREET, DE PERE, WI 54115

DATE DESCRIPTION

1 08/15/2025 DESIGN DEVELOPMENT

2 10/10/2025 100% CONSTRUCTION DOCUMENTS

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CONSTRUCTION DOCUMENTS

2025-10-31

Project Number: 3697


Sheet Title:

EXTERIOR

ELEVATIONS

Sheet Number:

A2.0

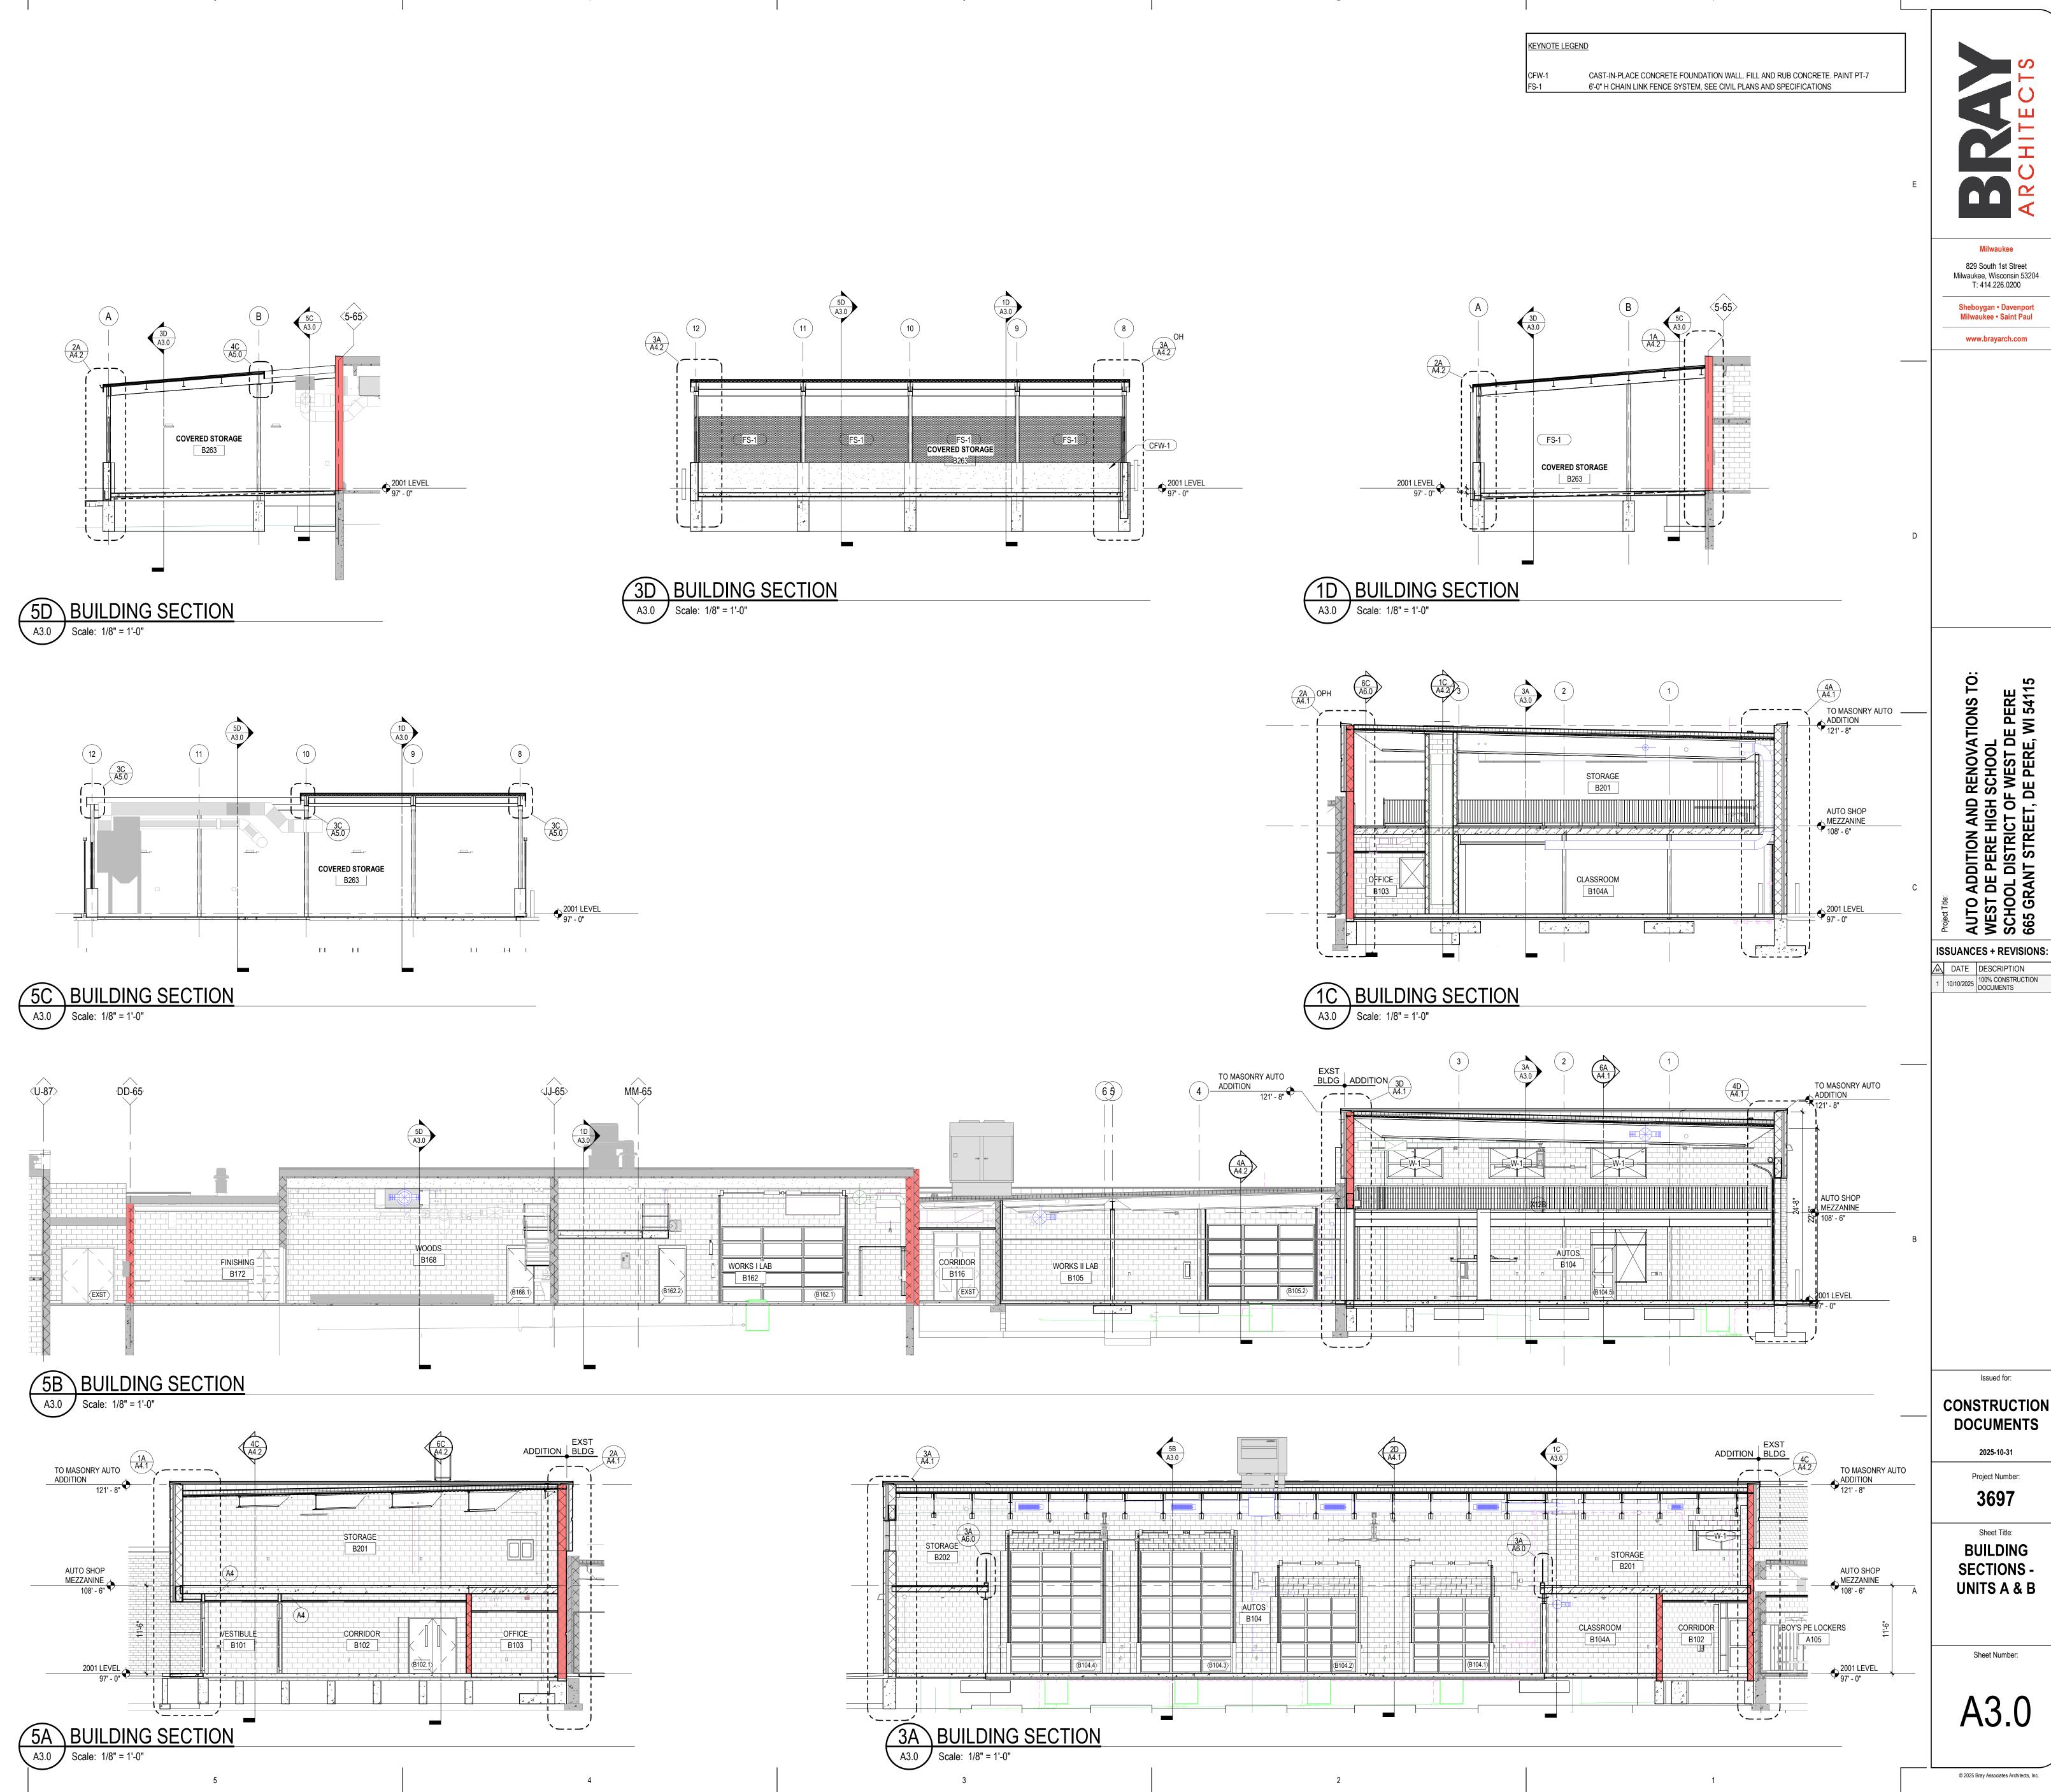

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WEST DE PERE HIGH SCHOOL
SCHOOL DISTRICT OF WEST DE PERE
665 GRANT STREET, DE PERE, WI 54115

Issued for:

CONSTRUCTION **DOCUMENTS**

> Project Number: 3697


2025-10-31


Sheet Title: **BUILDING**

SECTIONS -UNITS A & B

Sheet Number:

A3.0

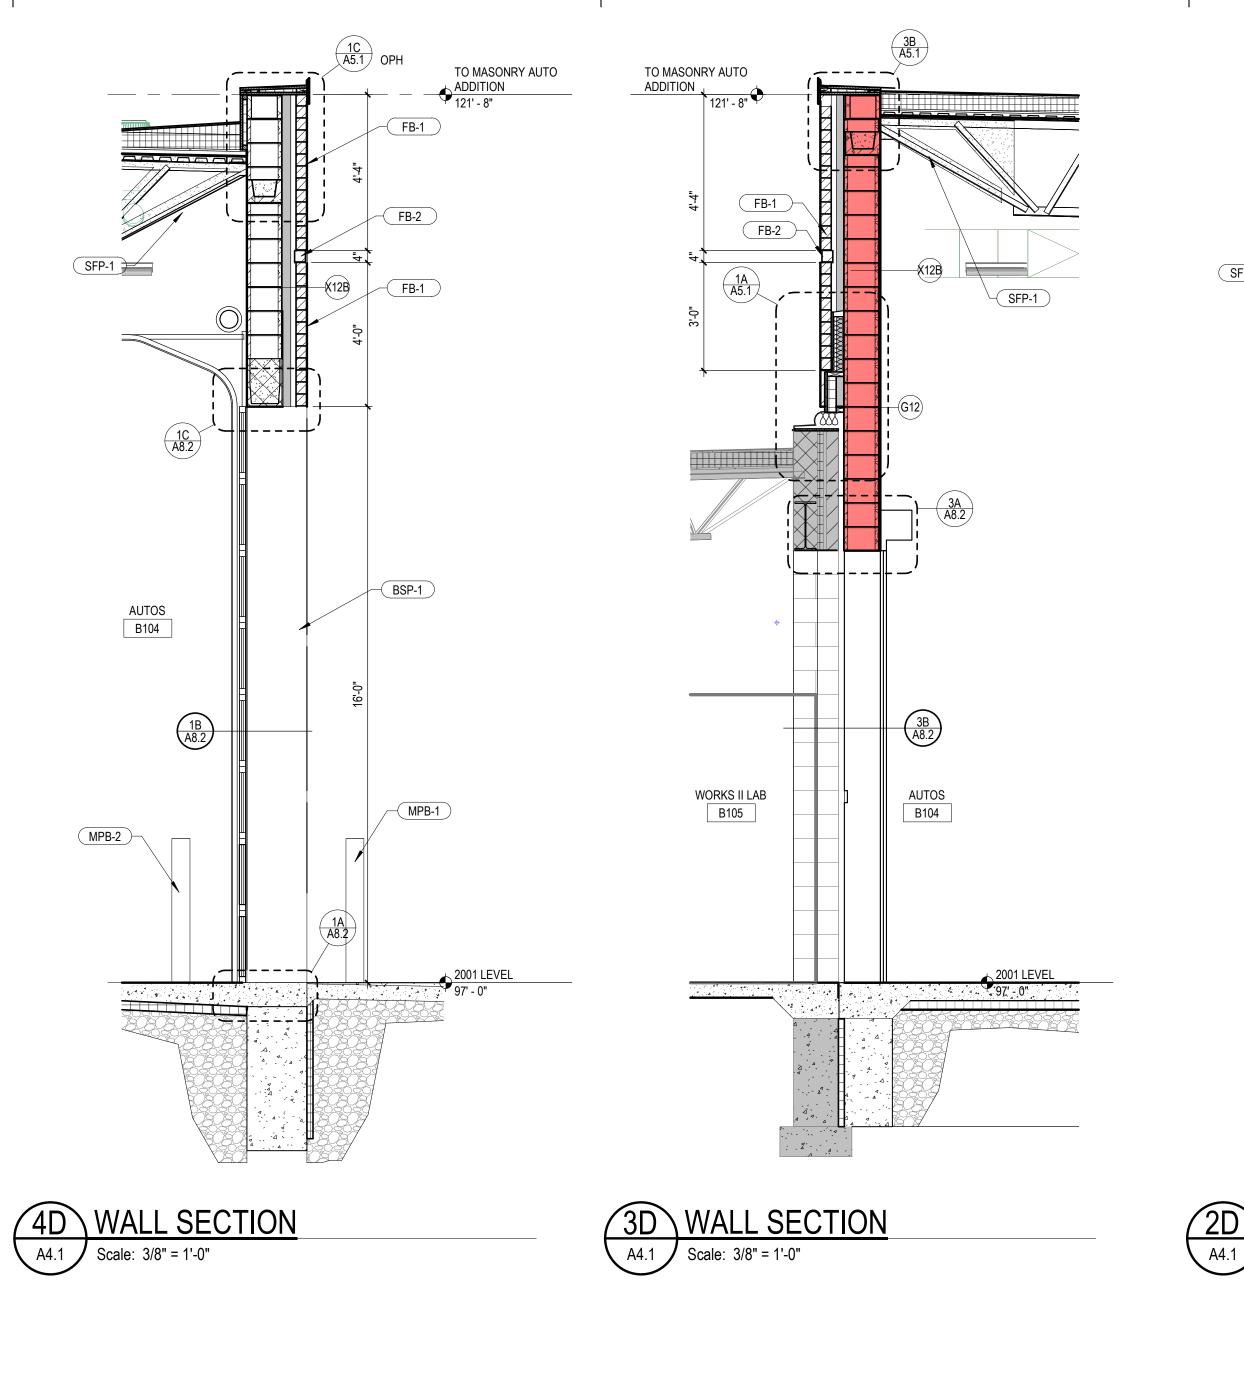

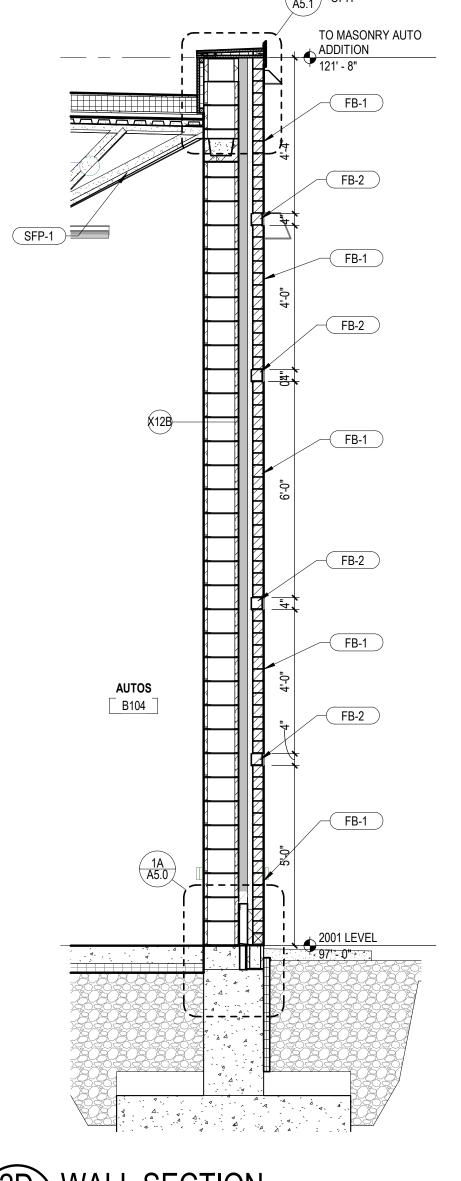

A4.1 Scale: 3/8" = 1'-0"

KEYNOTE LEGEND BENT STEEL PLATE, 3/16", PAINT PT-7 FACE BRICK FACE BRICK, 1/2" RECESS WITH MORTAR WASH 4" STARTER CMU TO MATCH EXISTING COURSING METAL (PIPE) BOLLARD W/ PVC COVER-EXTERIOR. SEE DETAIL 4A / A5.0 METAL (PIPE) BOLLARD W/PVC COVER-INTERIOR. SEE DETAIL 5A/A5.0 SPRAY APPLIED FIRE PROOFING

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TO MASONRY AUTO
ADDITION
121' - 8" CONSTRUCTION **DOCUMENTS** B101

3697 Sheet Title: WALL SECTIONS

Issued for:


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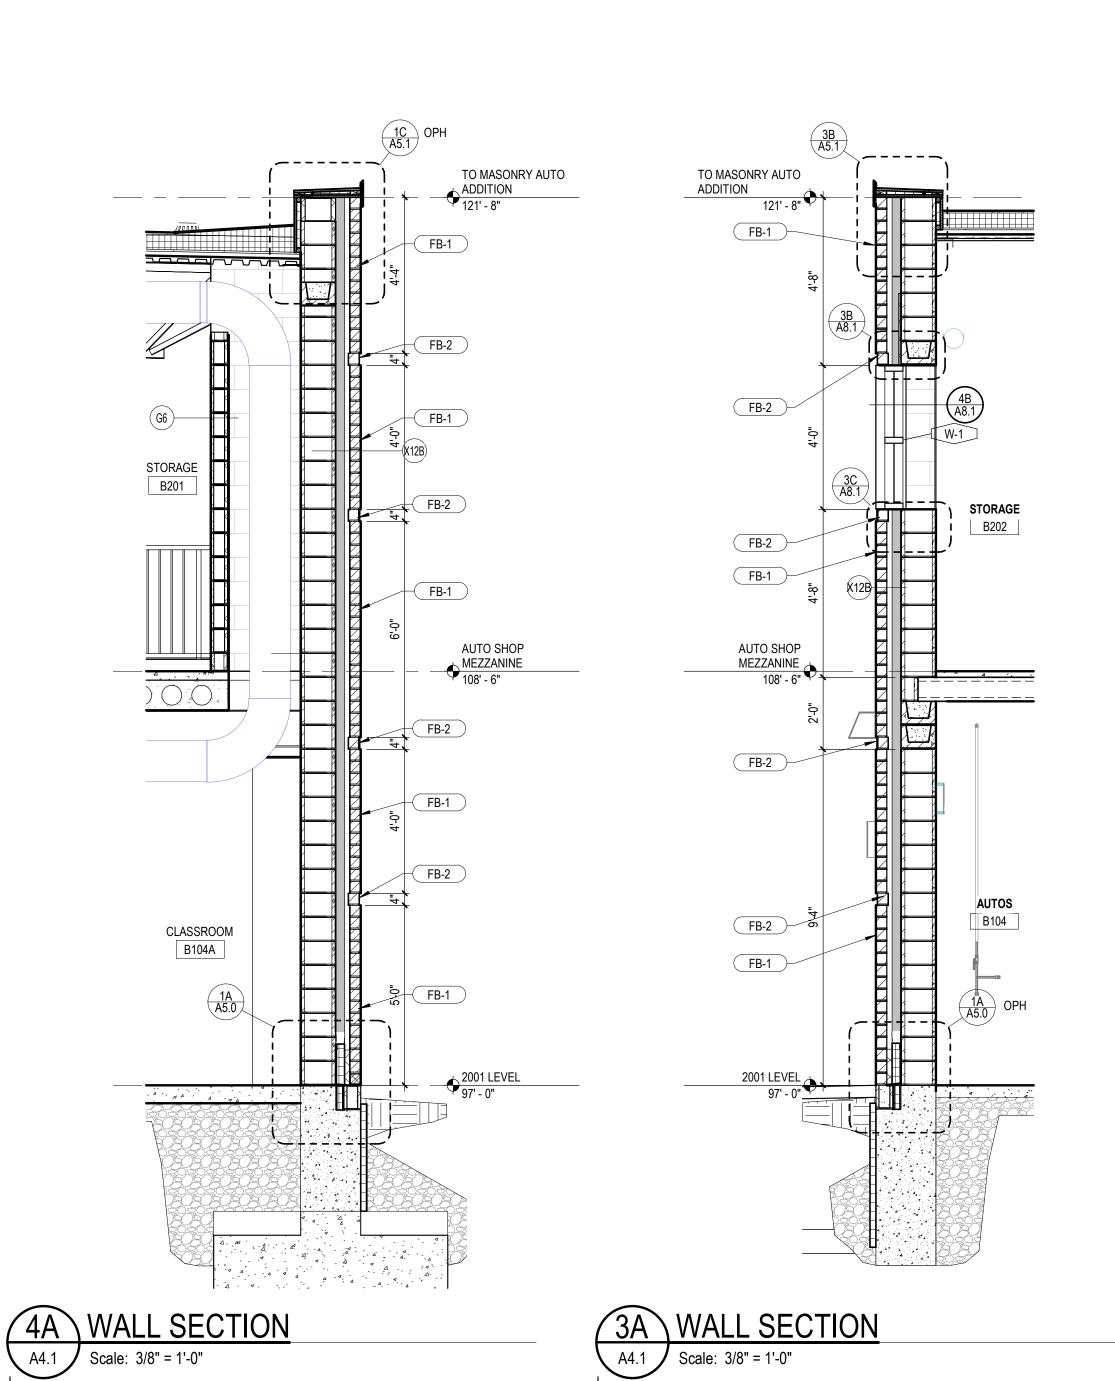
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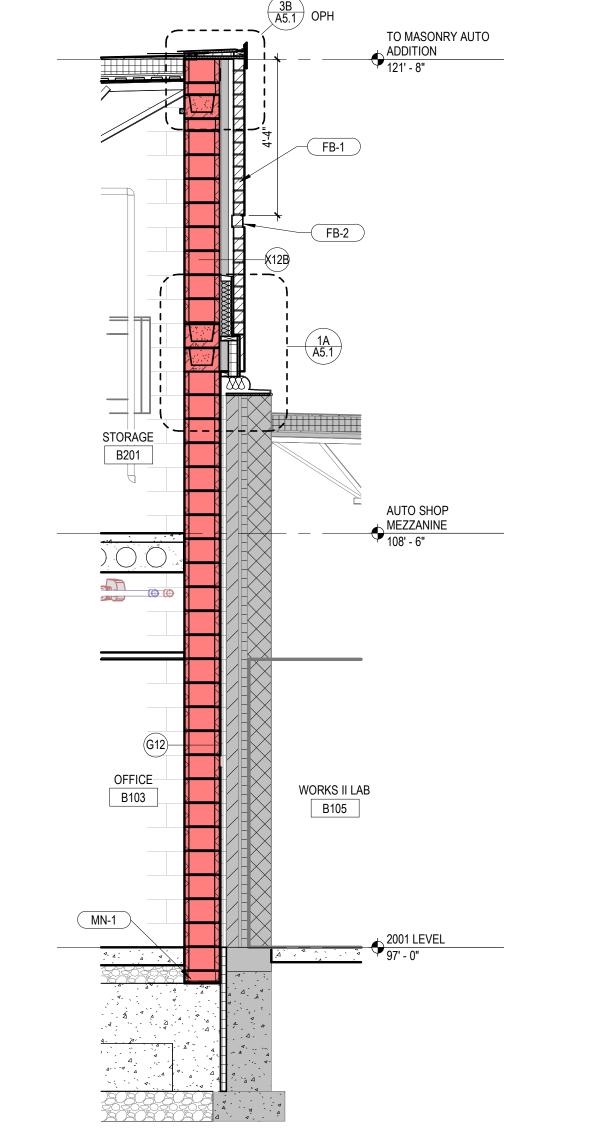
Sheet Number:

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A4.1







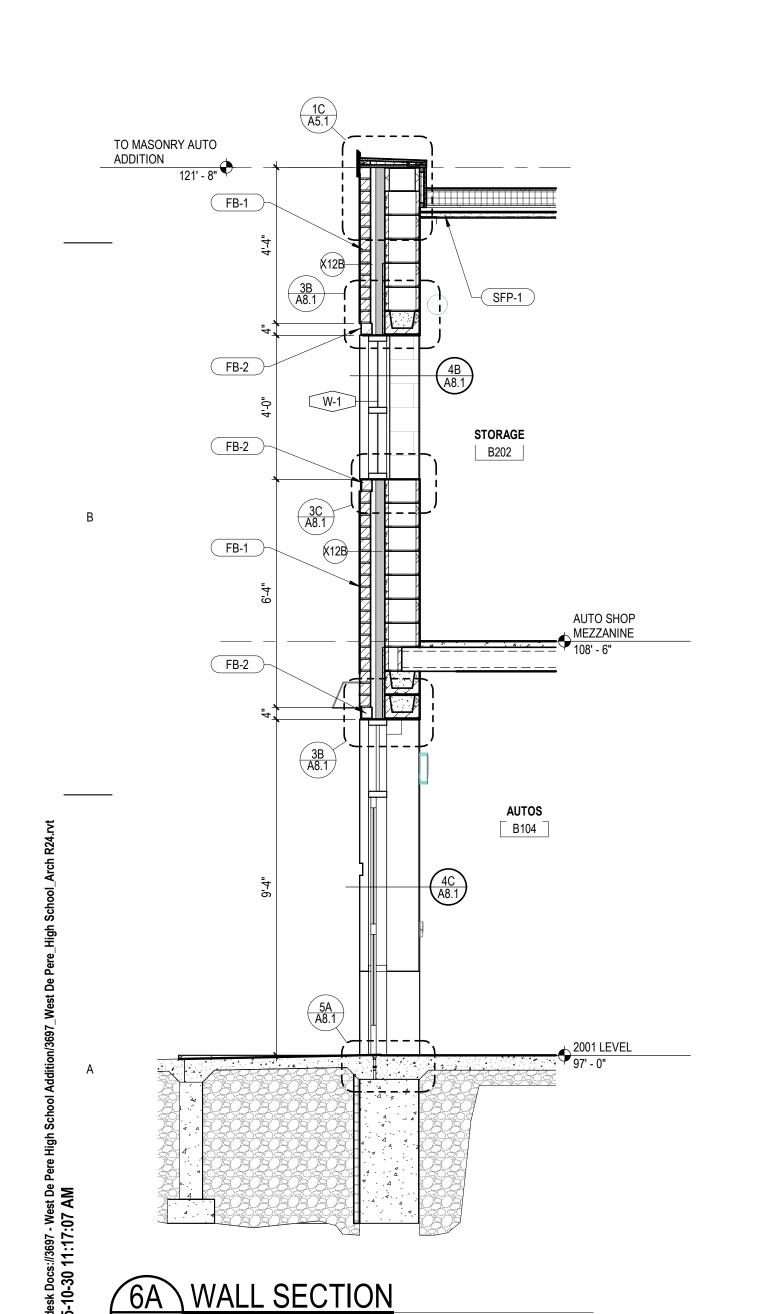

A4.1 Scale: 3/8" = 1'-0"

A4.1 Scale: 3/8" = 1'-0"

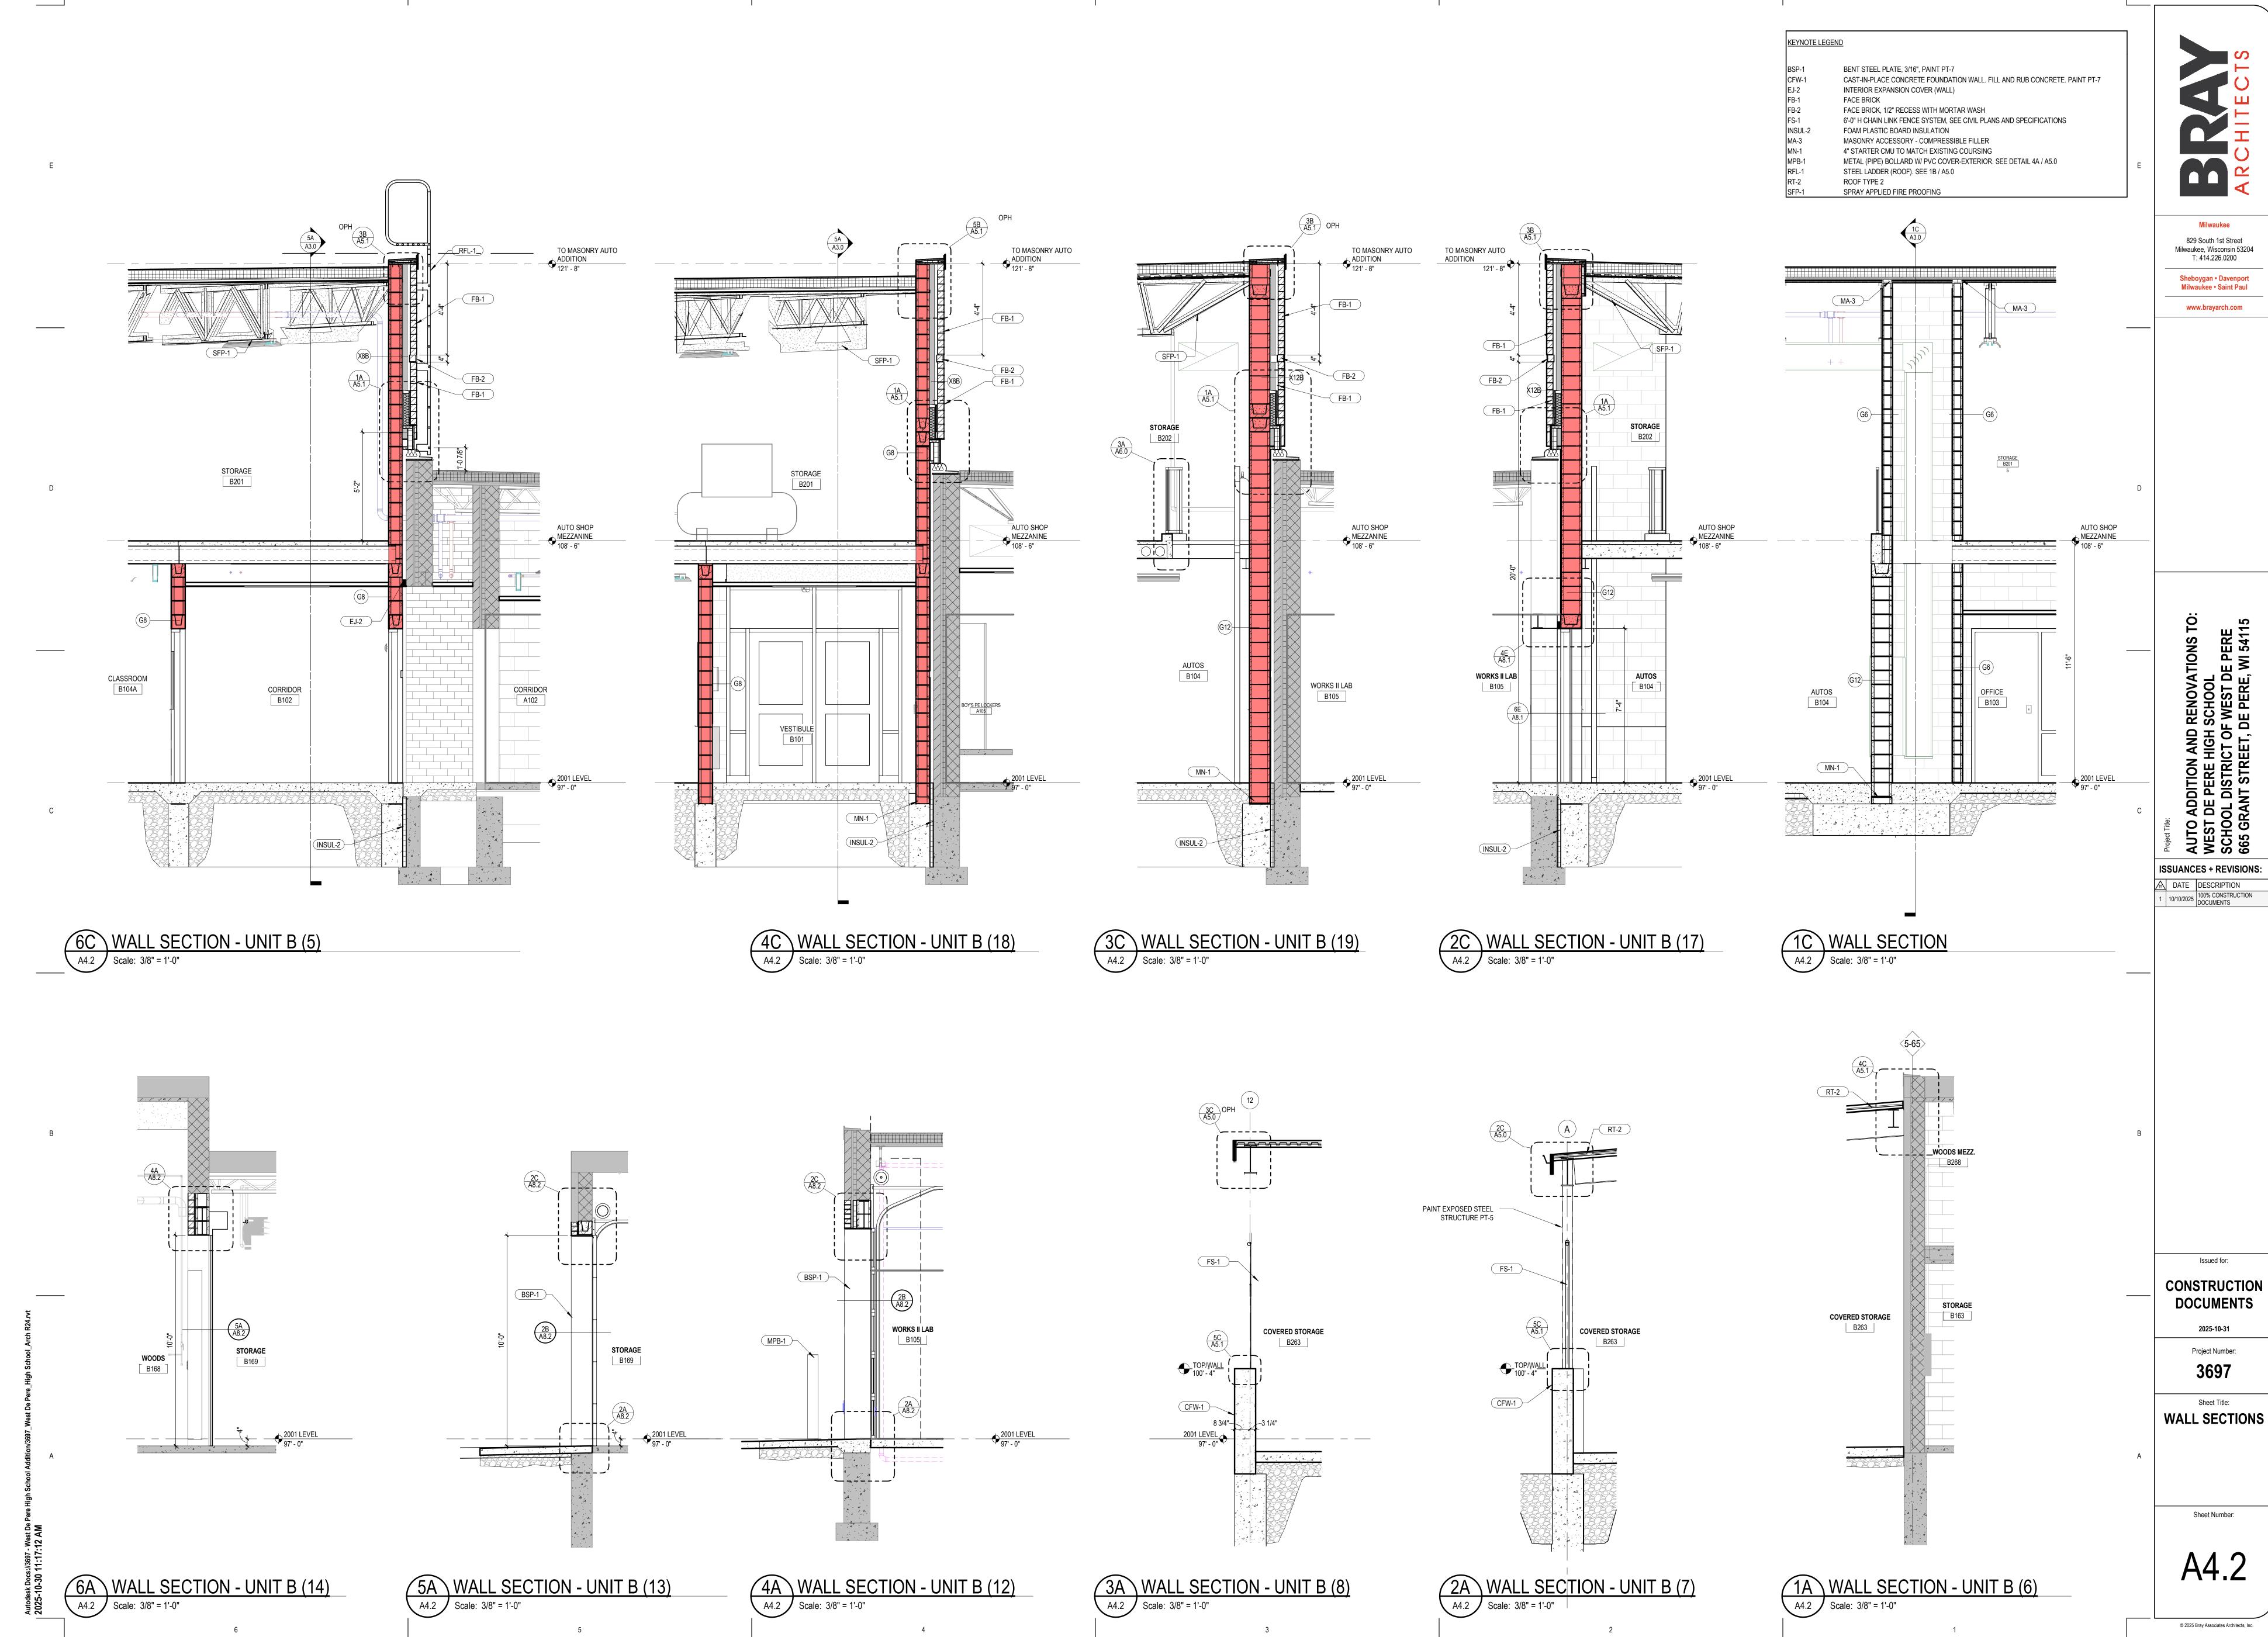

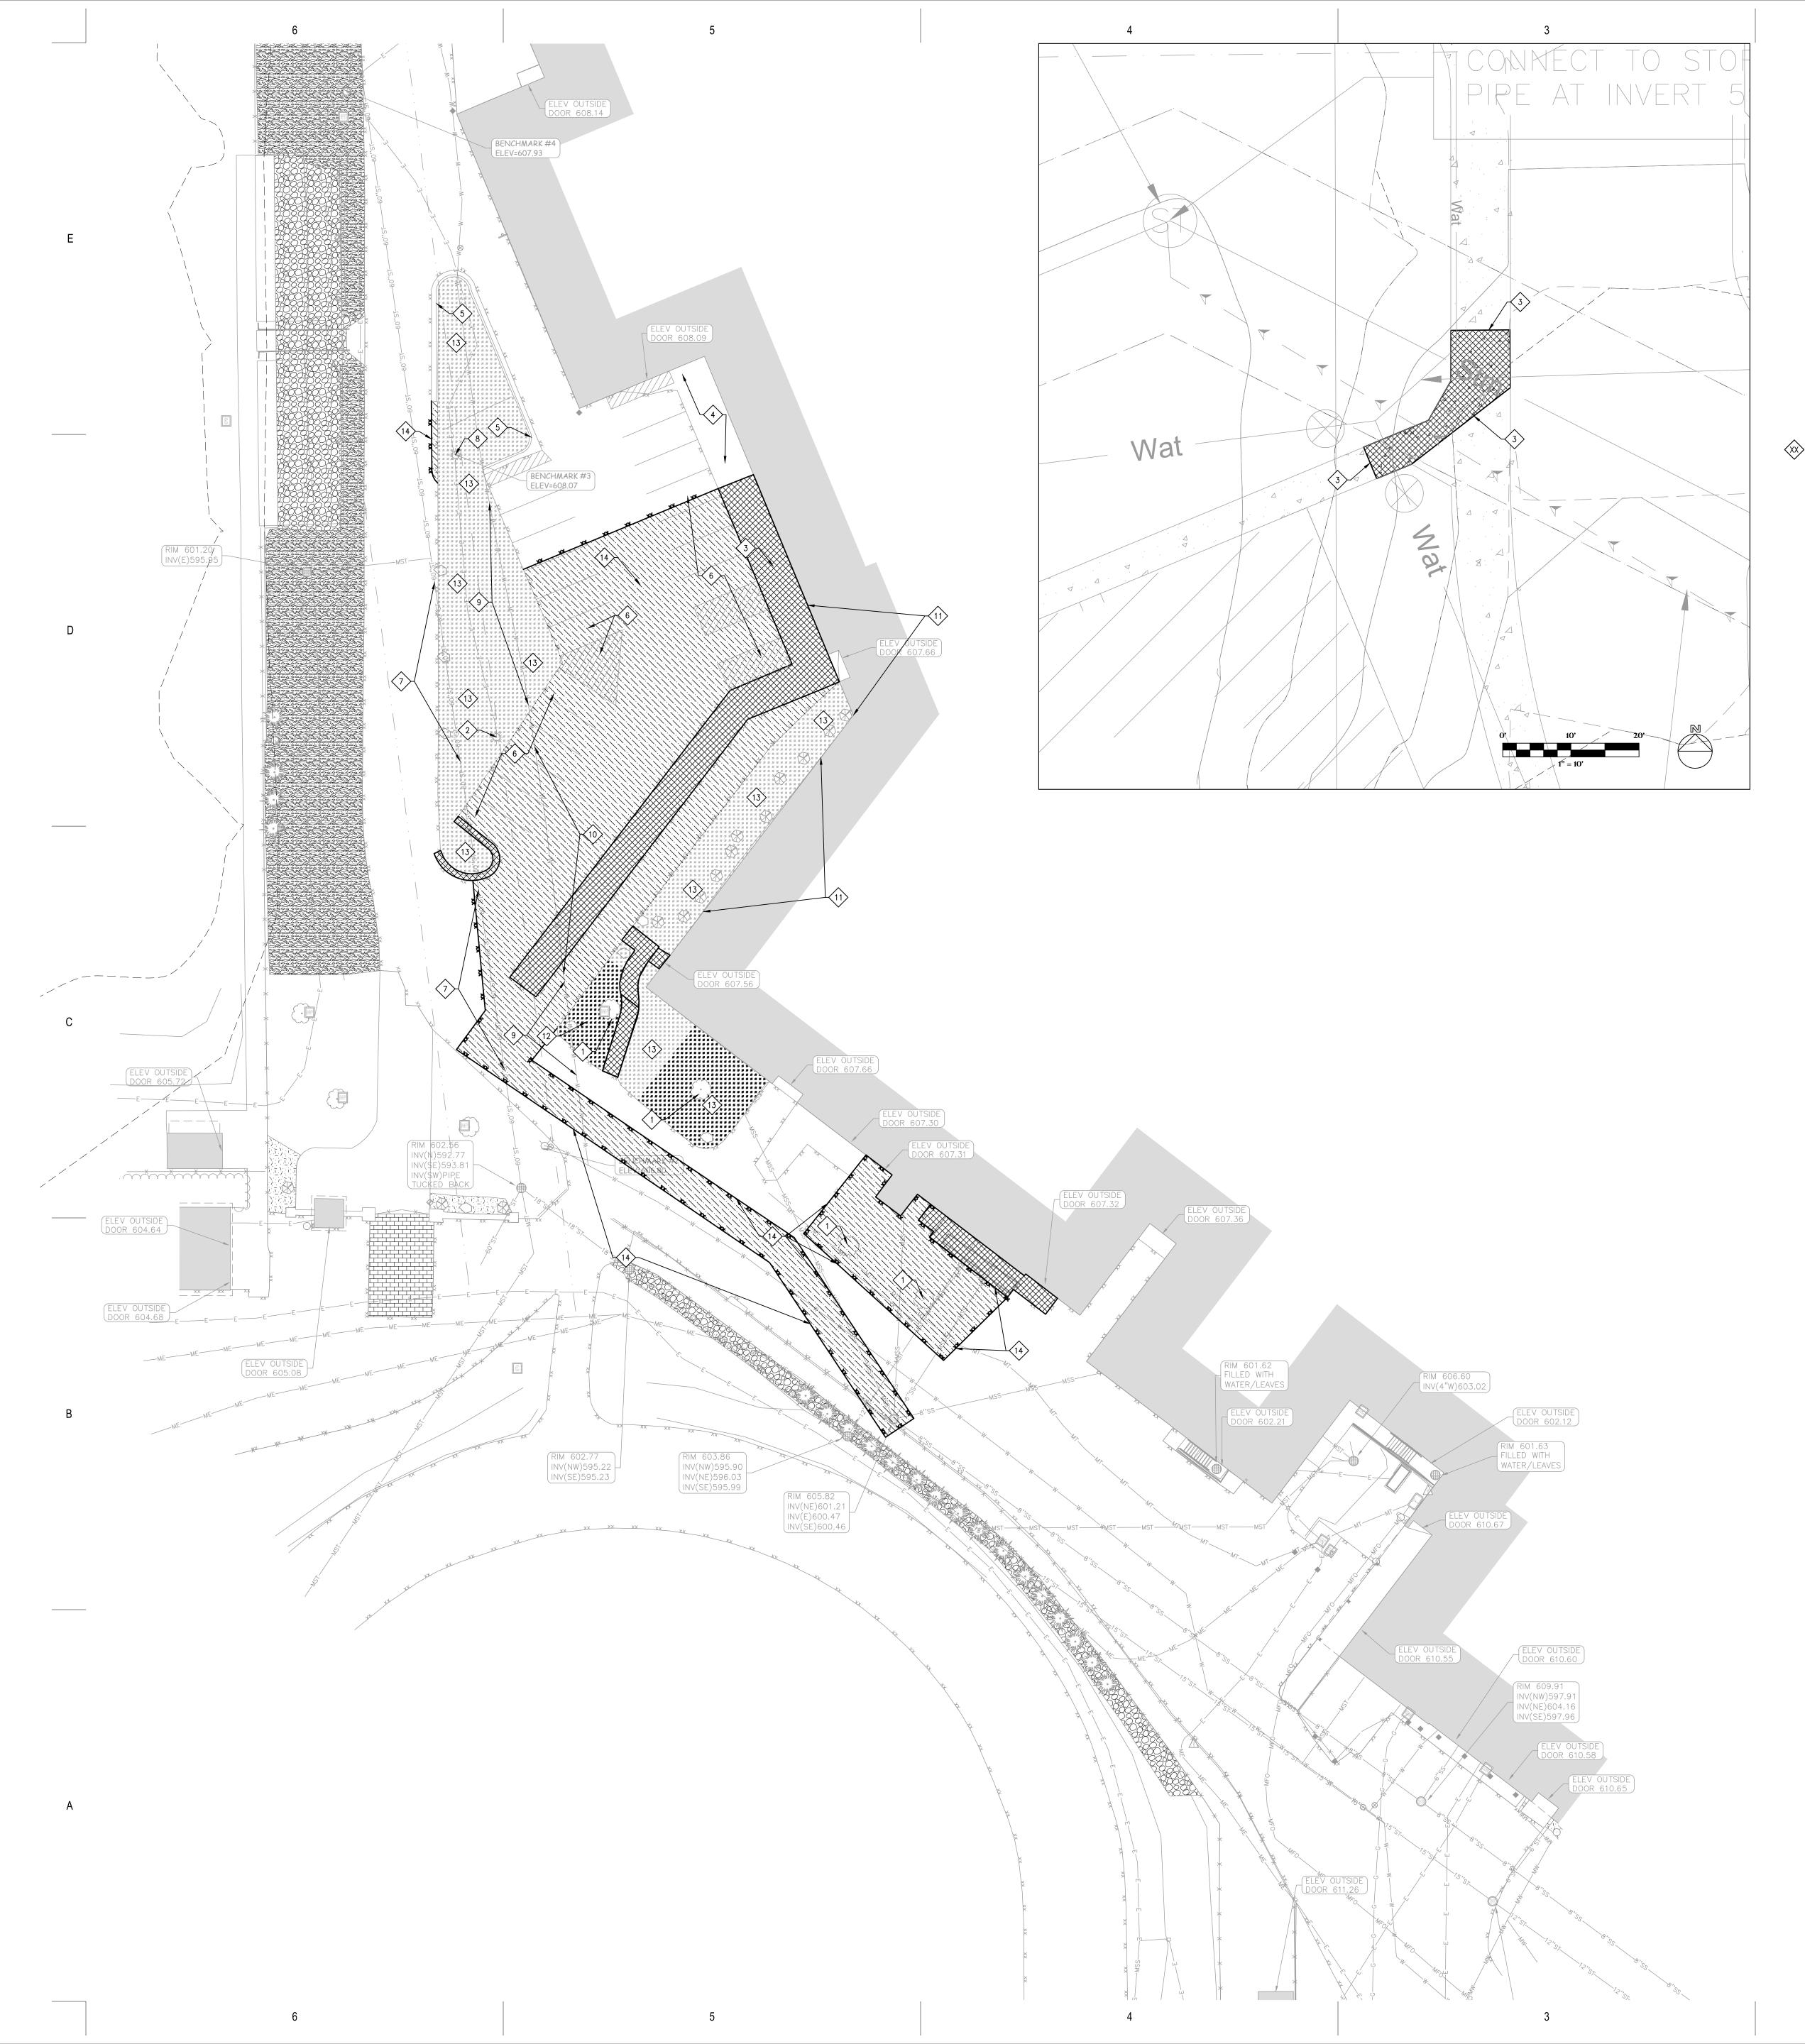

- 1. CONTRACTOR SHALL LOCATE ALL PUBLIC AND PRIVATE UTILITIES PRIOR TO COMMENCEMENT OF WORK. 2. ALL DEMOLITION MATERIALS SHALL BE REMOVED FROM THE SITE AND DISPOSED OF IN A LEGAL MANNER EXCEPT
- FOR THOSE ITEMS NOTED TO BE SALVAGED, WHICH SHOULD BE TURNED OVER TO THE OWNER. 3. INSTALL AND MAINTAIN ALL REQUIRED EROSION CONTROL MEASURES FOR PERIMETER PROTECTION PRIOR TO THE
- START OF DEMOLITION/CONSTRUCTION, IN ACCORDANCE WITH THE LOCAL AND STATE GOVERNING AUTHORITIES. 4. BIDDERS SHALL VISIT THE SITE AND REVIEW EXISTING CONDITIONS PRIOR TO THE BID DATE.
- RELOCATED, AND/OR ADJUSTED SHALL BE THE RESPONSIBILITY OF THE SITE GRADING CONTRACTOR. 6. COORDINATE ALL PRIVATE & PUBLIC UTILITY REMOVAL, DISCONNECTION, &/OR RECONNECTION WITH RESPECTIVE

5. ANY EXISTING PUBLIC & PRIVATE UTILITIES NOT SHOWN ON THIS DOCUMENT WHICH NEED TO BE REMOVED,

- UTILITY COMPANIES PRIOR TO BEGINNING WORK.
- 7. COORDINATE UTILITY SERVICE DISCONNECTIONS/OUTAGES WITH OWNER AND ANY IMPACTED NEIGHBORS. MINIMIZE DISRUPTIONS TO THE MAXIMUM EXTENT PRACTICAL.
- 8. ANY EXISTING UTILITIES NOT EXPRESSLY LABELED FOR DEMOLITION/REMOVAL ON THIS DOCUMENT SHALL BE LEFT IN PLACE AND IN THEIR CURRENT STATE OF OPERATION. CONTACT ENGINEER WHEREVER CLARIFICATION IS NEEDED.
 9. PRIOR TO PERFORMING WORK WITHIN PUBLIC RIGHT OF WAYS, NOTIFY AND COORDINATE WORK WITH THE LOCAL


KEYNOTES:

- REMOVE TREE
- 2. REMOVE AND RELOCATE EXISTING
- POWER/LIGHT POLE
- 3. SAWCUT EXISTING CONCRETE WALK
- 4. MAINTAIN EXISTING CONCRETE WALK
- 5. MAINTAIN EXISTING CONCRETE CURBING
- 6. REMOVE EXISTING PARKING LOT STRIPING
- 7. MAINTAIN EXISTING STORM SEWER PIPE 8. MAINTAIN EXISTING ELECTRICAL
- 9. MAINTAIN EXISTING WATER SERVICE
- 10. REMOVE EXISTING WATER SERVICE

- 11. MAINTAIN EXISTING BUILDING
- 12. MAINTAIN EXISTING LANDSCAPE AREA: TREES, SHRUBS, MULCH AND FILTER FABRIC- VERIFY WITH LANDSCAPE PLAN
- 13. REMOVE EXISTING LANDSCAPE AREA: SHRUBS, MULCH AND FILTER FABRIC
- 14. SAWCUT EXISTING ASPHALT

DEMOLITION HATCH PATTERNS:

BITUMINOUS REMOVAL

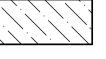

CONCRETE REMOVAL



CIVIL SHEET INDEX:

- **DEMOLITION PLAN**
- LAYOUT PLAN
- 3. GRADING PLAN
- UTILITY PLAN 5. DETAILS

BENCHMARK:

ELEVATIONS ARE REFERENCED TO NAVD 88 DATUM.

BURY BOLT ON HYDRANT, LOCATED APPROXIMATELY 30 FEET EAST OF THE SHED ON THE EAST SIDE OF THE TRACK AND FIELD. ELEVATION = 611.64

BURY BOLT ON HYDRANT, LOCATED ON THE NORTH SIDE OF THE TRACK AND FIELD, LOCATED APPROXIMATELY 60 FEET NORTHEAST OF THE TICKET STAND. ELEVATION = 606.80 BENCHMARK#3
CHISELED SQUARE ON WEST SIDE OF LIGHT POLE BASE,
LOCATED BETWEEN THE BLEACHERS ON THE EAST SIDE OF THE SOCCER FIELD AND THE WEST DE PERE HIGH

ELEVATION = 608.07

CHISELED SQUARE ON WEST SIDE OF LIGHT POLE BASE, LOCATED NORTH OF THE BLEACHERS ON THE EAST SIDE OF THE SOCCER FIELD.

UTILITY DISCLAIMER:

THE LOCATIONS, SIZES, AND TYPES OF UNDERGROUND PUBLIC AND PRIVATE UTILITIES OR SUBSTRUCTURES SHOW HEREON WERE OBTAINED FROM VISUAL INSPECTION, FIELD MEASUREMENTS, AND/OR AS-BUILT PLANS. SANITARY SEWER AND STORM SEWER PIPE SIZES, INVERTS, DIRECTION, AND LOCATIONS BETWEEN MANHOLES ARE SUPPLEMENTED BY AS-BUILT PLANS AND/OR ESTIMATED BASED ON FIELD OBSERVATIONS. PRIOR TO CONSTRUCTION IN THE VICINITY OF ANY UTILITIES SHOWN HEREON, IT IS RECOMMENDED THAT THE LOCATIONS, DEPTHS, AND SIZES BE FIELD VERIFIED. THE LOCATIONS SHOWN HEREON ARE ONLY APPROXIMATE, WITH POSSIBILITY THAT ADDITIONAL UTILITY LINES NOT DISCOVERED, OR MARKED, DURING THE SEARCH OF RECORDS AND THE

FIELD SURVEY MAY EXIST. ANY CONTRACTOR USING THE INFORMATION SHOWN HEREON IS HEREBY FOREWARNED THAT ANY EXCAVATION UPON THIS SITE MAY RESULT IN THE DISCOVERY OF ADDITIONAL UNDERGROUND UTILITIES NOT SHOWN HEREON. IN GENERAL, UNDERGROUND UTILITY LOCATIONS ARE SHOWN FROM UTILITY MARKINGS, BY OTHERS, AND/OR AS-BUILT PLANS, PROVIDED BY OTHERS. POINT

OF BEGINNING MAKES NO WARRANTY OF ANY KIND, EXPRESS OR IMPLIED, WITH RESPECT TO THE EXISTING UTILITIES SHOWN HEREON, AND BELIEVES THAT THE INFORMATION CONTAINED HEREIN IS RELIABLE AND GENERALLY ACCURATE FOR THE PURPOSE INTENDED.



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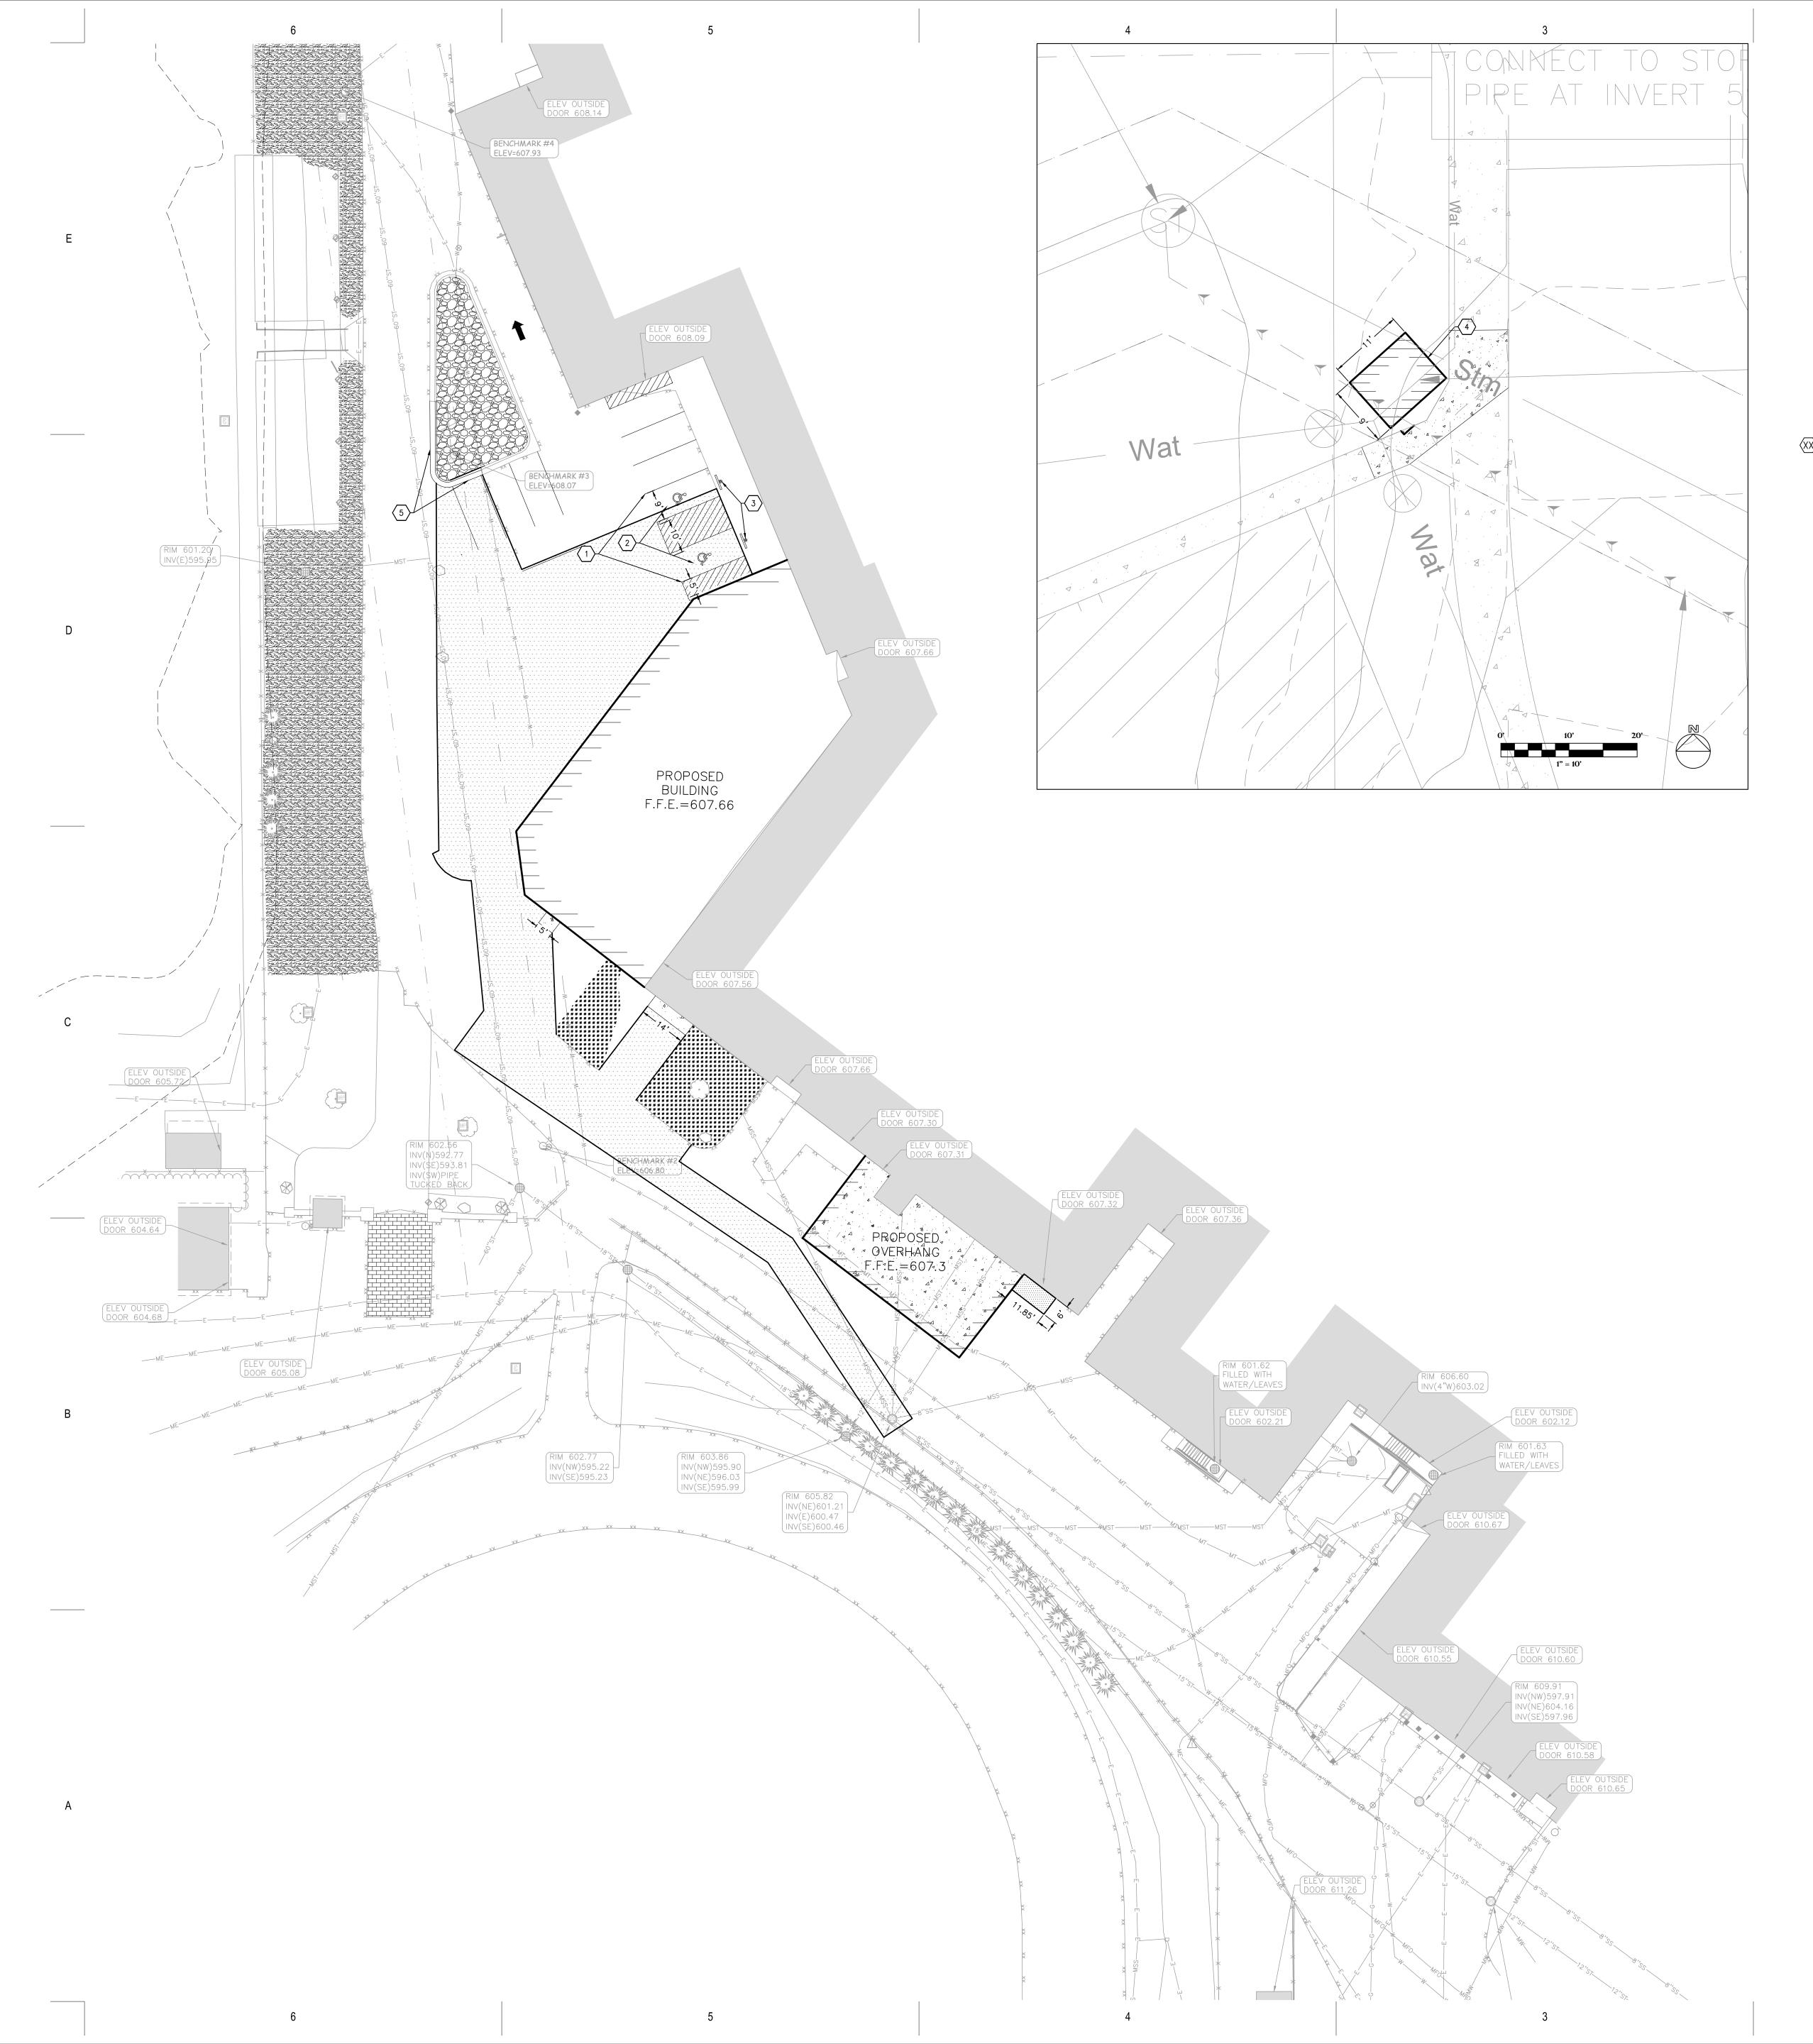
> Project Number: 3697

10/10/2025

Sheet Title:

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Sheet Number:



- CONTRACTOR SHALL LOCATE ALL PUBLIC AND PRIVATE UTILITIES PRIOR TO COMMENCEMENT OF WORK. GRADE, LINE, AND LEVEL TO BE REVIEWED IN THE FIELD BY THE CONSTRUCTION MANAGER. 3. ALL REQUIRED EROSION CONTROL MEASURES SHALL BE INSTALLED AND MAINTAINED IN ACCORDANCE WITH LOCAL MUNICIPAL AND DEPARTMENT OF NATURAL RESOURCES REGULATIONS.
- 4. ANY EXISTING UTILITIES NOT SHOWN ON THIS DOCUMENT WHICH NEED TO BE REMOVED, RELOCATED AND OR ADJUSTED SHALL BE THE RESPONSIBILITY OF THE SITE GRADING CONTRACTOR. 5. VERIFY THE LOCATION OF ALL EXISTING UTILITIES PRIOR TO THE START OF DEMOLITION/CONSTRUCTION.
- 6. BIDDERS SHALL VISIT THE SITE AND REVIEW EXISTING CONDITIONS PRIOR TO THE BID DATE. 7. PRIOR TO STARTING WORK, VERIFY WITH THE LOCAL AUTHORITIES THAT ALL REQUIRED PERMITS HAVE
- 8. COORDINATE CONSTRUCTION IN THE RIGHT OF WAY WITH THE LOCAL AUTHORITIES. 9. PROVIDE PROPER BARRICADES, SIGNS, AND TRAFFIC CONTROL TO MAINTAIN THRU TRAFFIC ALONG
- ADJACENT STREETS IN ACCORDANCE WITH LOCAL MUNICIPAL REQUIREMENTS. 10. ALL GENERAL LANDSCAPE AREAS SHALL BE SEEDED, FERTILIZED, AND CRIMP HAY MULCHED IN ACCORDANCE WITH THE PROJECT SPECIFICATIONS.

KEYNOTES:

1. PARKING LOT STRIPING

2. HANDICAP PARKING STALL

3. HANDICAP PARKING SIGN

4. CONCRETE VAULT


5. CONCRETE CURB & GUTTER

PAVEMENT HATCH PATTERNS:

PROPOSED HEAVY DUTY ASPHALT PAVEMENT

PROPOSED RIPRAP LANDSCAPED

PROPOSED CONCRETE PAVEMENT

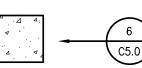

BENCHMARK:

ELEVATIONS ARE REFERENCED TO NAVD 88 DATUM.

BURY BOLT ON HYDRANT, LOCATED APPROXIMATELY 30 FEET EAST OF THE SHED ON THE EAST SIDE OF THE TRACK AND FIELD. ELEVATION = 611.64

BURY BOLT ON HYDRANT, Located on the north side of the track and field, located approximately 60 feet northeast of the ticket stand. Elevation = 606.80


BENCHMARK#3 Chiseled square on west side of light pole base, Located between the bleachers on the east side of the soccer field and the west de pere high

ELEVATION = 608.07

CHISELED SQUARE ON WEST SIDE OF LIGHT POLE BASE,
LOCATED NORTH OF THE BLEACHERS ON THE EAST SIDE OF THE SOCCER FIELD.

UTILITY DISCLAIMER:

THE LOCATIONS, SIZES, AND TYPES OF UNDERGROUND PUBLIC AND PRIVATE UTILITIES OR SUBSTRUCTURES SHOW HEREON WERE OBTAINED FROM VISUAL INSPECTION, FIELD MEASUREMENTS, AND/OR AS-BUILT PLANS. SANITARY SEWER AND STORM SEWER PIPE SIZES, INVERTS, DIRECTION, AND LOCATIONS BETWEEN MANHOLES ARE SUPPLEMENTED BY AS-BUILT PLANS AND/OR ESTIMATED BASED ON FIELD OBSERVATIONS. PRIOR TO CONSTRUCTION IN THE VICINITY OF ANY UTILITIES SHOWN HEREON, IT IS RECOMMENDED THAT THE LOCATIONS, DEPTHS, AND SIZES BE FIELD VERIFIED. THE LOCATIONS SHOWN HEREON ARE ONLY APPROXIMATE, WITH POSSIBILITY THAT ADDITIONAL UTILITY LINES NOT DISCOVERED, OR MARKED, DURING THE SEARCH OF RECORDS AND THE FIELD SURVEY MAY EXIST. ANY CONTRACTOR USING THE INFORMATION SHOWN HEREON IS HEREBY FOREWARNED THAT ANY EXCAVATION UPON THIS SITE MAY RESULT IN THE DISCOVERY OF ADDITIONAL UNDERGROUND UTILITIES NOT SHOWN HEREON. IN GENERAL, UNDERGROUND UTILITY LOCATIONS ARE SHOWN FROM UTILITY MARKINGS, BY OTHERS, AND/OR AS-BUILT PLANS, PROVIDED BY OTHERS. POINT OF BEGINNING MAKES NO WARRANTY OF ANY KIND, EXPRESS OR IMPLIED, WITH RESPECT TO THE EXISTING UTILITIES SHOWN HEREON, AND BELIEVES THAT THE INFORMATION CONTAINED HEREIN IS RELIABLE AND GENERALLY ACCURATE FOR THE PURPOSE INTENDED.

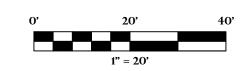





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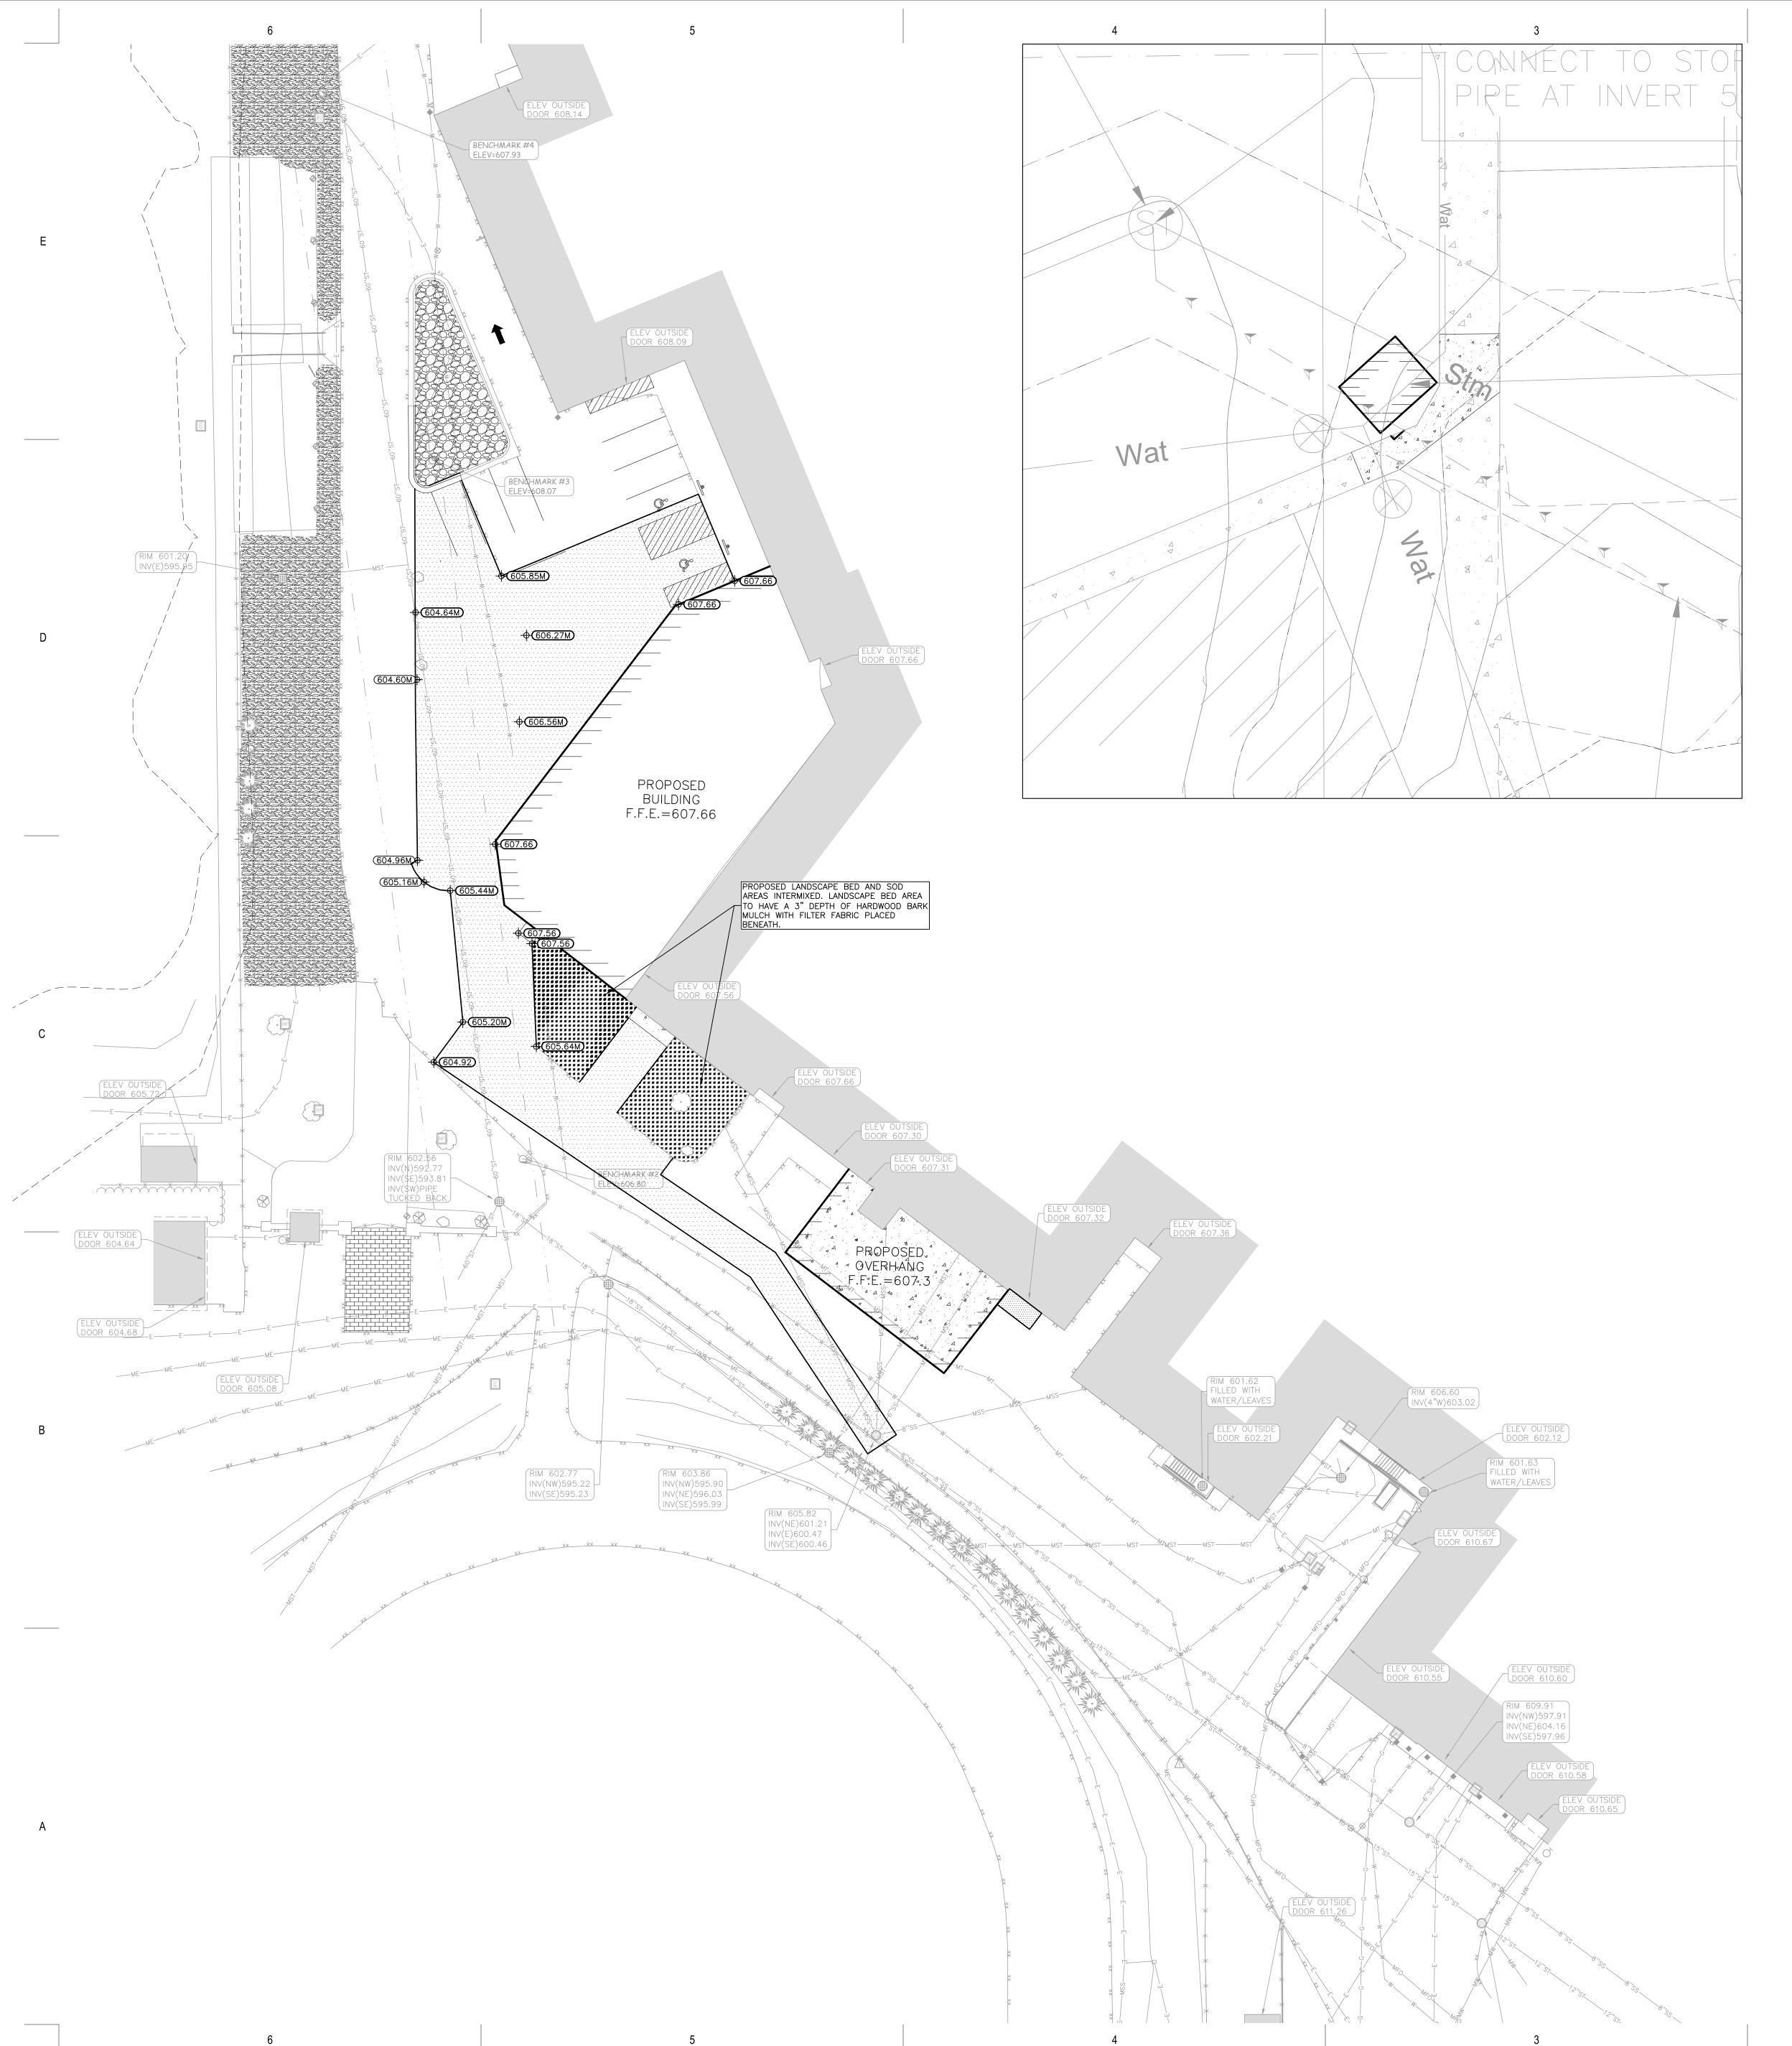
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Sheet Title:

LAYOUT PLAN

Sheet Number:



- 1. CONTRACTOR SHALL LOCATE ALL PUBLIC AND PRIVATE UTILITIES PRIOR TO COMMENCEMENT OF WORK. 2. THE PROPOSED SITE PLAN FINISH FLOOR ELEVATION OF _____ EQUALS THE PROPOSED BUILDING
- ARCHITECTURAL FINISH FLOOR ELEVATION OF 100.00'.

 3. GRADE, LINE, AND LEVEL SHALL BE REVIEWED IN THE FIELD BY THE CONSTRUCTION MANAGER.

 4. INSTALL AND MAINTAIN ALL REQUIRED EROSION CONTROL MEASURES IN ACCORDANCE WITH LOCAL MUNICIPAL
- AND DEPARTMENT OF NATURAL RESOURCES REGULATIONS.
- 5. 6" OF TOPSOIL SHALL BE PROVIDED IN ALL GENERAL LAWN AREAS AND 12" SHALL BE PROVIDED IN ALL PLANTING BED AREAS.
- 6. ANY EXISTING UTILITIES NOT SHOWN ON THIS DOCUMENT WHICH NEED TO BE REMOVED, RELOCATED, AND/OR ADJUSTED SHALL BE THE RESPONSIBILITY OF THE SITE GRADING CONTRACTOR. 7. COORDINATE ALL EARTHWORK ACTIVITIES WITH THE RESPECTIVE TRADES RESPONSIBLE FOR THE INSTALLATION
- OF GAS, CABLE, TELEPHONE AND ELECTRICAL (INCLUDING MAIN SERVICE, SITE LIGHTING, CONDUITS AND
- 8. ALL TESTING AND INSPECTION SHALL BE DONE IN ACCORDANCE WITH SPS 382.21.
 9. THE LOCAL MUNICIPALITY SHALL BE CONTACTED PRIOR TO ANY EXCAVATION IN THE PUBLIC RIGHT—OF—WAY.
 10. THE CONTRACTOR SHALL HAVE A TRAFFIC CONTROL PLAN APPROVED PRIOR TO WORK COMMENCING.
 11. THE LOCAL MUNICIPALITY SHALL OPERATE ALL EXISTING WATER VALVES IF NEEDED.

GRADING LEGEND:

EXISTING CONTOUR PROPOSED CONTOUR PROPOSED SPOT ELEVATION PROPOSED MATCH ELEVATION (CONTRACTOR TO VERIFY)

BENCHMARK:

ELEVATIONS ARE REFERENCED TO NAVD 88 DATUM.

BURY BOLT ON HYDRANT, LOCATED APPROXIMATELY 30 FEET EAST OF THE SHED ON THE EAST SIDE OF THE TRACK AND FIELD.

ELEVATION = 611.64

BURY BOLT ON HYDRANT, Located on the north side of the track and field, located approximately 60 feet northeast of the ticket stand. Elevation = 606.80

CHISELED SQUARE ON WEST SIDE OF LIGHT POLE BASE,
LOCATED BETWEEN THE BLEACHERS ON THE EAST SIDE OF THE SOCCER FIELD AND THE WEST DE PERE HIGH


ELEVATION = 608.07

CHISELED SQUARE ON WEST SIDE OF LIGHT POLE BASE, LOCATED NORTH OF THE BLEACHERS ON THE EAST SIDE OF THE SOCCER FIELD.

UTILITY DISCLAIMER:

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AND GENERALLY ACCURATE FOR THE PURPOSE INTENDED.



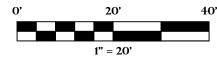



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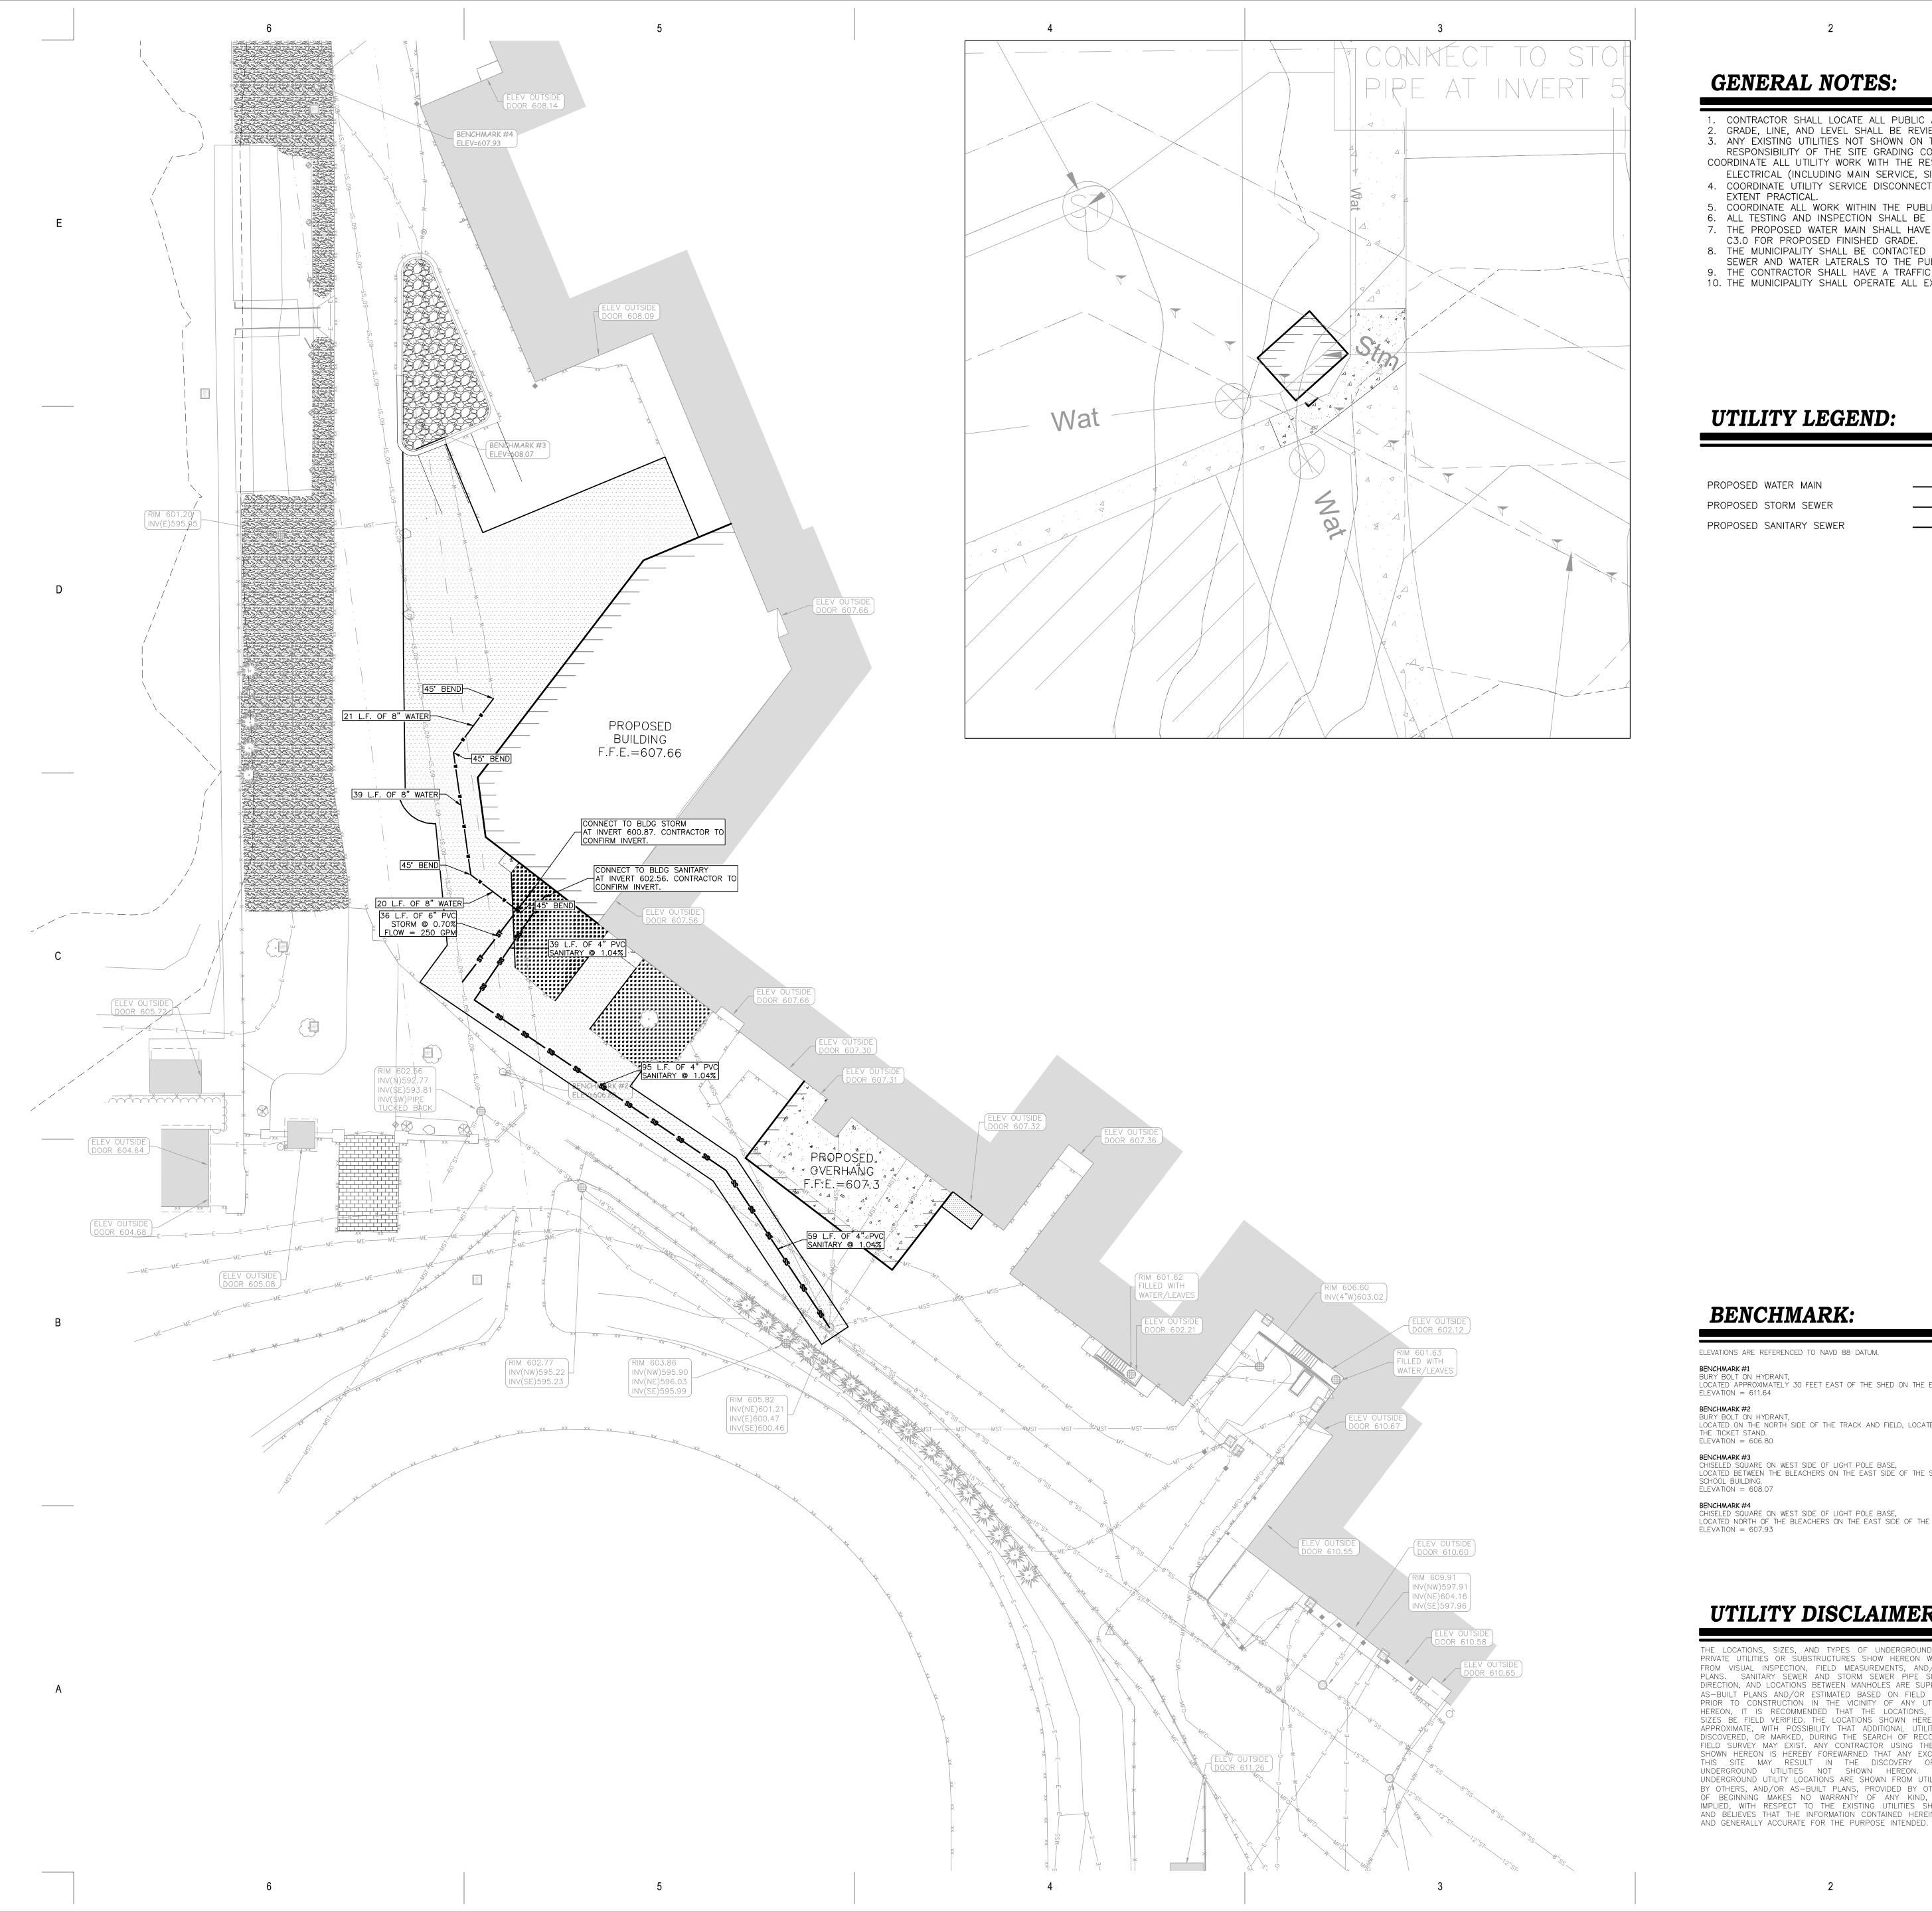
Issued for: 100% CONSTRUCTION **DOCUMENTS** 10/10/2025

> Project Number: 3697

Sheet Title:

GRADING

Sheet Number:



- 1. CONTRACTOR SHALL LOCATE ALL PUBLIC AND PRIVATE UTILITIES PRIOR TO COMMENCEMENT OF WORK. 2. GRADE, LINE, AND LEVEL SHALL BE REVIEWED IN THE FIELD BY THE CONSTRUCTION MANAGER.
- 3. ANY EXISTING UTILITIES NOT SHOWN ON THIS DOCUMENT WHICH NEED TO BE REMOVED, RELOCATED AND OR ADJUSTED SHALL BE THE
- RESPONSIBILITY OF THE SITE GRADING CONTRACTOR. COORDINATE ALL UTILITY WORK WITH THE RESPECTIVE TRADES RESPONSIBLE FOR THE INSTALLATION OF GAS, CABLE, TELEPHONE AND
- ELECTRICAL (INCLUDING MAIN SERVICE, SITE LIGHTING, CONDUITS AND SIGNAGE). 4. COORDINATE UTILITY SERVICE DISCONNECTIONS/OUTAGES WITH OWNER AND ANY IMPACTED NEIGHBORS. MINIMIZE DISRUPTIONS TO THE MAXIMUM
- 5. COORDINATE ALL WORK WITHIN THE PUBLIC RIGHT OF WAY WITH THE LOCAL MUNICIPALITY. 6. ALL TESTING AND INSPECTION SHALL BE DONE IN ACCORDANCE WITH SPS 382.21.
- 7. THE PROPOSED WATER MAIN SHALL HAVE A MINIMUM COVER OF 7'-6" TO THE TOP OF PIPE FROM PROPOSED FINISHED GRADE. SEE SHEET C3.0 FOR PROPOSED FINISHED GRADE.
- 8. THE MUNICIPALITY SHALL BE CONTACTED PRIOR TO ANY EXCAVATION IN THE PUBLIC RIGHT-OF-WAY, AND PRIOR TO CONNECTING SANITARY SEWER AND WATER LATERALS TO THE PUBLIC MAINS.
- 9. THE CONTRACTOR SHALL HAVE A TRAFFIC CONTROL PLAN APPROVED PRIOR TO WORK COMMENCING. 10. THE MUNICIPALITY SHALL OPERATE ALL EXISTING WATER VALVES, IF NEEDED.

UTILITY LEGEND:

PROPOSED WATER MAIN PROPOSED STORM SEWER PROPOSED SANITARY SEWER

Milwaukee 829 South 1st Street Milwaukee, Wisconsin 53204 T: 414.226.0200

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10/10/2025

Project Number:

3697

Sheet Title:

UTILITY

BENCHMARK:

ELEVATIONS ARE REFERENCED TO NAVD 88 DATUM.

BURY BOLT ON HYDRANT, LOCATED APPROXIMATELY 30 FEET EAST OF THE SHED ON THE EAST SIDE OF THE TRACK AND FIELD. ELEVATION = 611.64

BURY BOLT ON HYDRANT, Located on the north side of the track and field, located approximately 60 feet northeast of the ticket stand. Elevation = 606.80

CHISELED SQUARE ON WEST SIDE OF LIGHT POLE BASE, LOCATED BETWEEN THE BLEACHERS ON THE EAST SIDE OF THE SOCCER FIELD AND THE WEST DE PERE HIGH ELEVATION = 608.07

CHISELED SQUARE ON WEST SIDE OF LIGHT POLE BASE, LOCATED NORTH OF THE BLEACHERS ON THE EAST SIDE OF THE SOCCER FIELD. ELEVATION = 607.93

UTILITY DISCLAIMER:

THE LOCATIONS, SIZES, AND TYPES OF UNDERGROUND PUBLIC AND PRIVATE UTILITIES OR SUBSTRUCTURES SHOW HEREON WERE OBTAINED FROM VISUAL INSPECTION, FIELD MEASUREMENTS, AND/OR AS-BUILT PLANS. SANITARY SEWER AND STORM SEWER PIPE SIZES, INVERTS, DIRECTION, AND LOCATIONS BETWEEN MANHOLES ARE SUPPLEMENTED BY AS-BUILT PLANS AND/OR ESTIMATED BASED ON FIELD OBSERVATIONS. PRIOR TO CONSTRUCTION IN THE VICINITY OF ANY UTILITIES SHOWN HEREON, IT IS RECOMMENDED THAT THE LOCATIONS, DEPTHS, AND SIZES BE FIELD VERIFIED. THE LOCATIONS SHOWN HEREON ARE ONLY APPROXIMATE, WITH POSSIBILITY THAT ADDITIONAL UTILITY LINES NOT DISCOVERED, OR MARKED, DURING THE SEARCH OF RECORDS AND THE FIELD SURVEY MAY EXIST. ANY CONTRACTOR USING THE INFORMATION SHOWN HEREON IS HEREBY FOREWARNED THAT ANY EXCAVATION UPON THIS SITE MAY RESULT IN THE DISCOVERY OF ADDITIONAL UNDERGROUND UTILITIES NOT SHOWN HEREON. IN GENERAL, UNDERGROUND UTILITY LOCATIONS ARE SHOWN FROM UTILITY MARKINGS, BY OTHERS, AND/OR AS-BUILT PLANS, PROVIDED BY OTHERS. POINT OF BEGINNING MAKES NO WARRANTY OF ANY KIND, EXPRESS OR IMPLIED, WITH RESPECT TO THE EXISTING UTILITIES SHOWN HEREON, AND BELIEVES THAT THE INFORMATION CONTAINED HEREIN IS RELIABLE

