


May 9, 2025, 08:16AM EDT

Planning & Zoning Department

Parcel Number: (Include ALL parcels)	ED-344-102-4
Nearest property address to the project site:	Street Address: 1891 Commerce Drive City: De Pere State: W Zip: 54115
Check each project type that is being applied for:	Site Plan
Current De Pere Zoning Districts:	BP-2
Existing Site Land Uses:	Business Park/Industrial
Proposed Site Land Uses:	Business Park/Industrial
Does the project comply with the Comprehensive Plan?	Yes
Has City Staff been contacted for a preapplication meeting?	Yes
Property Owner:	First Name: Steve Last Name: Peters
Is the property owner's address the same as the nearest property address?	Yes
Property Owner's Phone Number:	920-246-6558
Property Owner's Email Address:	stevep@bedfordpaper.com
Is someone processing the project for the property owner as their authorized representative?	Yes
Authorized Representative's Name:	First Name: Brandon Last Name: Robaidek
Authorized Representative's Business Name:	Robert E. Lee and Associates, Inc.
Authorized Representative's Phone Number:	920-662-9641
Authorized Representative's Email Address:	brobaidek@releeinc.com

Please attach a PDF copy of the site plan.		BEDFORD PAPER COMMERCE 24X36 2025-05-09.pdf
Would you like a basic checklist of information to include in the site plan?		
How do you plan on pay your application?	ying for	Online with a credit card
Total Due:		\$350.00
Signature Data	Last Nam Email Ad	t: May 9, 2025 8:15am America/New_York
User 5 Session information		IP Address: 24.106.22.82 Referrer URL:

COMMERCE DRIVE-BEDFORD PAPER EXPANSION FOR BEST BUILT, INC. CITY OF DE PERE, BROWN COUNTY, WISCONSIN

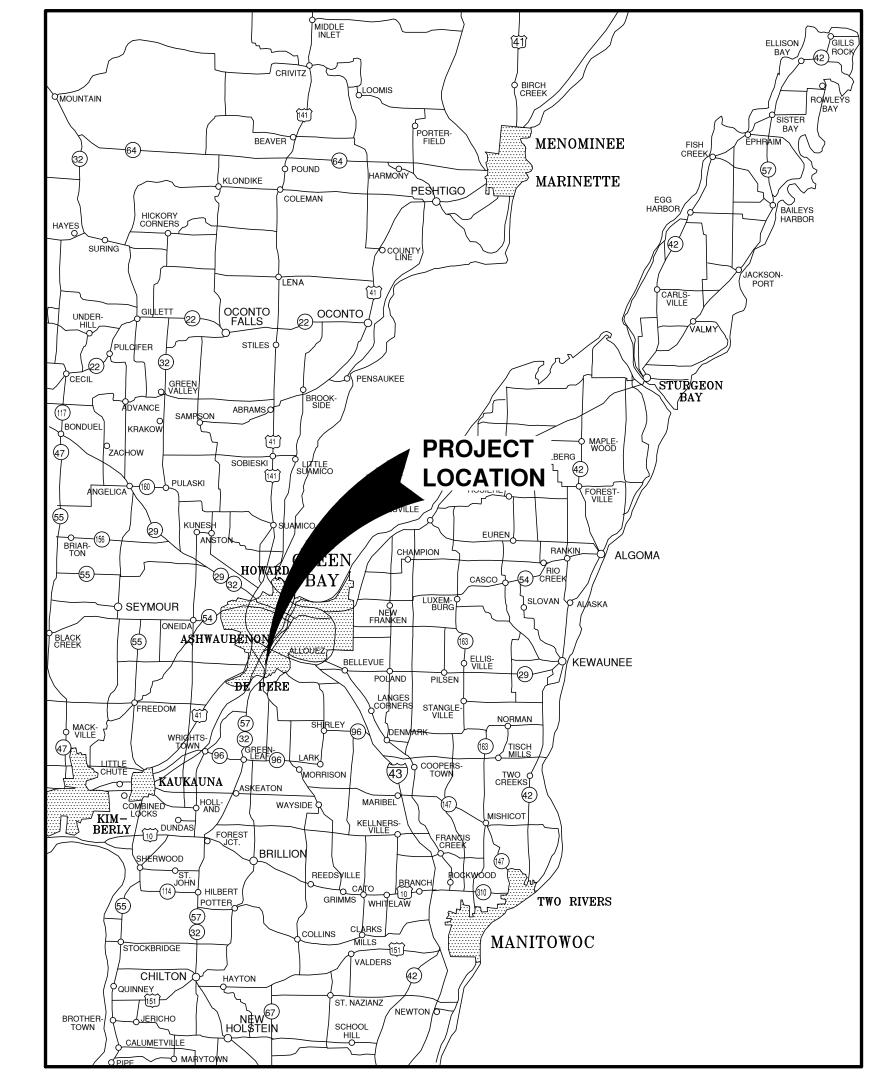

VICINITY MAP

NO.	DATE	APPROV.	REVISION	NO.	DATE	APPROV.	REVISION	DRAWN BDR	COMMERCE DRIVE-BEDFORD PAPER EXPANSION	
1	4/29/25	BDR	BID SET					CHECKED	FOR BEST BUILT, INC.	LOCATION MAPS AND INDEX 1
2	5/9/25	BDR	CITY SUBMITTAL					DESIGNED	CITY OF DE PERE	
								BDR	BROWN COUNTY, WISCONSIN	

: R:\1700\1703\1703\1703\29\dwg\1703129c.dwg : Date: May 09. 2025 - 6:24am NOT

EXISTING UTILITIES SHOWN ON PLANS ARE APPROXIMATE. THE CONTRACTOR SHALL BE RESPONSIBLE FOR OBTAINING EXACT LOCATIONS AND ELEVATIONS OF ALL UTILITIES, WHETHER SHOWN OR NOT, FROM THE OWNERS OF THE RESPECTIVE UTILITIES. ALL UTILITY OWNERS SHALL BE NOTIFIED FOR LOCATES BY THE CONTRACTOR 72 HOURS PRIOR TO EXCAVATION.


> NOTE: ALL EROSION CONTROL MEASURES SHALL BE IN PLACE PRIOR TO CONSTRUCTION AND SHALL CONFORM TO THE WISCONSIN DEPARTMENT OF NATURAL RESOURCES CONSTRUCTION SITE EROSION CONTROL AND TECHNICAL STANDARDS.

INDEX TO DRAWINGS


SHT. NO.	DESCRIPTION
С	LOCATION MAPS AND INDEX TO DRAWINGS
1	EXISTING SITE CONDITIONS AND DEMOLITION PLAN
2	SITE PLAN
3	UTILITY PLAN
4	GRADING PLAN
5	EROSION CONTROL PLAN
6	MISCELLANEOUS DETAILS
7	MISCELLANEOUS DETAILS
8	MISCELLANEOUS DETAILS
9	EROSION CONTROL - INLET PROTECTION TYPES A, B, C AND D
10	EROSION CONTROL - INLET PROTECTION TYPE D-HR AND TYPE D-M
11	EROSION CONTROL - DITCH CHECK DETAILS
12	EROSION CONTROL - SHEET FLOW DETAILS
13	EROSION CONTROL - TRACKOUT CONTROL PRACTICES
14	EROSION CONTROL - EROSION MAT SLOPE APPLICATION DETAILS
15	EROSION CONTROL - EROSION MAT CHANNEL APPLICATION DETAILS
L1	LANDSCAPE PLAN
L2	LIGHTING PHOTOMETRIC PLAN

ATTENTION!

DOWNLOADED PLANS ARE NOT SCALEABLE, NEITHER THE OWNER OR THE ENGINEER SHALL BE HELD RESPONSIBLE FOR THE SCALE OR PRINT QUALITY OF DOWNLOADED PLANS. ONLY PRINTED PLANS FROM BLUE PRINT SERVICE CO., INC. SHALL BE CONSIDERED TO BE SCALEABLE PLANS.

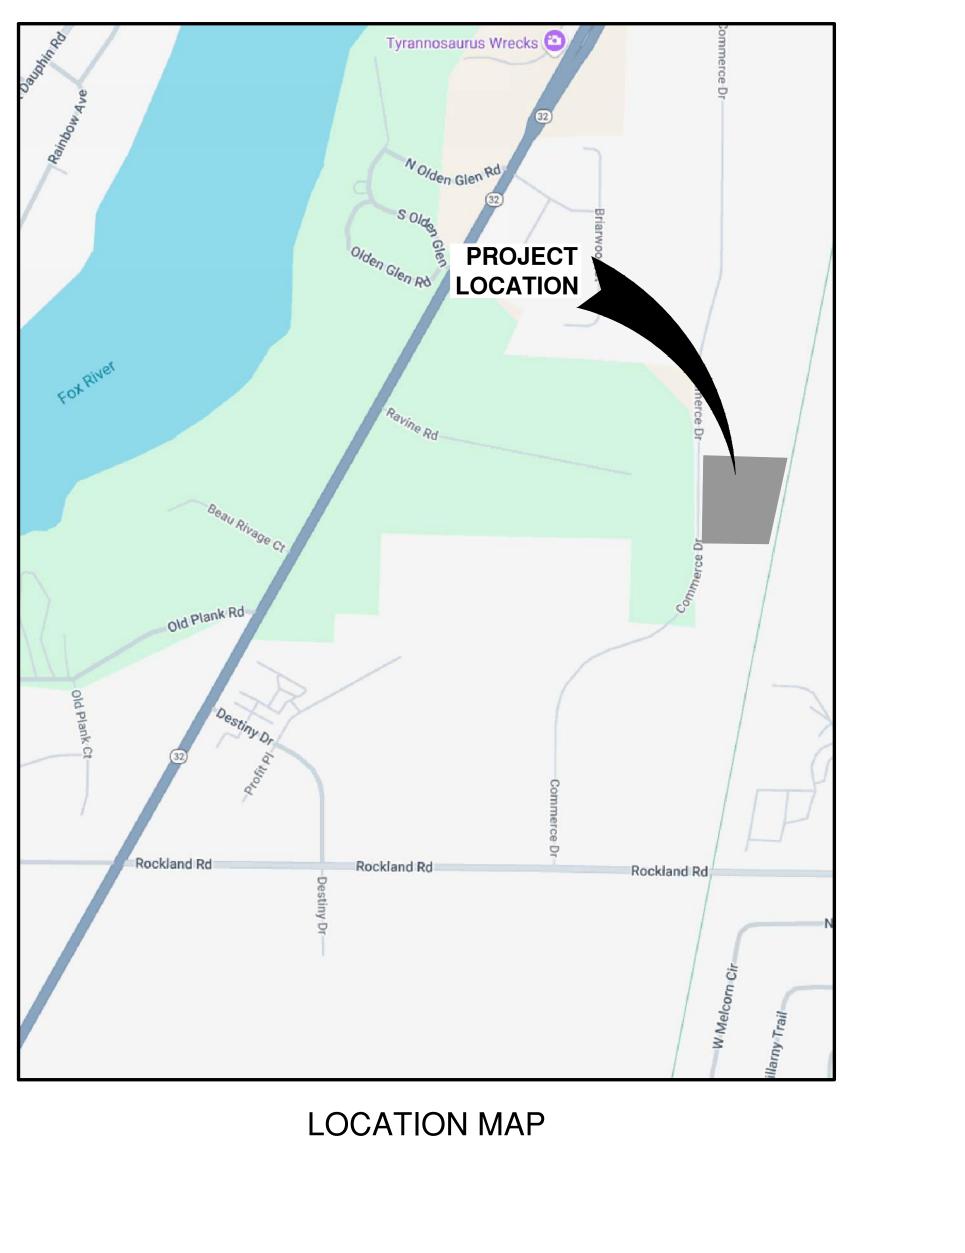

TO DRAWINGS FILE 1703129C JOB NO. 1703129 1703129 IZ50 Centennial Centre Blvd Hobart, WI 920-662-9641 releeinc.com	TO DRAWINGS	1703129C JOB NO.	& Associates, Inc.	SHEET NO.
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OWNER INFORMATION:

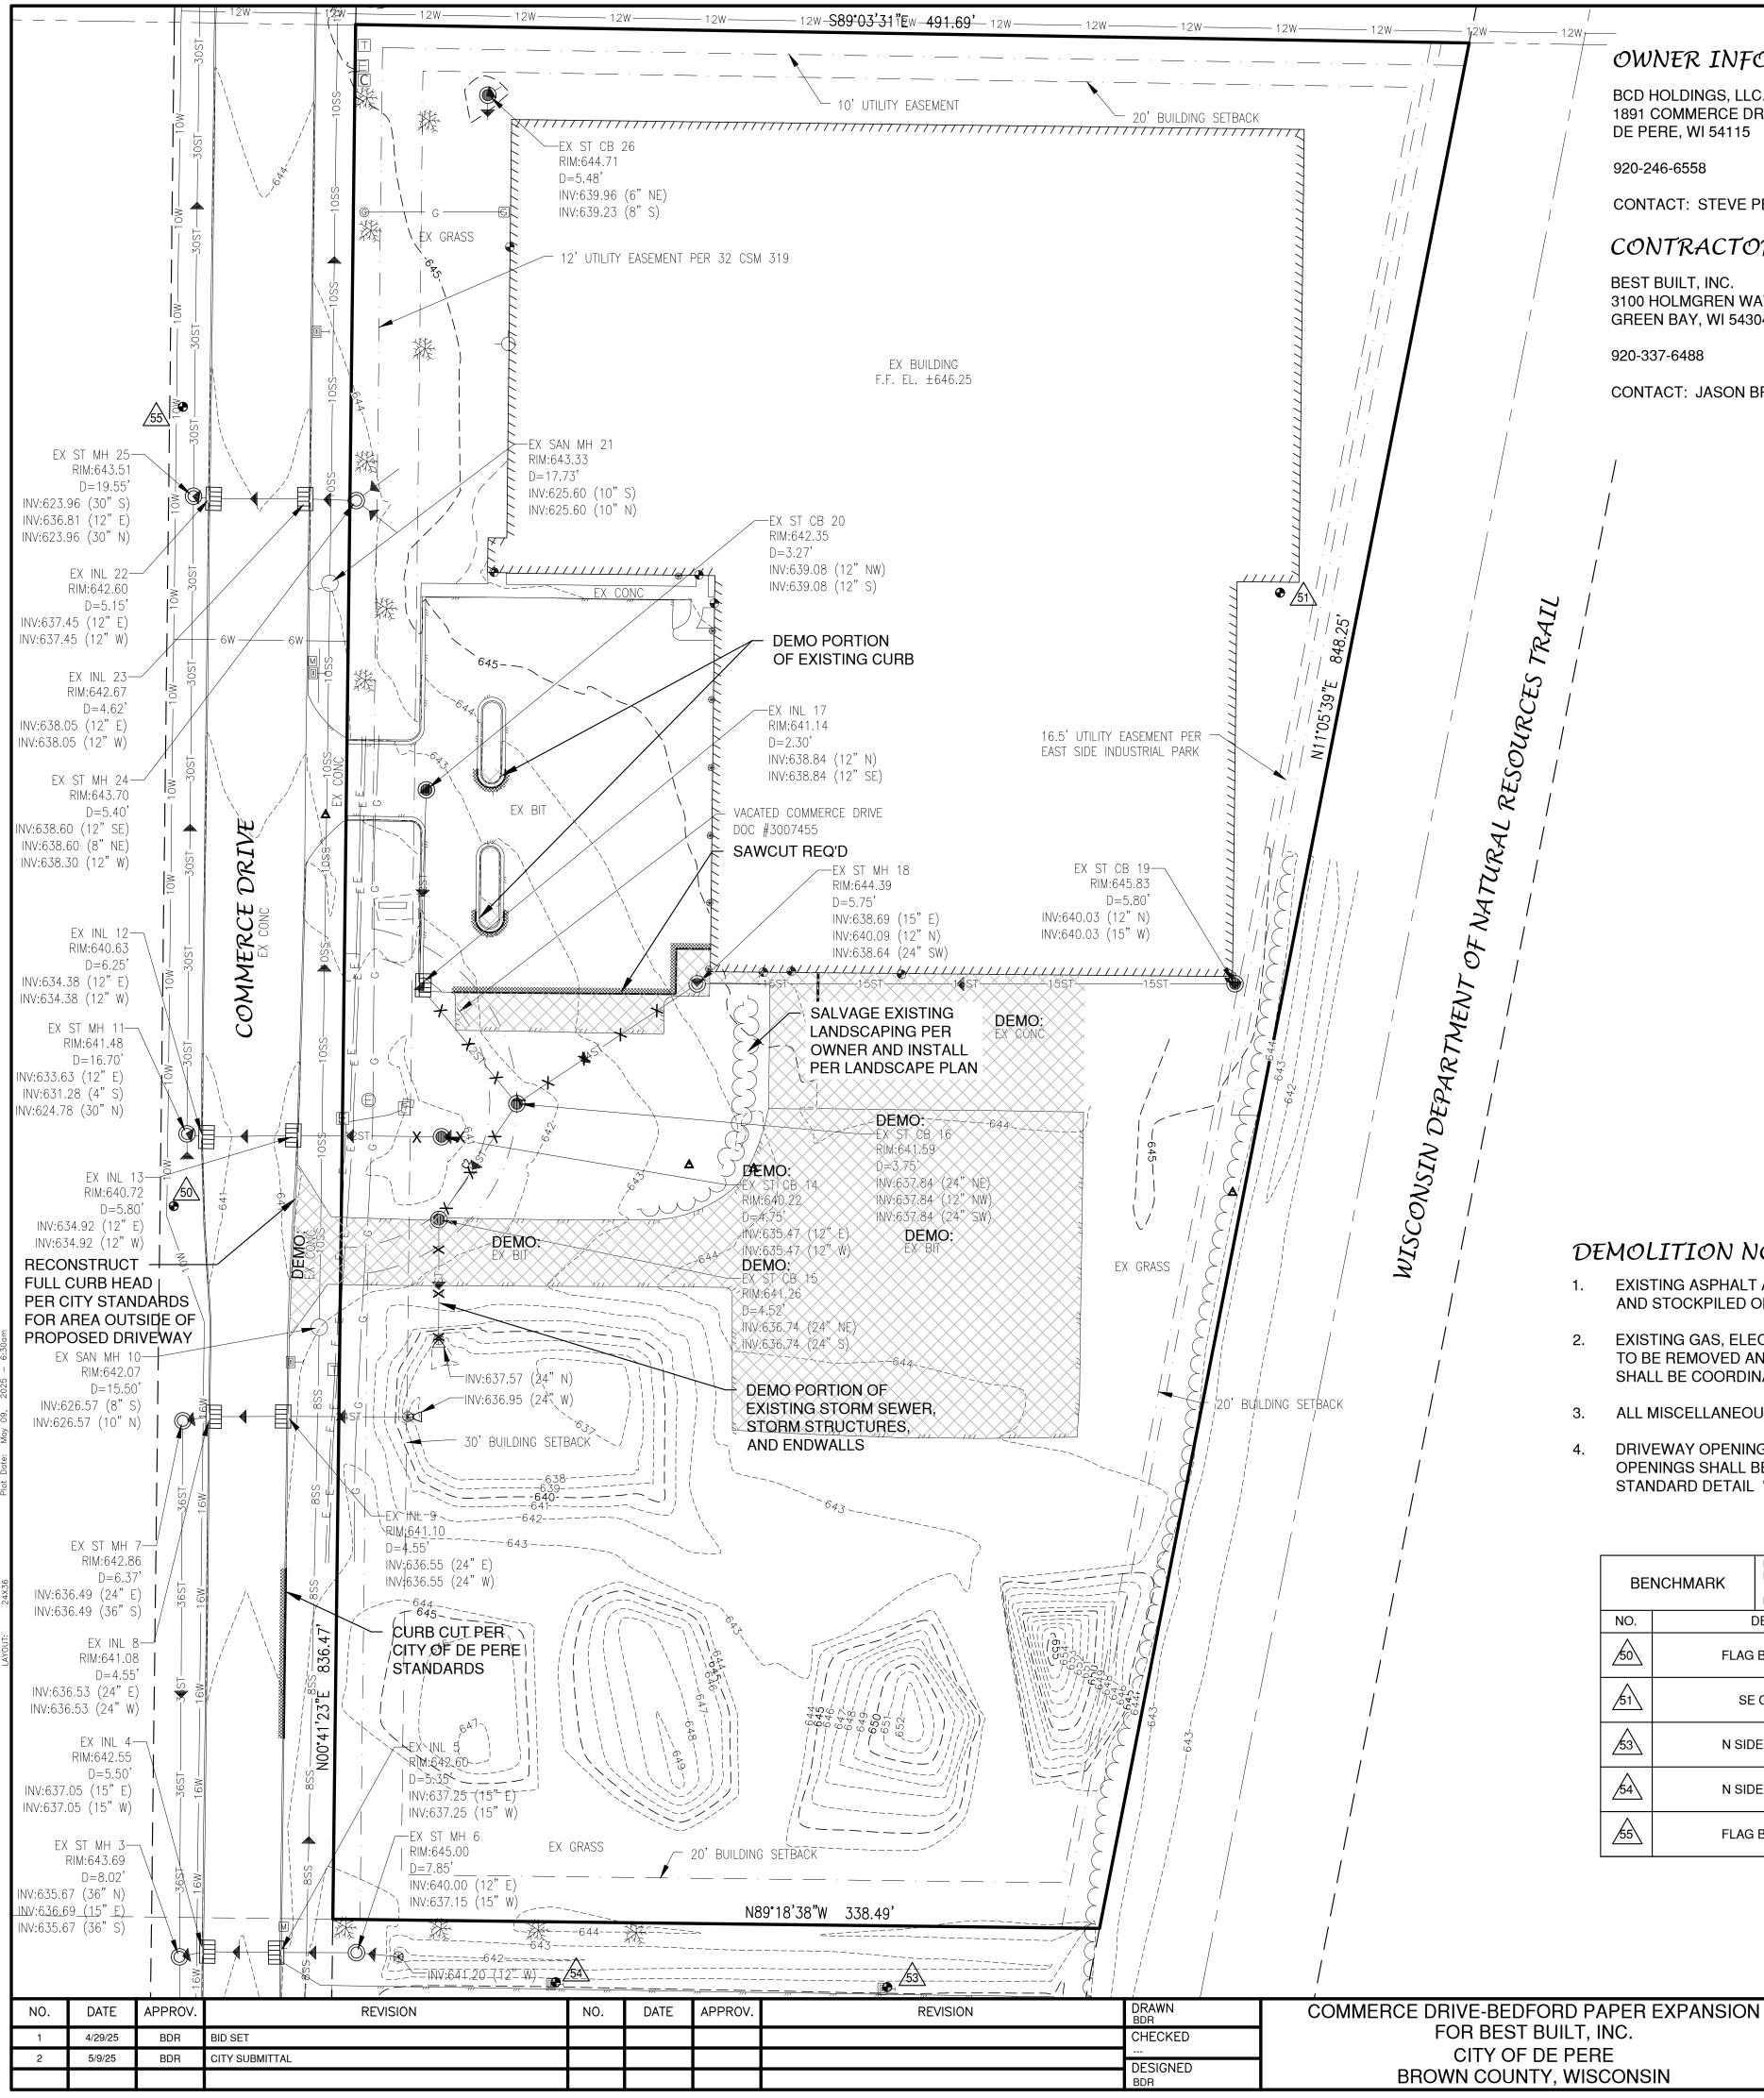BCD HOLDINGS, LLC. 1891 COMMERCE DRIVE DE PERE, WI 54115

920-246-6558

CONTACT: STEVE PETERS

CONTRACTOR INFORMATION:

BEST BUILT, INC. 3100 HOLMGREN WAY GREEN BAY, WI 54304

920-337-6488

CONTACT: JASON BRUNHOEFER

_____ _ _ _ _ _ _ _ _

GR. GRAVEL BIT. BITUMINO ASPH ASPHALT CONC CONCRET SW SIDEWAL BLDG BUILDING HSE HOUSE PED PEDESTA PP POWER P LP LIGHT POL BM BENCH M

DEMOLITION NOTES

- 1. EXISTING ASPHALT AND BASE COURSE MAY BE PULVERIZED AND STOCKPILED ON SITE FOR FUTURE USE.
- 2. EXISTING GAS, ELECTRIC, CABLE TELEVISION AND TELEPHONE TO BE REMOVED AND/OR RELOCATED BY OTHERS. WORK SHALL BE COORDINATED BY GENERAL CONTRACTOR.
- 3. ALL MISCELLANEOUS STRUCTURES SHALL BE REMOVED.
- DRIVEWAY OPENINGS SHALL BE REMOVED AND CURB OPENINGS SHALL BE CLOSED IN ACCORDANCE WITH STANDARD DETAIL "CURB REMOVAL", SEE DETAIL SHEETS

BENCHMARK		BENCHMARK ESTABLISHED BY: ROBERT E. LEE & ASSOCIATES, INC.		
NO.	[FIELD VERIFY BENCHMARKS FOR AC	EL.	
50	FLAG	643.71		
51	SE	646.08		
53	N SID	647.03		
54	N SID	647.13		
55	FLAG	644.31		

EXISTING SITE CONDITIONS AND DEMOLITION PLAN

						_	
LEGEND							
		[POWER POLE	¥¥.	DECIDUOUS TREE		
WATER VALVECURB STOP			I→ POWER POLE W/GUY WIRE	₹115 + +	CONIFEROUS TREE		
W WATER MANHOL▽ REDUCER/INCRE			Image: Constraint of the second systemImage: Constraint of the s		BUSH		
SANITARY MANHAIR RELIEF MAN			ELECTRIC METERTELEPHONE MANHOLE		RIP RAP		
STORM MANHOLSTORM INLET (N	E OT IN CURB AND GUTTEI		 TELEPHONE PEDESTAL CABLE TV MANHOLE 		CULVERT		
	I CURB AND GUTTER)			* * * * `	WETLANDS		
 STORM INLET M. TANK COVER SOIL BORING 	ANHOLE		 GAS VALVE GAS METER MAILBOX 	Ŀ,	HANDICAP PARKING		
 ♥SB POST ● IRON PIPE/ROD 			 SIGN ■ BOLLARD 	X	TO BE REMOVED		
△ PK NAIL					TO BE DEMOLISHED		
	CONTOUR LINE		8SS 8SS 4FM 4FM 10ST 10ST 6W 6W 6V G G G 0T 0T 0T 0E 0E 0E 0TV 0TV 0TV FO FO FO	FORCE STORM WATEL GAS LI GAS LI OVERI UNDEF OVERI OVERI OVERI CABLE FIBER FIBER R/W LI	HEAD TELEPHONE LINE RGROUND TELEPHONE LINE HEAD ELECTRIC LINE RGROUND ELECTRIC LINE HEAD CABLE TV LINE TV LINE OPTIC LINE NE ERTY LINE		
GR. GRAVEL WM BIT. BITUMINOUS HYD ASPH ASPHALT WV CONC CONCRETE SAN SW SIDEWALK MH BLDG BUILDING ST HSE HOUSE CB PED PEDESTAL TELE	WATERMAIN HYDRANT WATER VALVE SANITARY SEWER MANHOLE STORM SEWER CATCH BASIN ELECTRIC TELEPHONE ELECTRIC TELEVISION	VPC VPI PC PI PT R EX PR EOR BOC	VERTICAL POINT OF CURVATUR VERTICAL POINT OF INTERSECT VERTICAL POINT OF TANGENCY POINT OF CURVATURE POINT OF INTERSECTION POINT OF TANGENCY RADIUS EXISTING PROPOSED END OF RADIUS BACK OF CURB	E B-B ION F-F R/W T/C F/L C/L R/L INV CMP RCP	BACK TO BACK (OF CURB) FACE TO FACE (OF CURB) RIGHT OF WAY TOP OF CURB FLOW LINE CENTERLINE REFERENCE LINE INVERT CORRUGATED METAL PIPE REINFORCED CONCRETE PIPE CULVERT		

UTILITY INFORMATION:

UTILITIES PRESENT:

CITY OF DE PERE UTILITIES, TOWN OF LEDGEVIEW SANITARY DISTRICT 2, BELMARK, AT&T DISTRIBUTION, TIME WARNER CABLE, AND WISCONSIN PUBLIC SERVICE CORP.

UTILITIES SHOWN ON THIS MAP ARE BASED ON LOCATES FROM:

DIGGER'S HOTLINE TICKET NUMBER 20250504621 & DATE 2/8/25, VISIBLE OBSERVATION AND RECORD UTILITY PLAN DOCUMENTS. UTILITY LINE LOCATIONS SHOULD BE VERIFIED PRIOR TO ANY DIGGING. THIS SITE MAY CONTAIN BURIED UTILITIES NOT IDENTIFIED ON THIS MAP.

DIGGERS HOTLINE = 1-800-242-8511 WATER/SANITARY/STORM SEWER: WATER/SANITARY: DEPARTMENT OF PUBLIC WORKS CITY OF DE PERE DE PERE, WI 54115 925 SIXTH ST. DE PERE, WI 54155 (920) 336-3360 (920) 339-4060 **TELECOMMUNICATIONS:**

JOB NO.

AT & T / SBC 205 S. JEFFERSON ST. GREEN BAY, WI 54301

(920) 433-4147

LEDGEVIEW SAN. DISTRICT NO. 2 3700 DICKENSON RD.

TELECOMMUNICATIONS: SPECTRUM / TIME WARNER / CHARTER 12405 POWERSCOURT DR. ST. LOUIS MO 63131

(262) 446-9821

UTILITIES: BELMARK, INC. 633 HERITAGE ROAD, DE PERE, WI 54115

(920) 336-2848


GAS & ELECTRIC: WISCONSIN PUBLIC SERVICE CORP. 2850 S. ASHLAND AV. GREEN BAY, WI 54307

NORTH

(920) 676-2717

1250 Centennial Centre Blvd | Hobart, WI | 920-662-9641 | releeinc.com

	Dial or (800 www.DiggersHot) 242-8511	TO OBTAIN LOCATION OF PARTICIPAN JNDERGROUND FACILITIES BEFORE Y DIG IN WISCONSIN WIS. STATUTE 182.0175 (1974) REQUIRES MIN. OF 3 WORK DAYS NOTICE BEFORE YOU EXCAVATE.	0 40	N FEET
ND D	EMOLITION PLAN	DATE 03/2025 FILE 1703129T		Robert E. Lee & Associates, Inc.	SHEET NO.

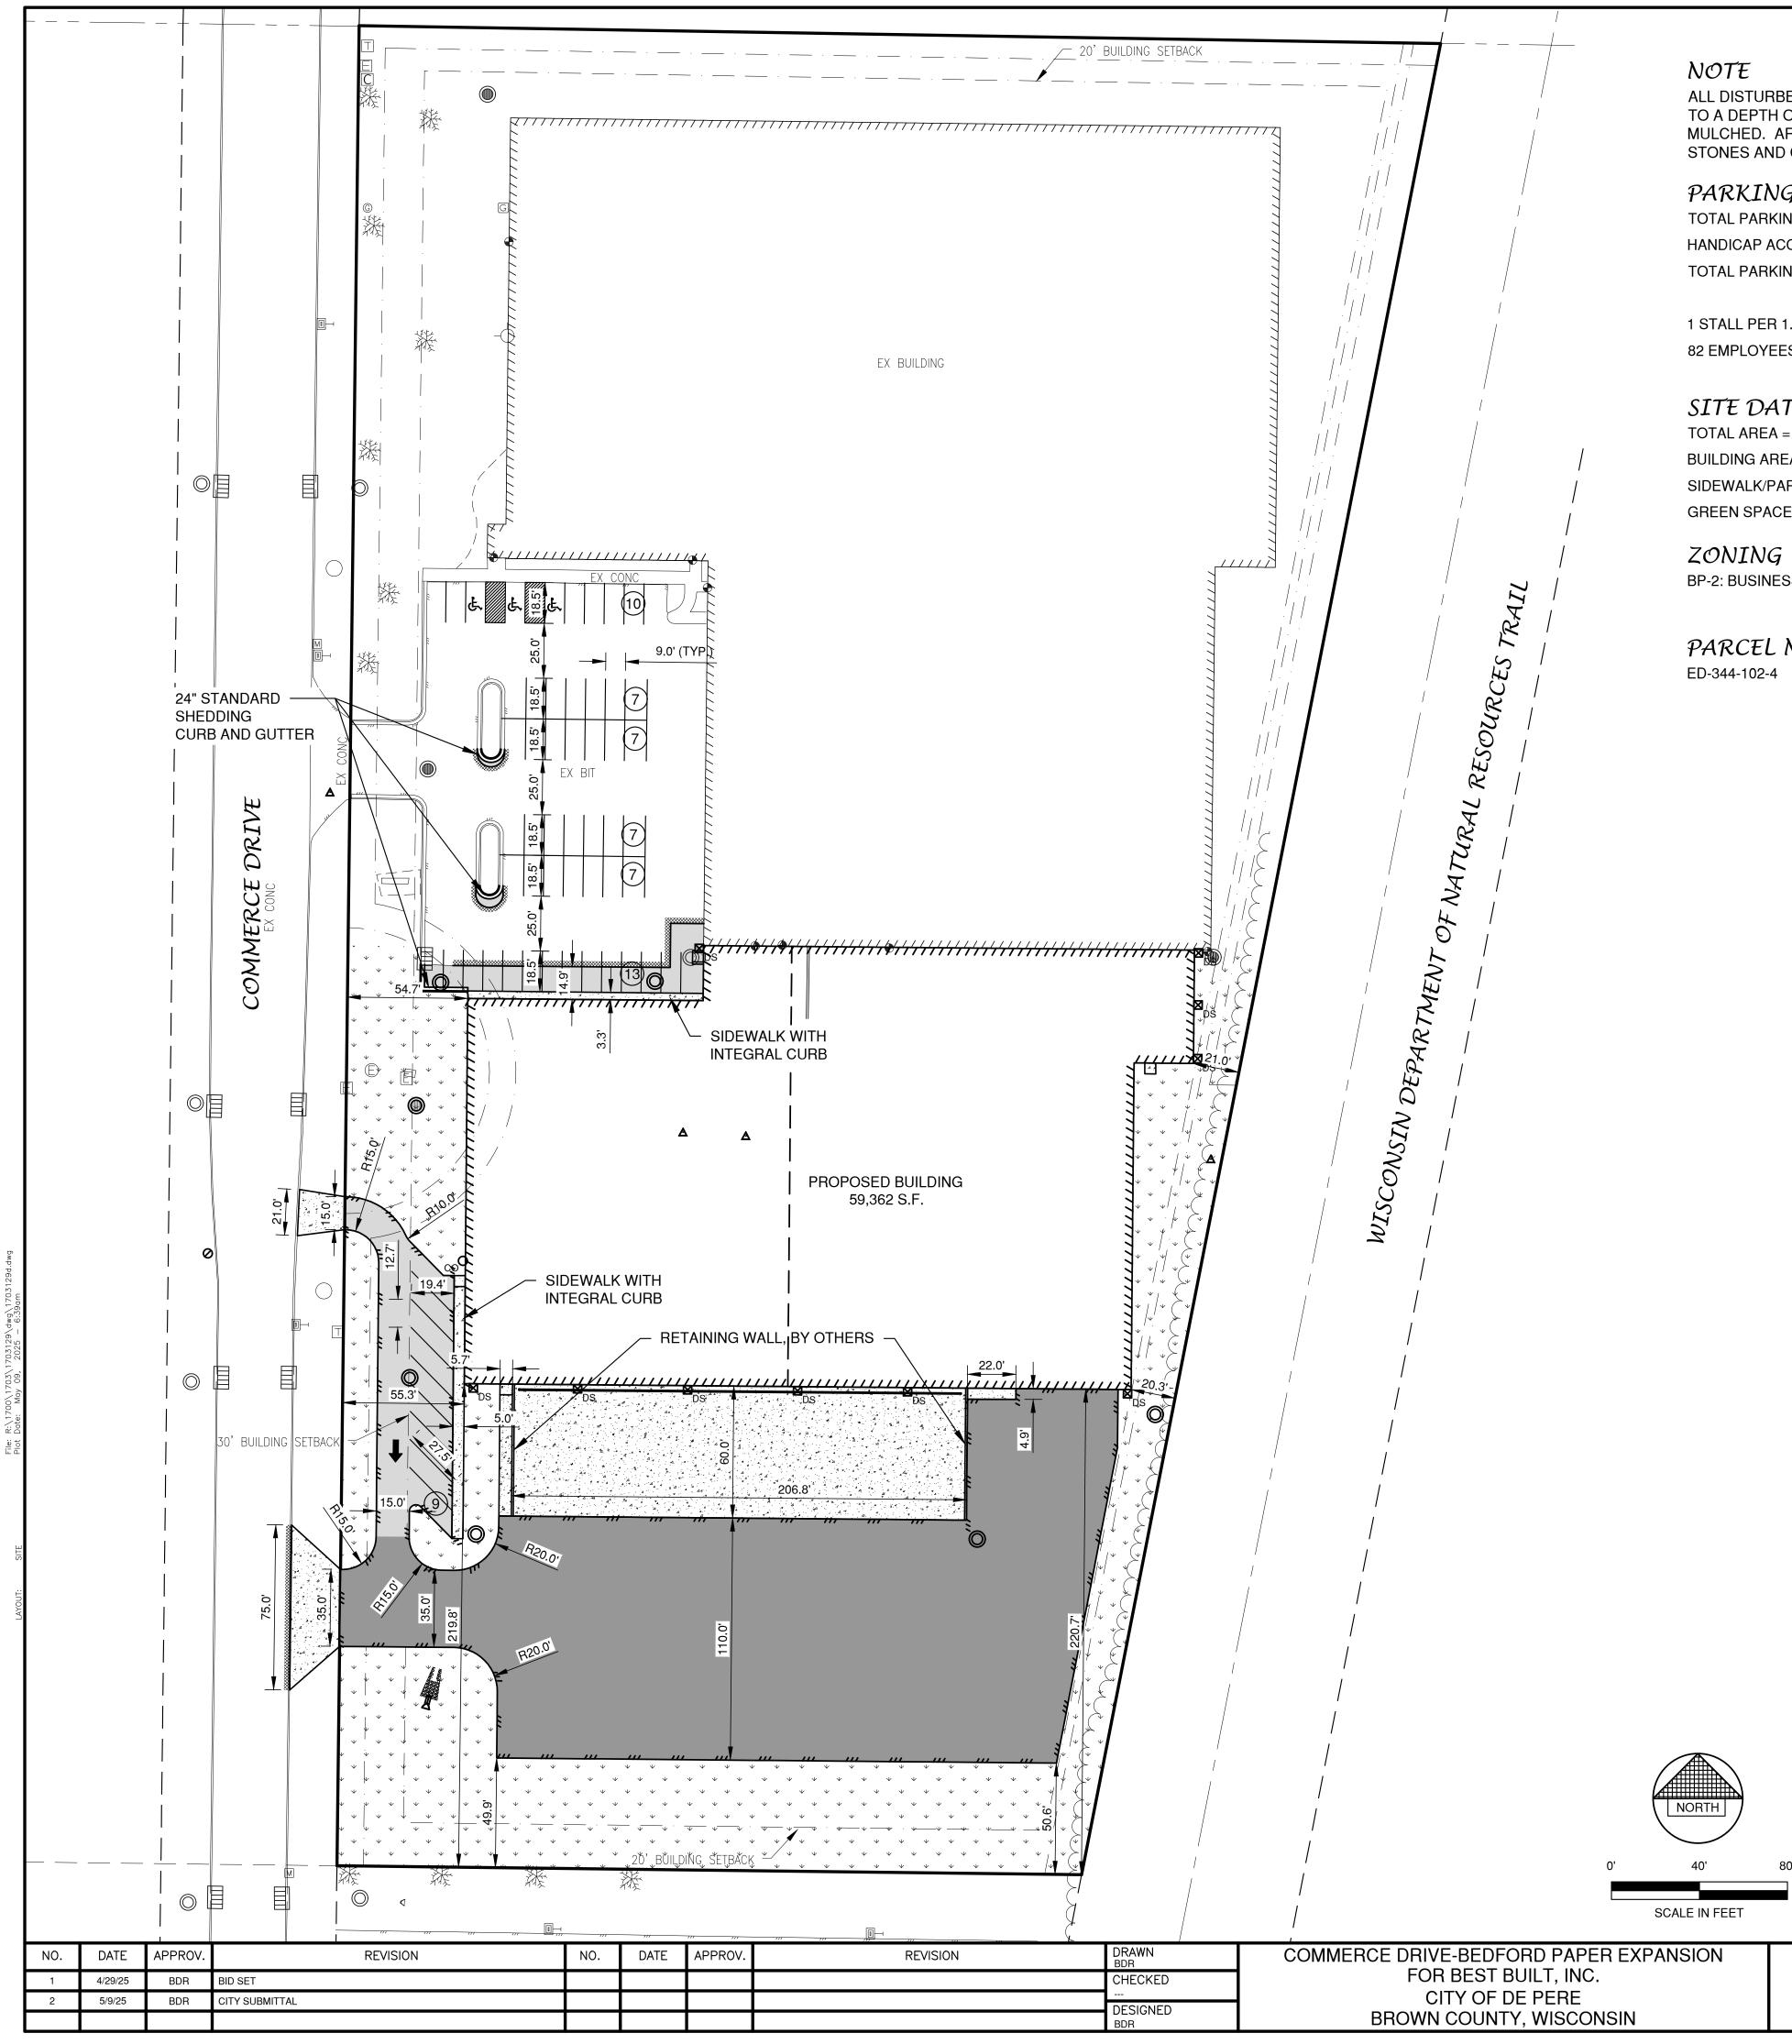

ALL DISTURBED AREAS SHALL BE TOPSOILED TO A DEPTH OF 6 INCHES, SEEDED AND MULCHED. AREA TO BE RAKED FREE OF STONES AND CLUMPS.

PARKING DATA

TOTAL PARKING STALLS PROVIDED = 60 HANDICAP ACCESSIBLE PARKING STALLS = 3 TOTAL PARKING STALLS REQUIRED = 55

1 STALL PER 1.5 EMPLOYEES 82 EMPLOYEES/1.5 EMPLOYEES = 55 STALLS

SITE DATA


TOTAL AREA = 7.96 ACRES, 346,837 S.F. BUILDING AREA = 3.90 ACRES, 169,760 S.F. (48.9%) SIDEWALK/PARKING LOT AREA = 1.85 ACRES, 80,514 S.F. (23.2%) GREEN SPACE = 2.22 ACRES, 96,563 S.F. (27.9%)

BP-2: BUSINESS PARK 2

PARCEL NO.

SITE PLAN

	CONCRETE PAVEMENT (12,685 S.F.)
	ASPHALT PAVEMENT (LIGHT) (6,472 S.F.)
	ASPHALT PAVEMENT (HEAVY) (36,008 S.F.)
	LANDSCAPE AREA
* * * * `	GREEN SPACE
	PROPOSED 24" STANDARD SHEDDING CURB AND GUTTER
	TRAFFIC FLOW ARROW
Ŀ,	HANDICAPPED PARKING

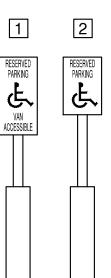



\bigtriangledown	WALL PACK
0	LIGHT POLE (1 LAMP)
⊳ੁੰਰ	LIGHT POLE (2 LAMPS)
ь С	LIGHT POLE (3 LAMPS)

PARKING STALLS

INDICATES NUMBER OF

SIGN

Ib

(12)


LIGHT POLE (4 LAMPS)

*NOTE:

ALL DIMENSIONS ARE TO THE FACE OF CURB, UNLESS NOTED OTHERWISE



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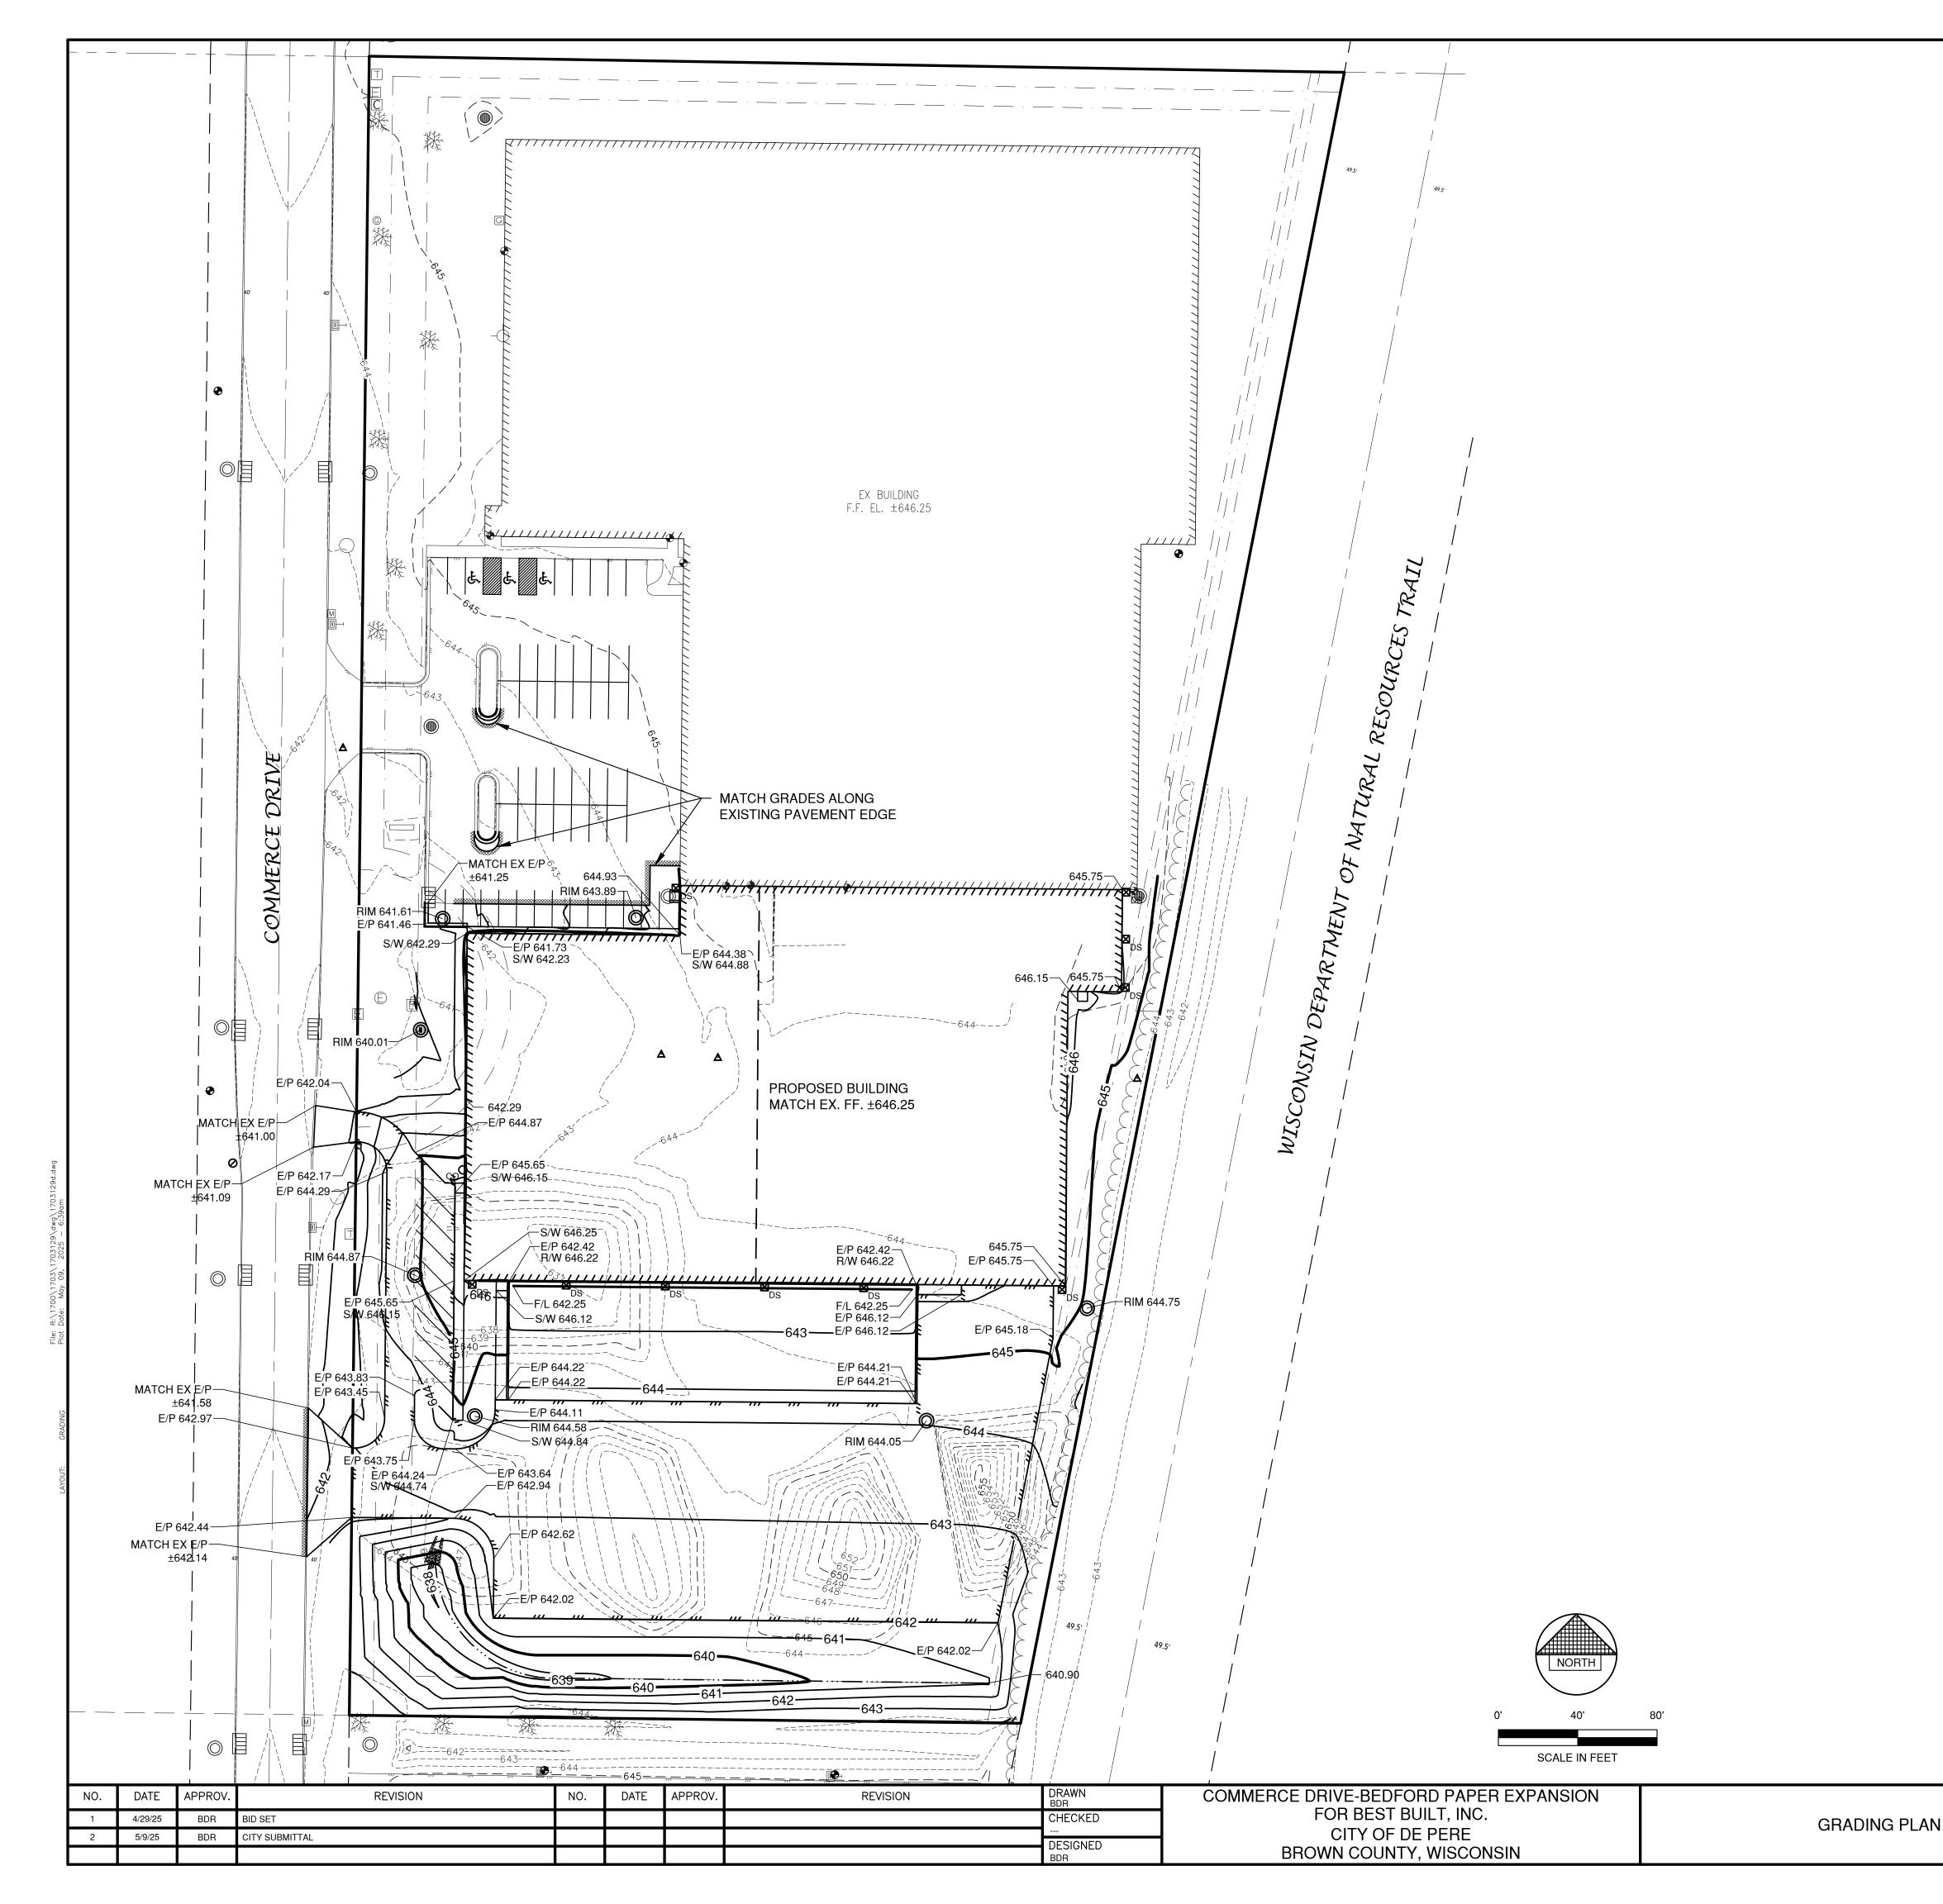
10ST		LEGEND PROPOSED SANITARY SEWER EXISTING SANITARY SEWER (SIZE NOTED) PROPOSED STORM SEWER EXISTING STORM SEWER (SIZE NOTED) PROPOSED WATERMAIN EXISTING WATERMAIN (SIZE NOTED)
	⊗ ⊗ ⊘ ⊡ ⊡	 TRACER WIRE SIGNAL CONNECTION BOX CLEANOUT STORM MANHOLE STORM INLET (NOT IN CURB AND GUTTER) STORM INLET (IN CURB AND GUTTER) STORM INLET MANHOLE YARD DRAIN STANDPIPE

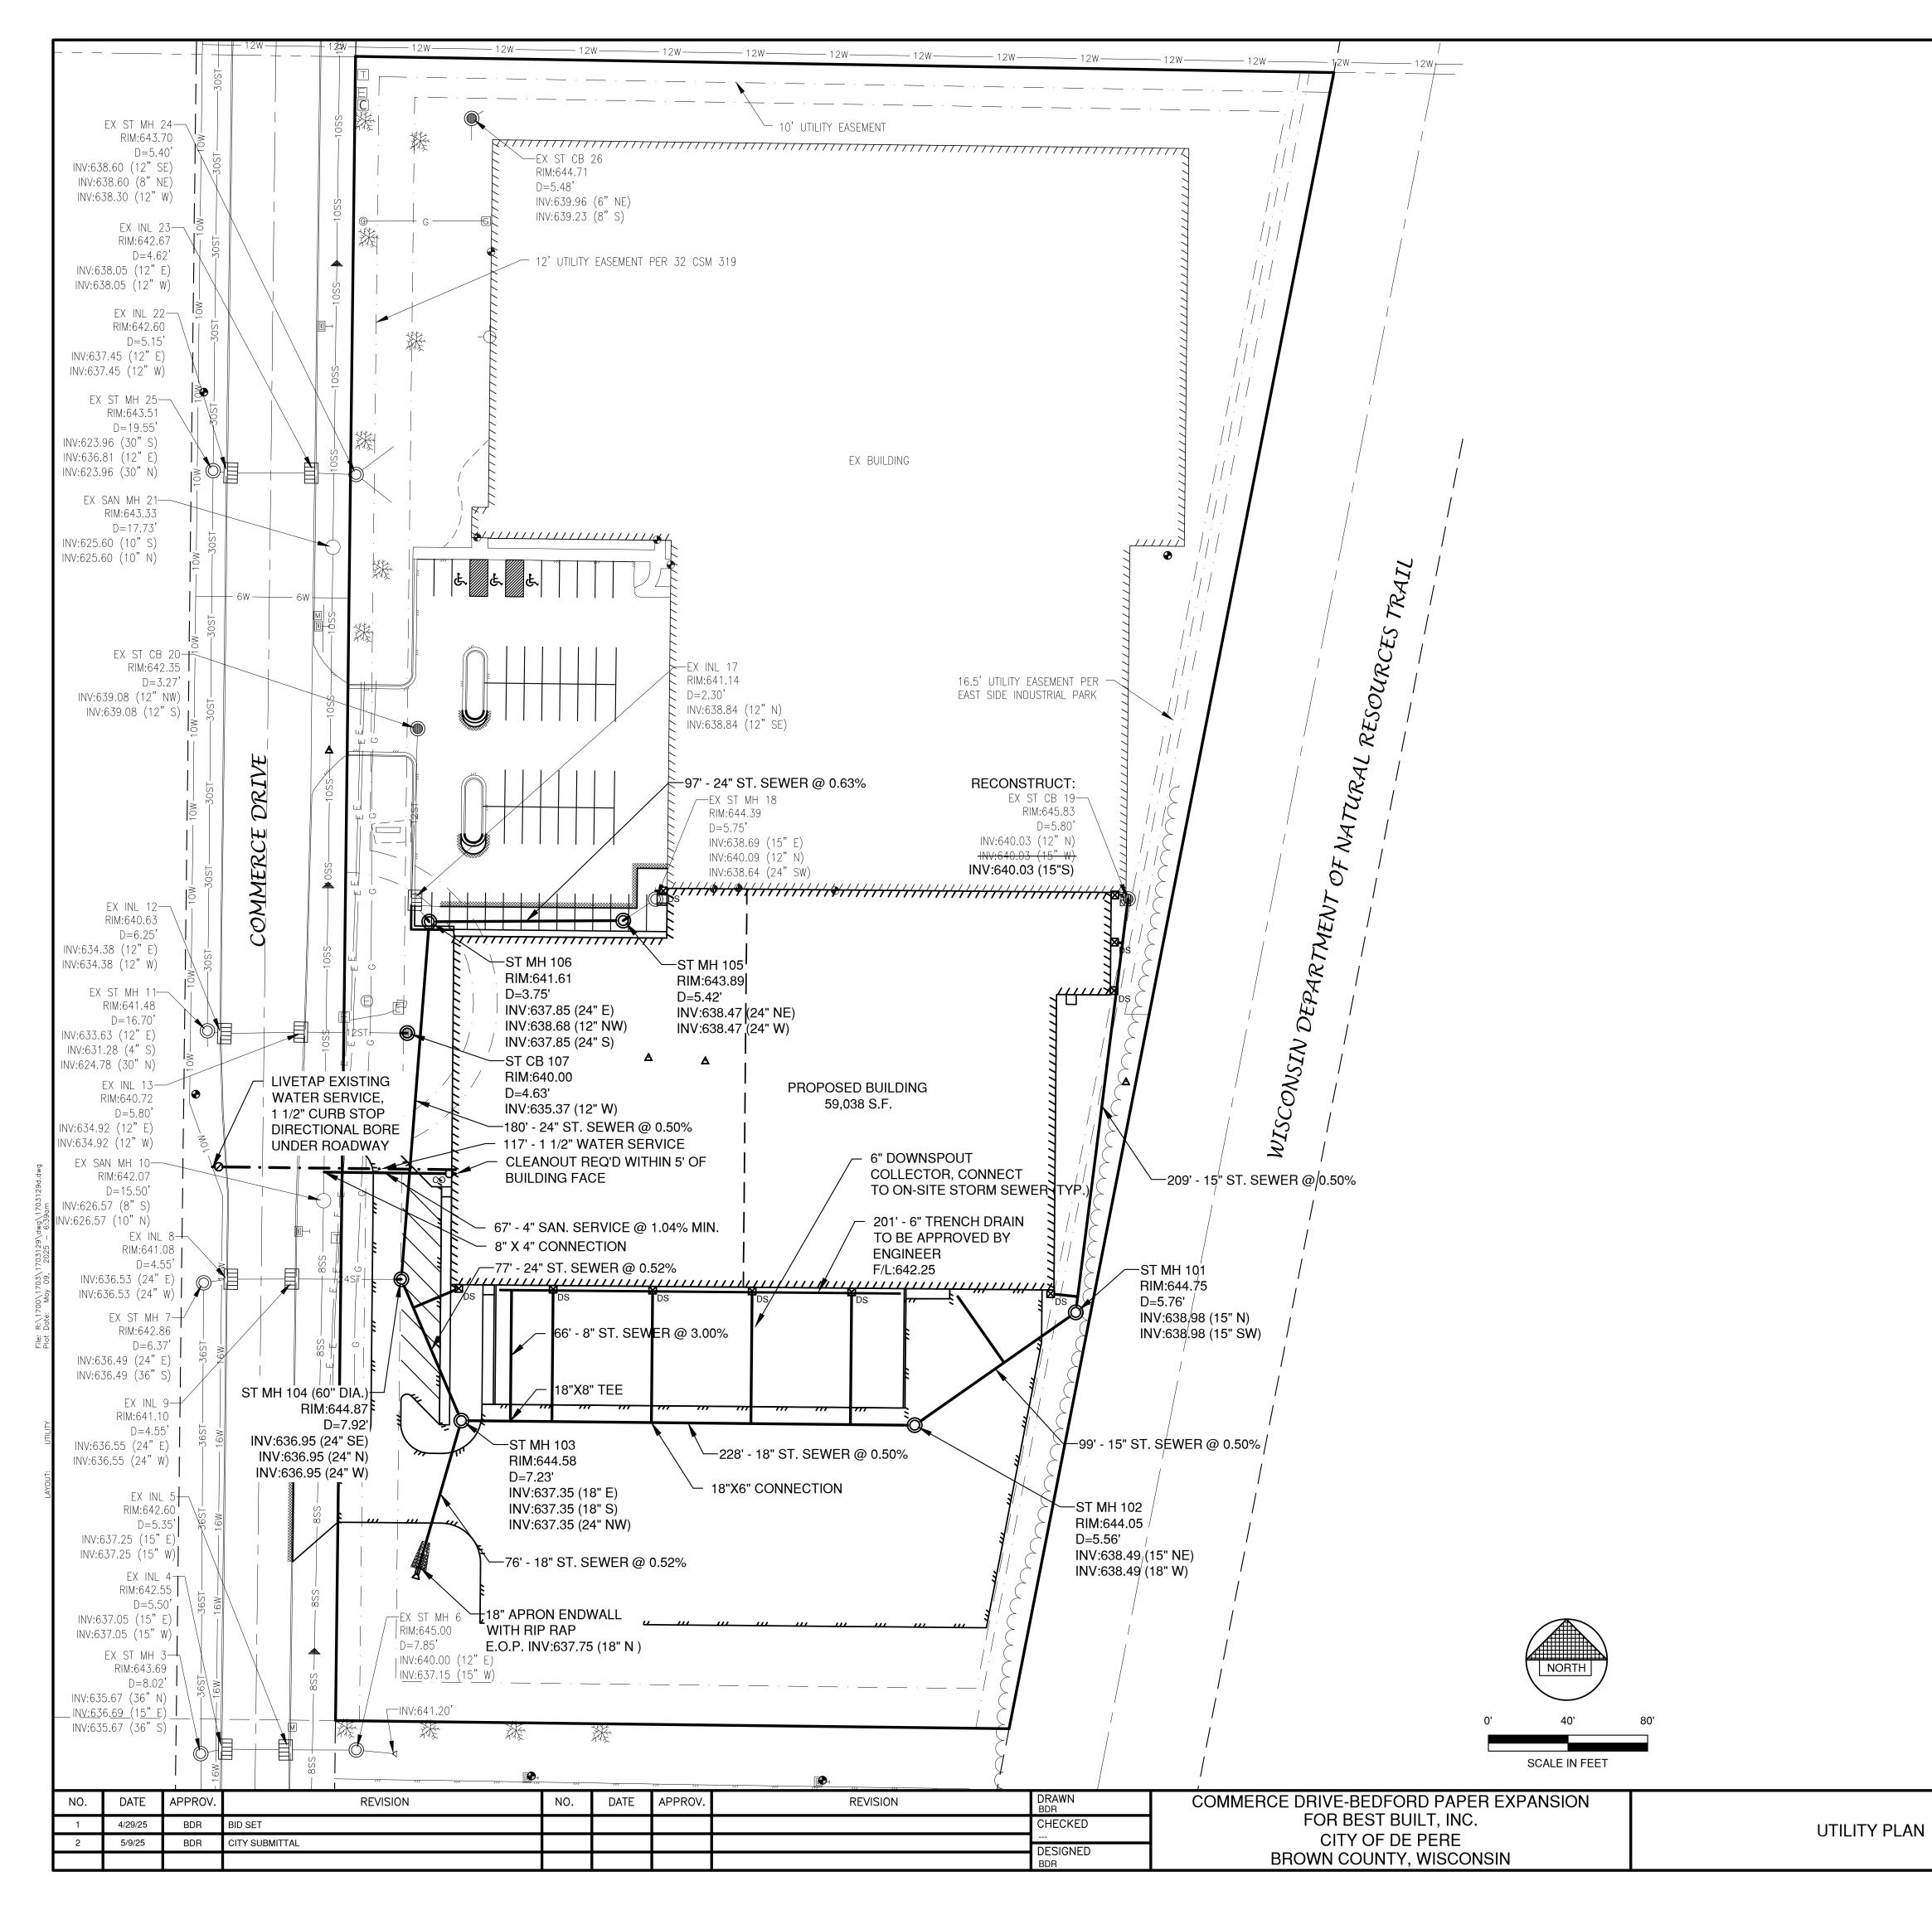
NOTE

- 1. A MINIMUM OF 6.5 FEET OF COVER SHALL BE MAINTAINED OVER ALL WATERMAIN.
- 2. SANITARY SEWER, WATERMAIN AND STORM SEWER SHALL BE CONSTRUCTED IN ACCORDANCE WITH THE CURRENT STANDARD SPECIFICATIONS FOR SEWER AND WATER CONSTRUCTION IN WISCONSIN AND ADMINISTRATIVE CODE CHAPTERS SPS 381-387.
- 3. FIELD VERIFY LOCATION OF EXISTING UTILITIES. IF EXISTING LOCATIONS DIFFER FROM WHAT IS INDICATED ON THE PLANS, **CONTACT ENGINEER**, PRIOR TO CONTINUED WORK.
- 4. ALL SANITARY SEWER, STORM SEWER AND WATER SERVICES / MAINS SHALL BE PROVIDED WITH TRACER WIRE OR OTHER METHOD TO BE LOCATED.
- 5. EXISTING GAS, ELECTRIC, CABLE TELEVISION AND TELEPHONE TO BE REMOVED AND/OR RELOCATED BY OTHERS. WORK SHALL BE COORDINATED BY GENERAL CONTRACTOR.




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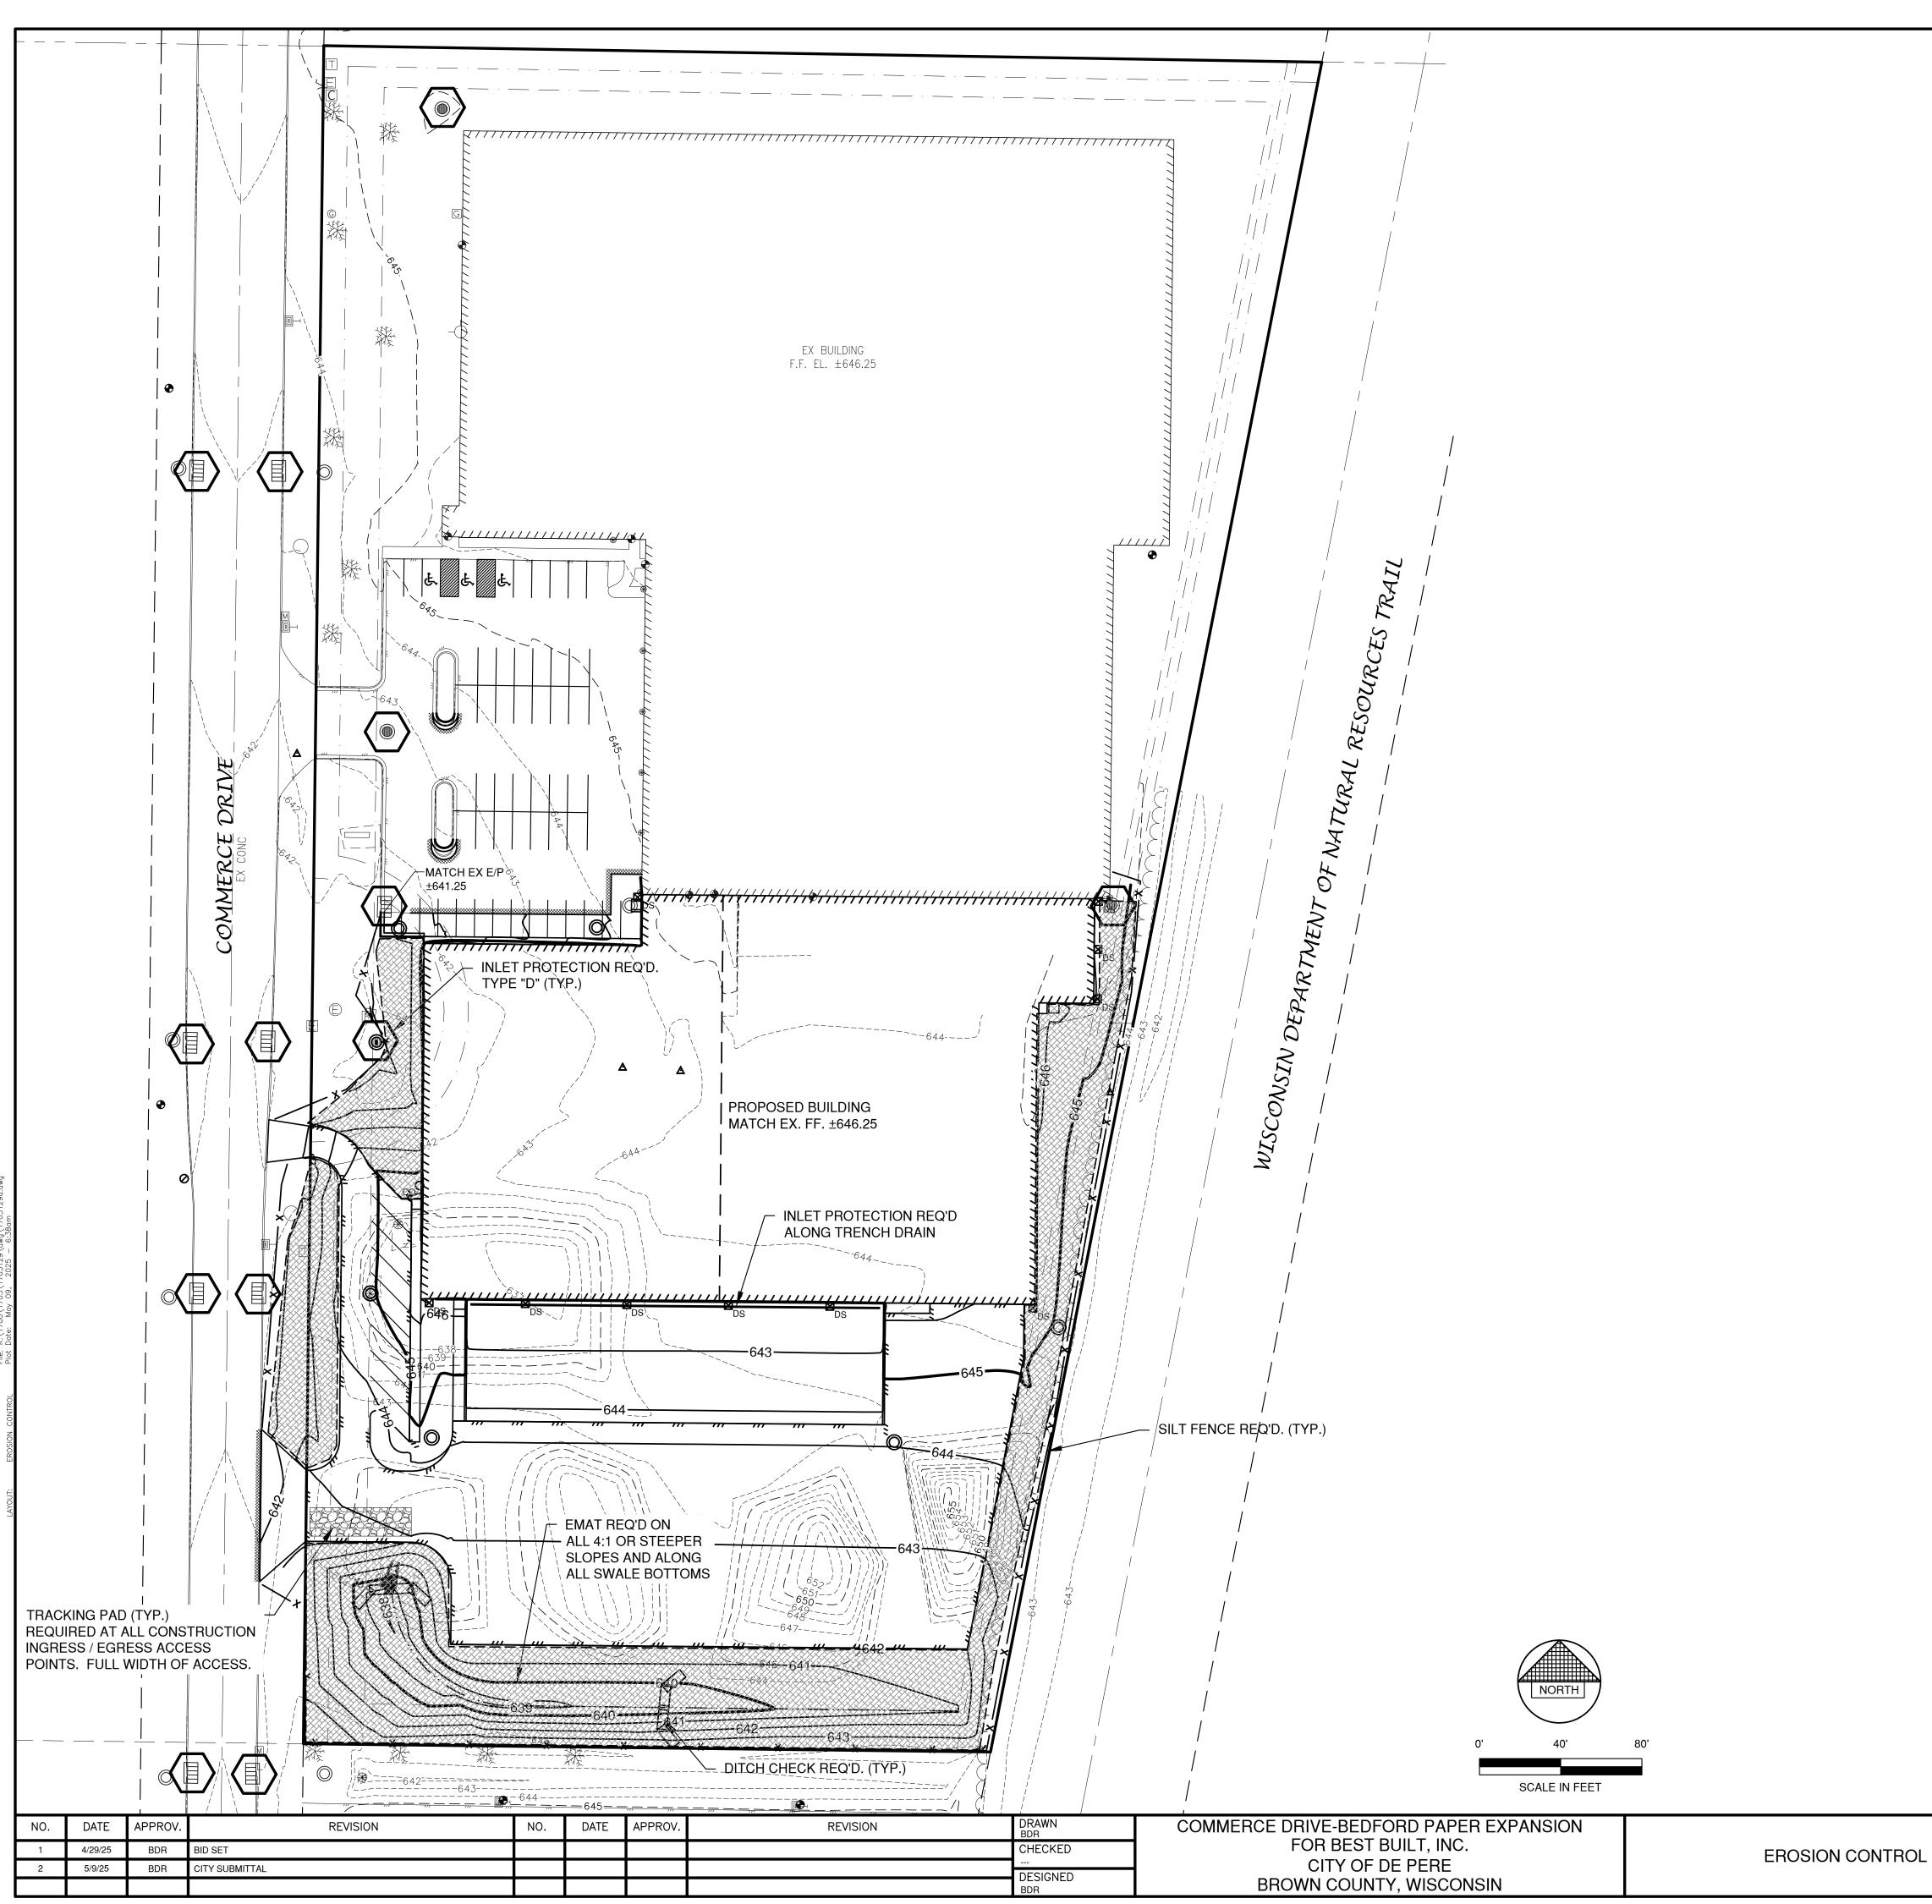
NOTE

CONTRACTOR TO TEMPORARILY BUILD GRAVEL BASE COURSE TO FINAL PAVEMENT ELEVATION FOR LOADING DOCK RAMPS AND TEST RAMP FOR PROPER TRUCK ALIGNMENT TO LOADING DOCK PRIOR TO PAVING.

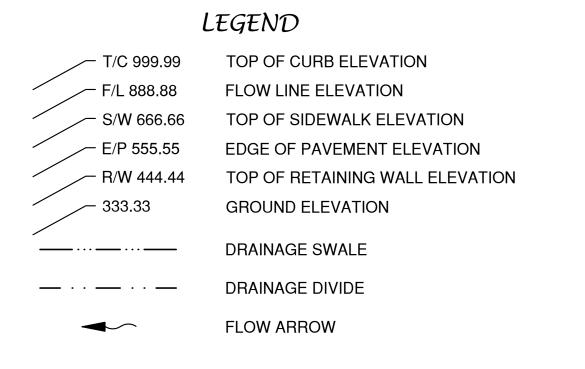

PRELIMINARY
Not for Construction

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LEGEND

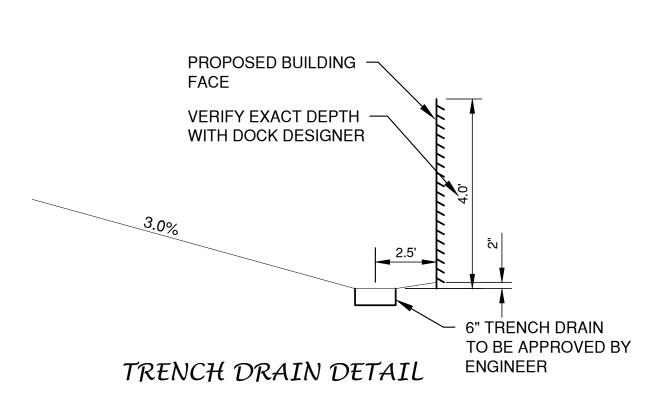DRAINAGE SWALE

DRAINAGE DIVIDE

FLOW ARROW

_____X _____

_____ · · · · ____ · · · · ____

_ · · ___ · · ___

 \checkmark

SILT FENCE (PER WDNR TECHNICAL STANDARD 1056) DITCH CHECK (PER WDNR TECHNICAL STANDARD 1062) TRACKING PAD (PER WDNR TECHNICAL STANDARD 1057) EROSION MAT (PER WDNR TECHNICAL STANDARD 1053)

INLET PROTECTION (PER WDNR TECHNICAL STANDARD 1060)


EROSION CONTROL

ALL EROSION CONTROL PRACTICES INDICATED ON THIS PLAN ARE APPROXIMATE LOCATIONS ONLY. THE ACTUAL SITE MAY REQUIRE MORE OR LESS EROSION CONTROL DEPENDING ON THE CURRENT CONDITION OF THE SITE.


- 1. SILT FENCE IS REQUIRED DOWNSLOPE OF ANY DISTURBED LAND THAT MAY CARRY SEDIMENTS OFF SITE.
- 2. A TRACKING PAD IS REQUIRED AT ANY INGRESS/EGRESS LOCATION, WHERE SEDIMENT MAY BE TRACKED OFF-SITE.
- 3. PROPER INLET PROTECTION SHALL BE USED DEPENDING ON THE INLET TYPE.
- 4. ALL NECESSARY SITE DEWATERING SHALL BE PERFORMED IN ACCORDANCE WITH WDNR TECHNICAL STANDARD 1061.




	DATE 03/2025	Robert E. Lee	SHEET NO
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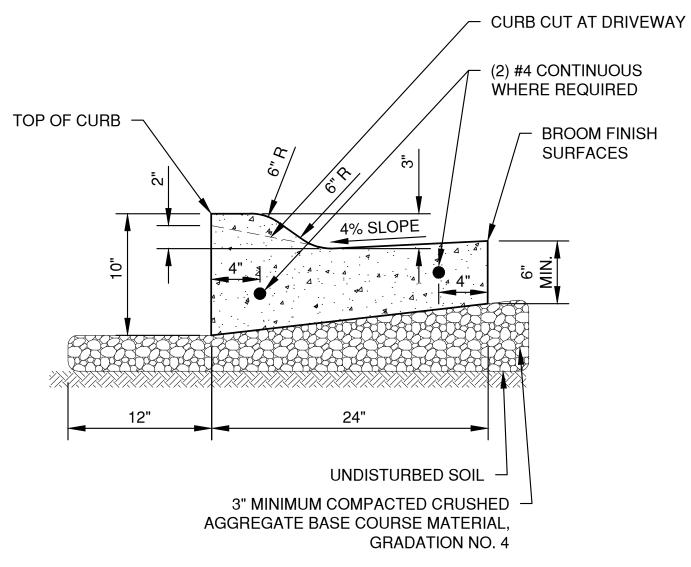


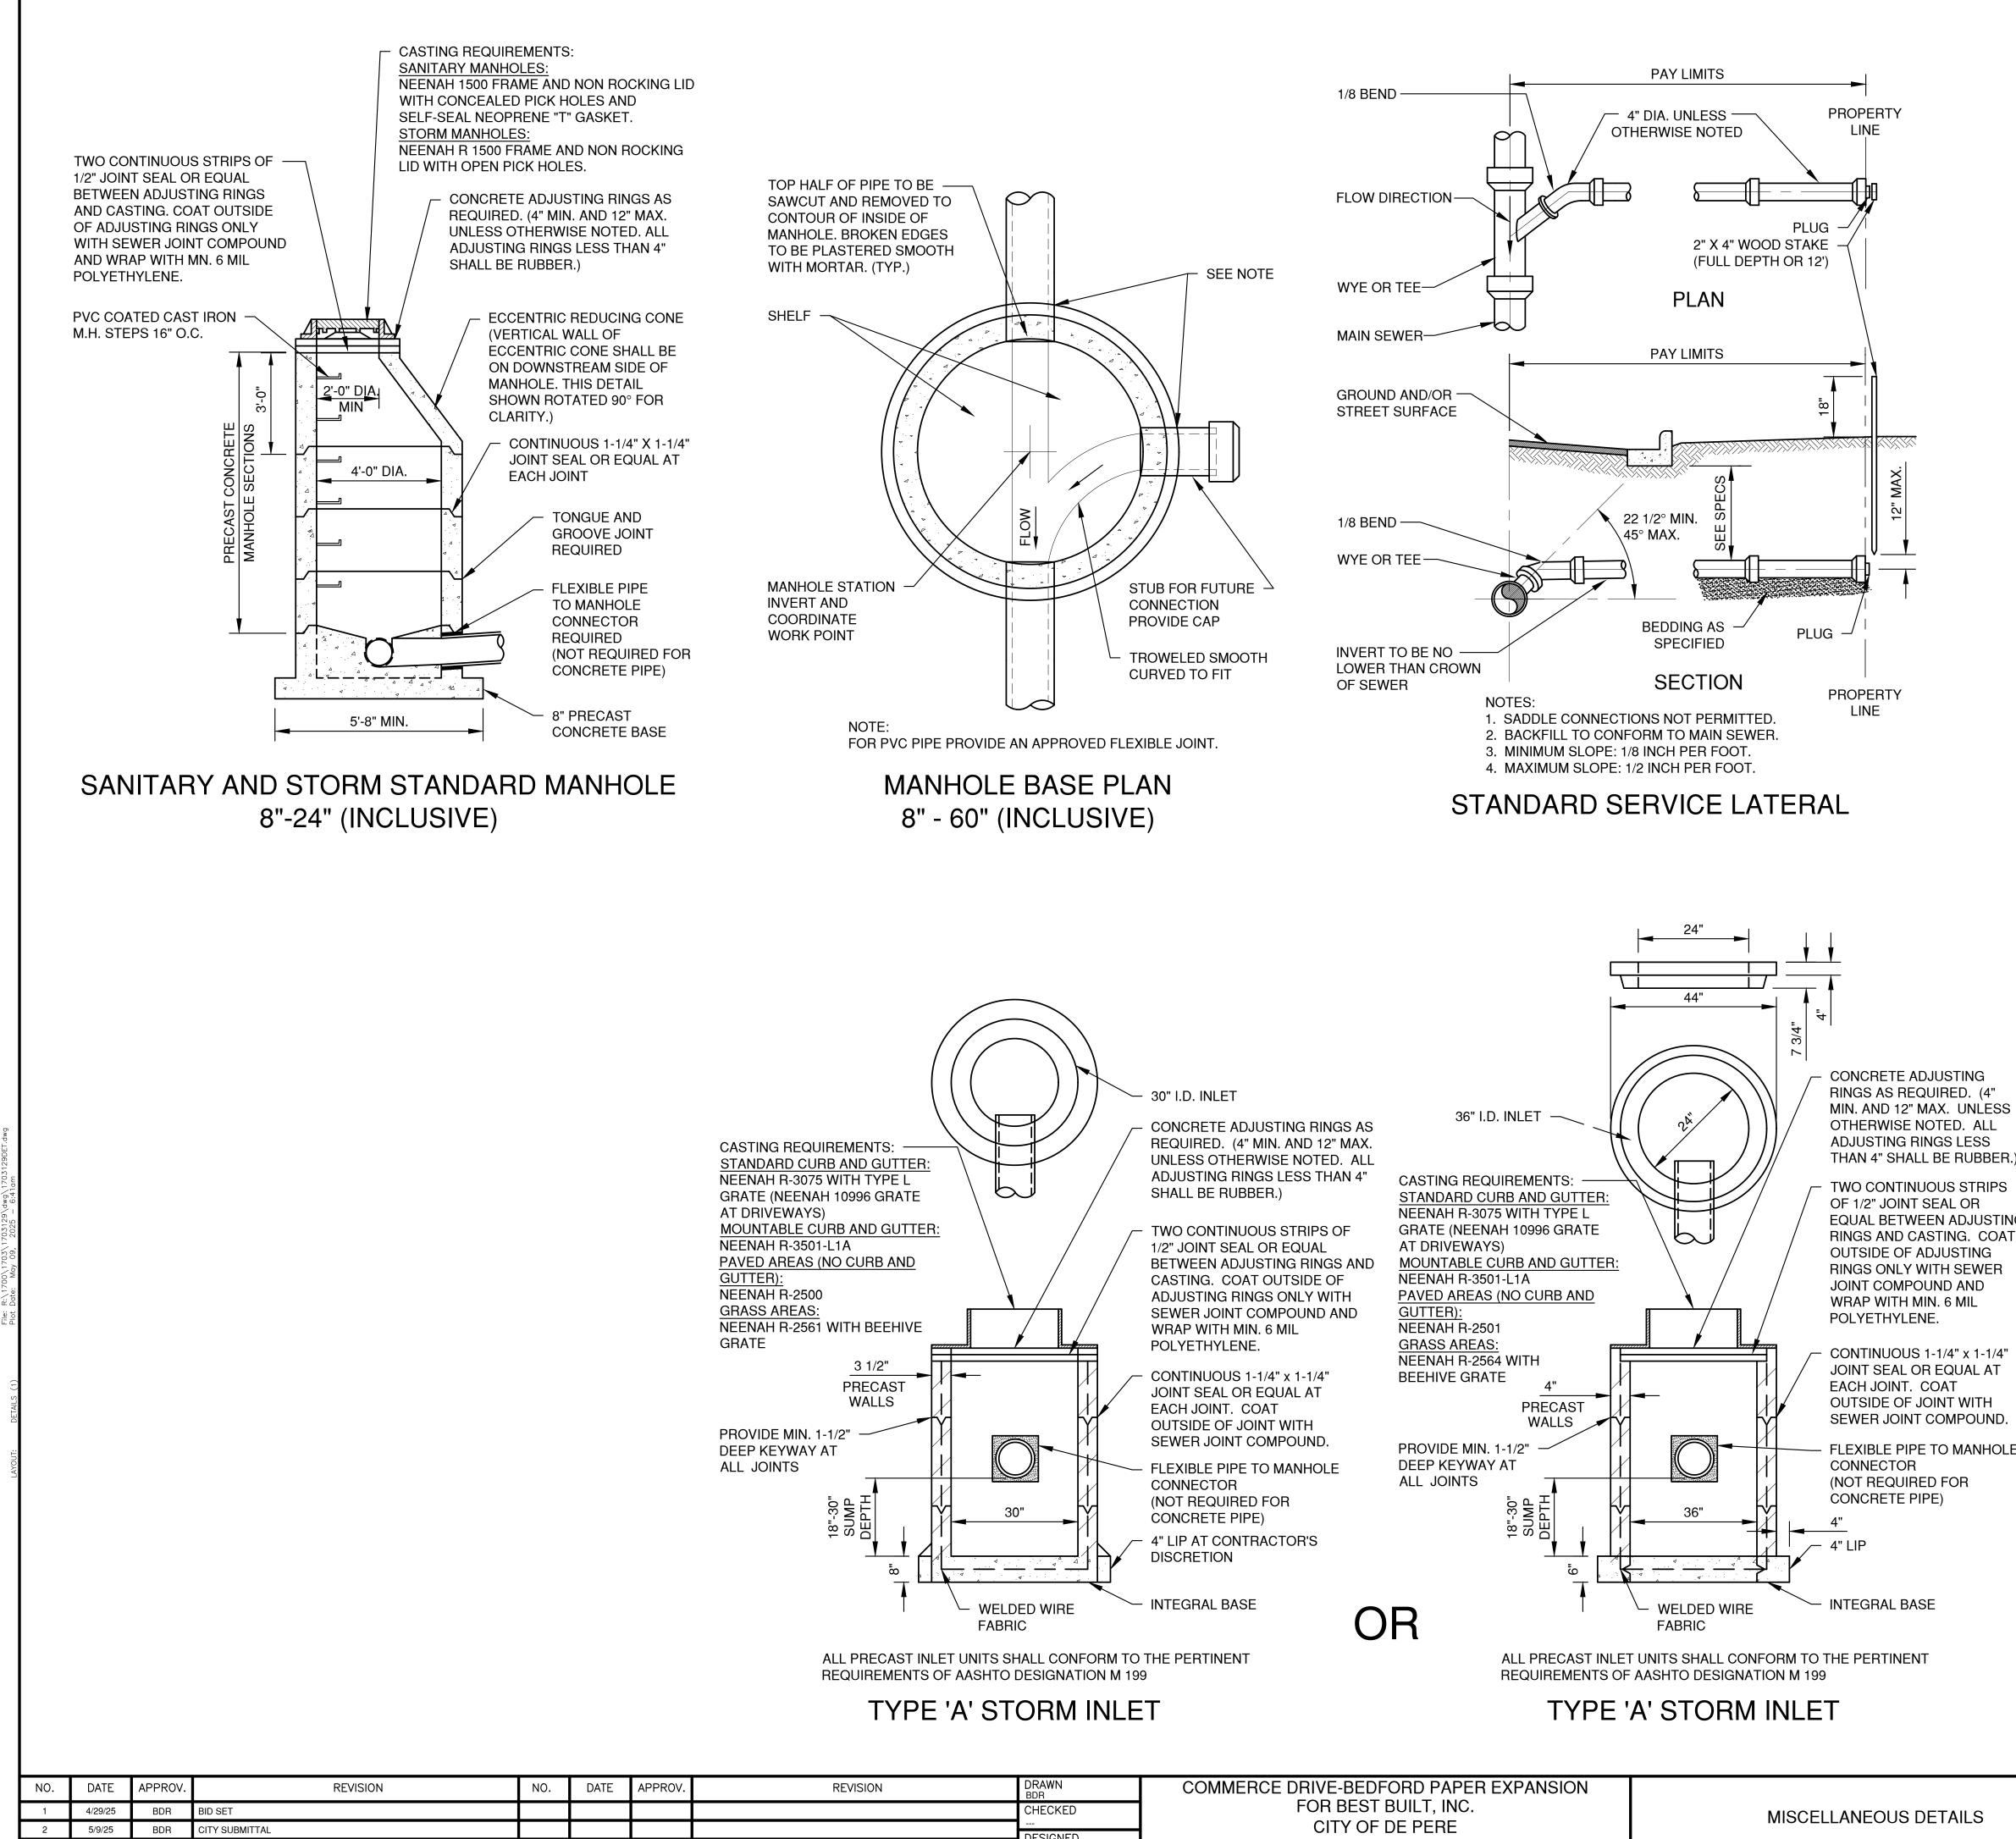DRAWN BDR	COMMERCE DRIVE-BEDFORD PAPER EXPANSION	
CHECKED	FOR BEST BUILT, INC.	MISCELLANEOUS DE
	CITY OF DE PERE	
DESIGNED BDR	BROWN COUNTY, WISCONSIN	



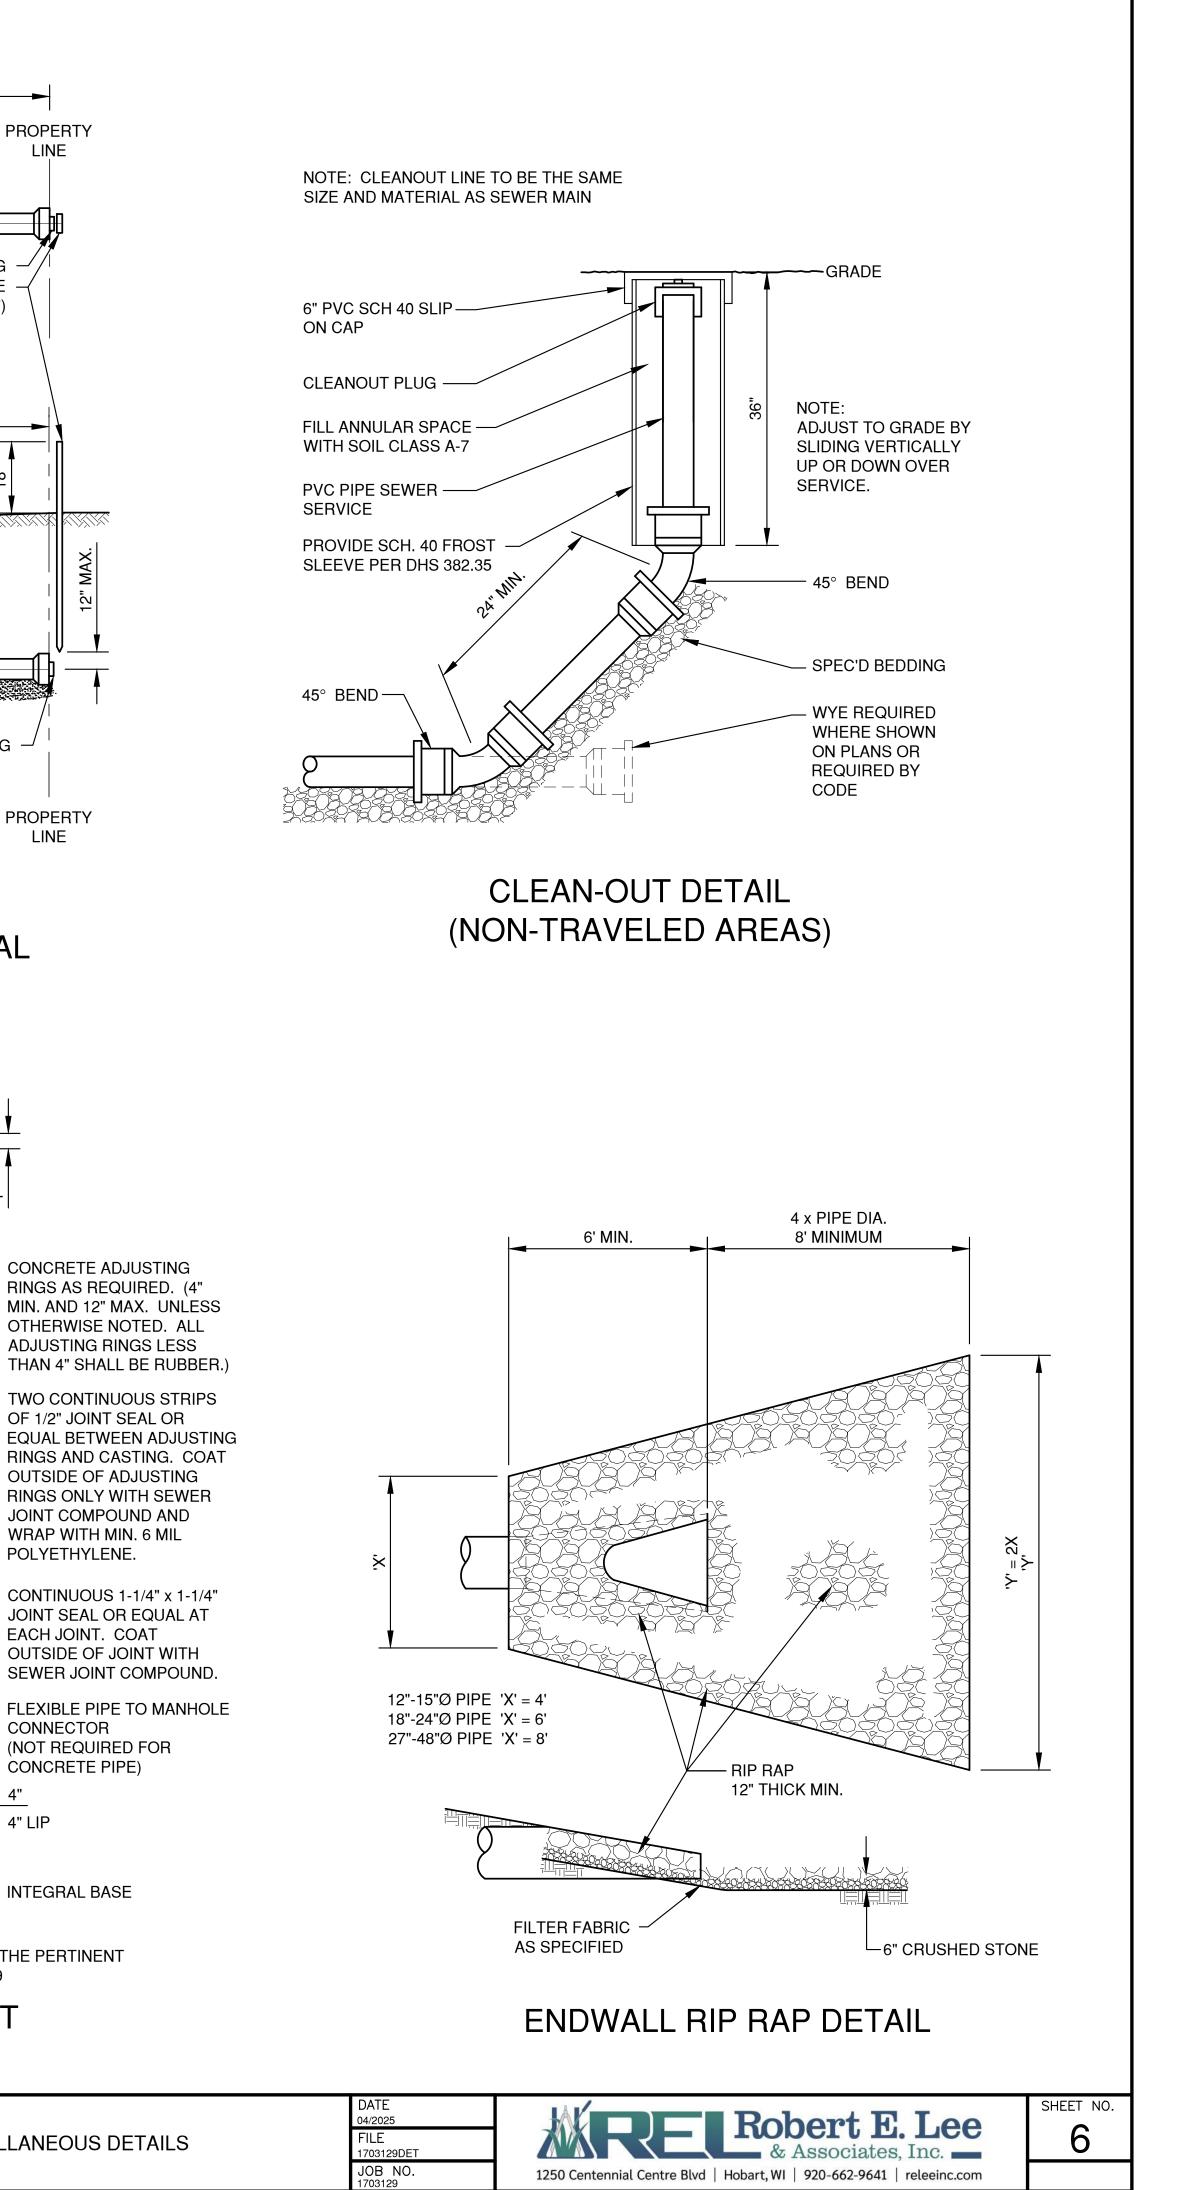


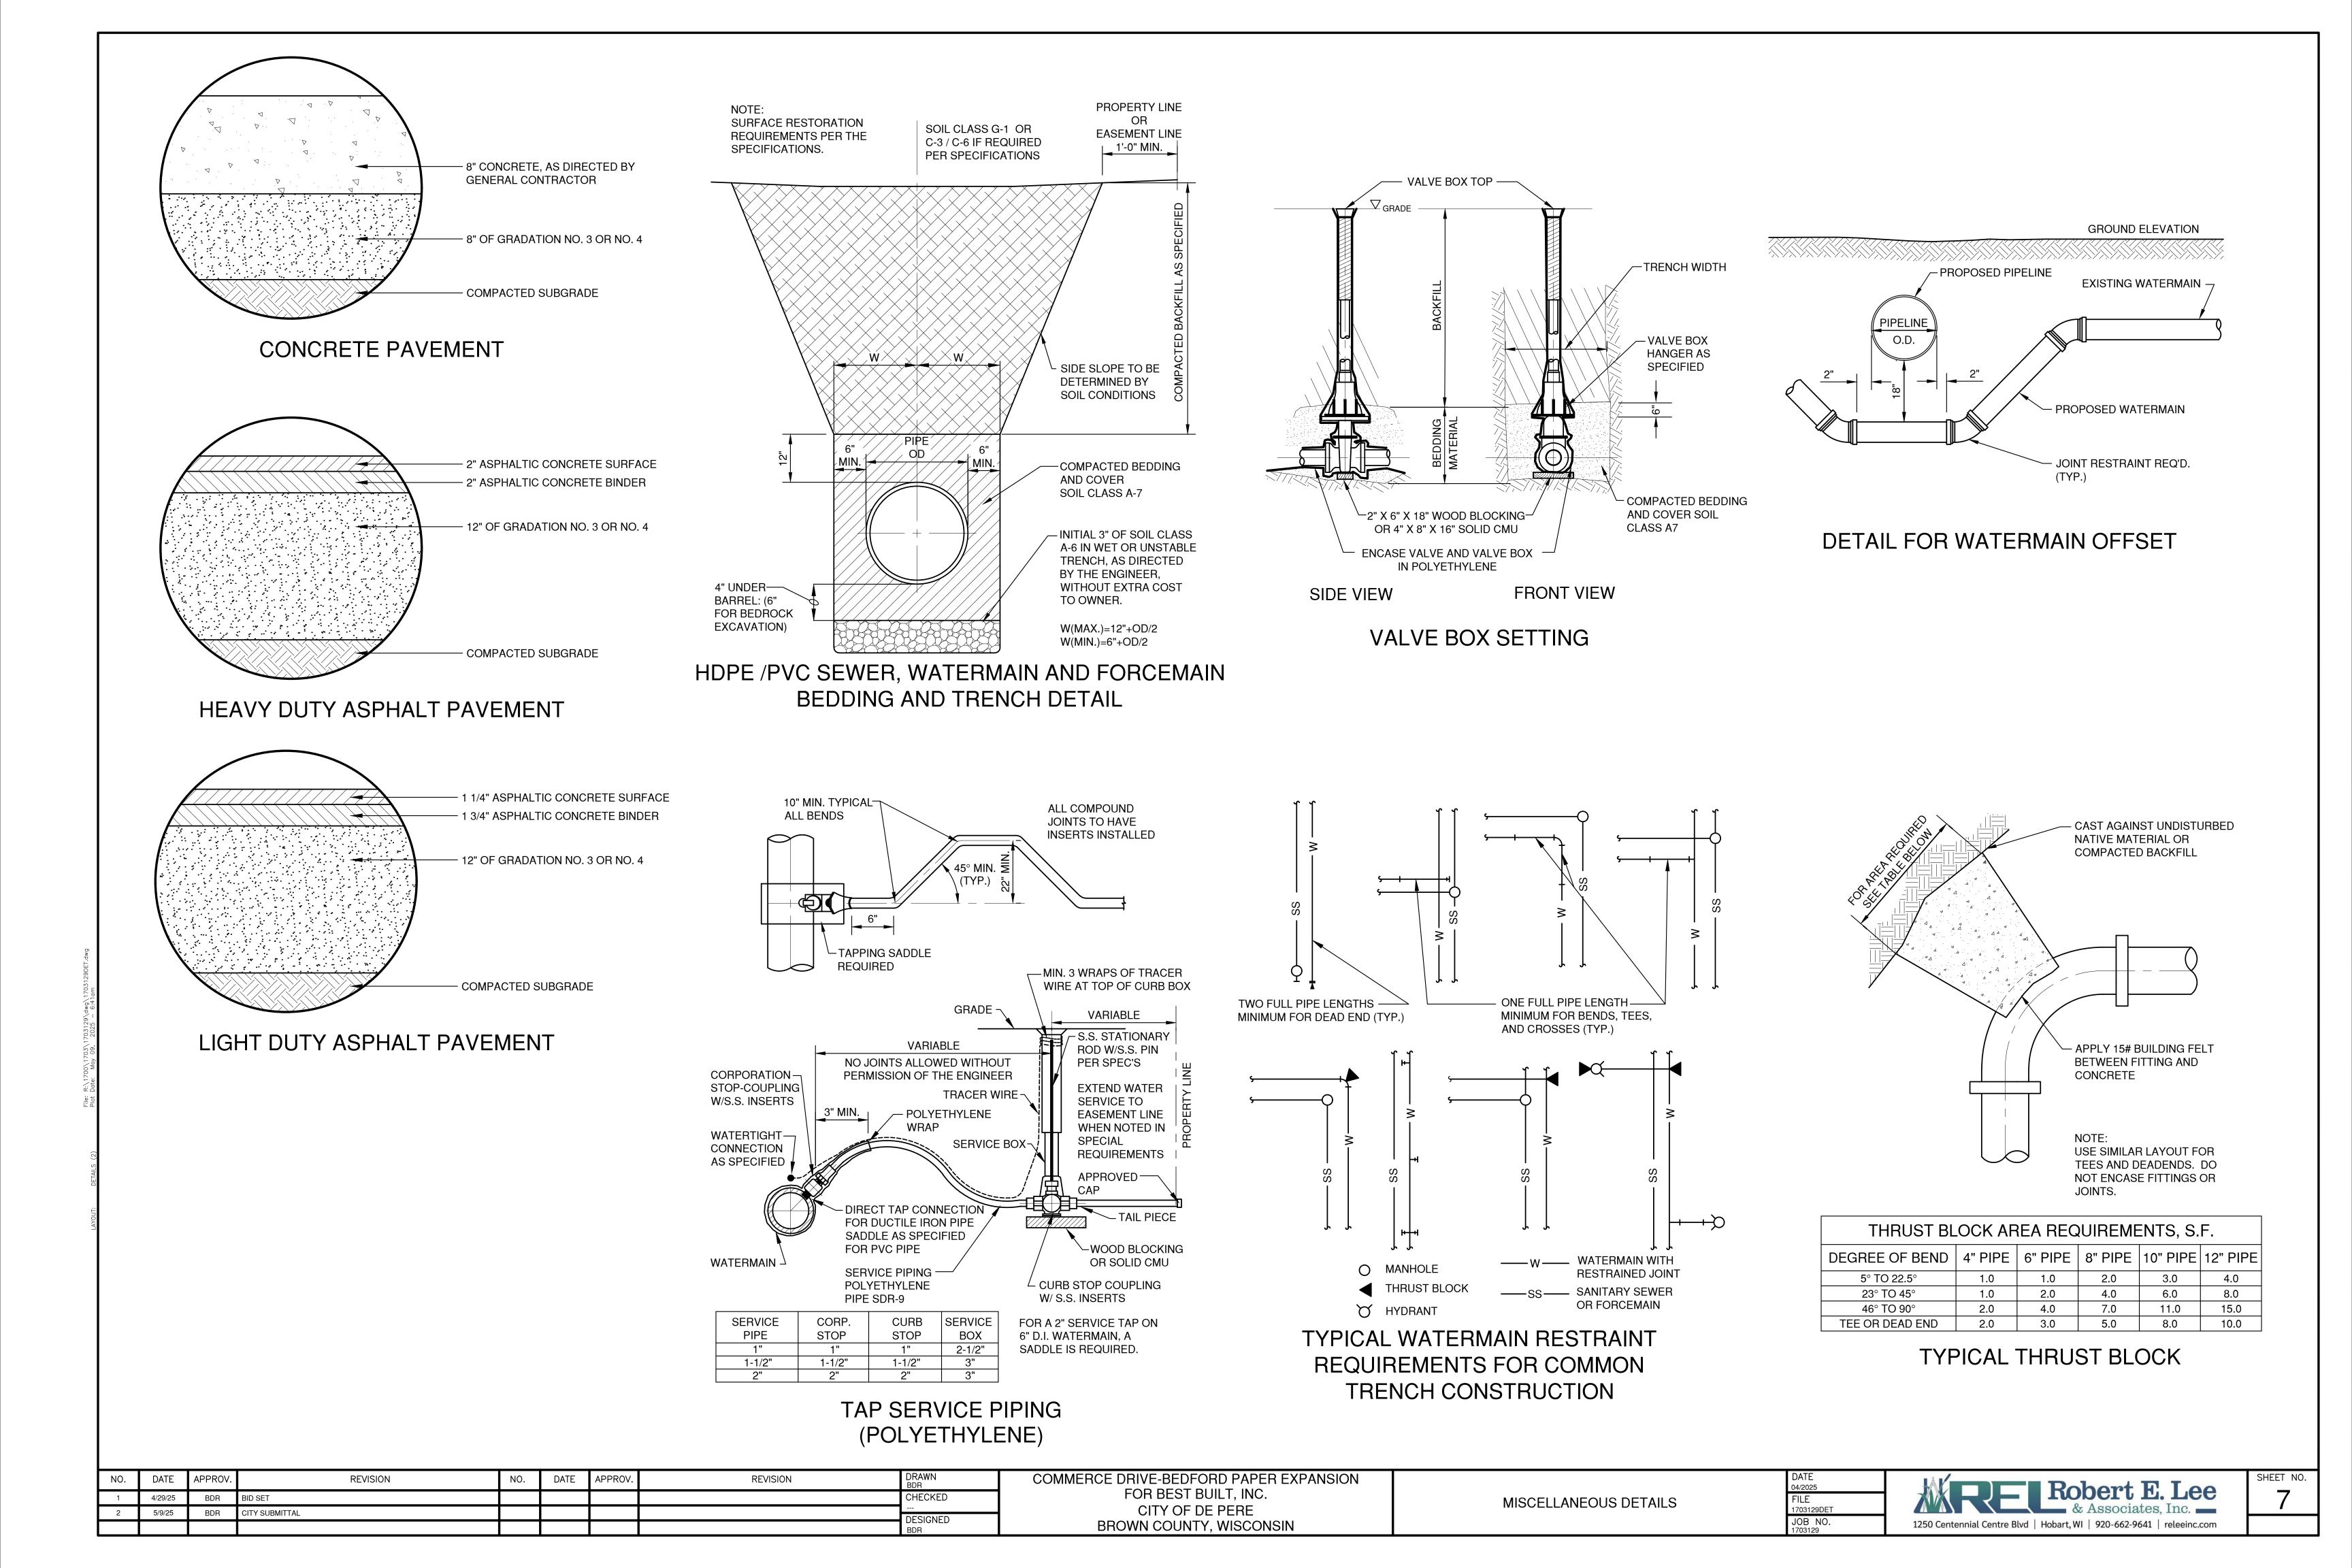	-			_	-	-				
NO.	DATE	APPROV.	REVISION	NO.	DATE	APPROV.	REVISION	DRAWN BDR	COMMERCE DRIVE-BEDFORD PAPER EXPANSION	
1	4/29/25	BDR	BID SET					CHECKED	FOR BEST BUILT, INC.	MISCELLANEOUS DET
2	5/9/25	BDR	CITY SUBMITTAL					 DESIGNED	CITY OF DE PERE	
								BDR	BROWN COUNTY, WISCONSIN	



- 1. PROVIDE 1" EXPANSION JOINTS AT 300' INTERVALS OR AS SPECIFIED. PROVIDE CONTRACTION JOINTS EVERY 30' OR AS DIRECTED.
- 2. AT REMOVAL AND REPLACEMENT AREAS AND AT TIE-INS TO EXISTING CURB AND GUTTER, PROVIDE (2) #4 BARS, 18" LONG. DRILL AND GROUT INTO EXISTING CURB AND GUTTER 9". MATCH EXISTING SLOPE OF EXISTING GUTTER PAN.


MOUNTABLE CURB AND GUTTER

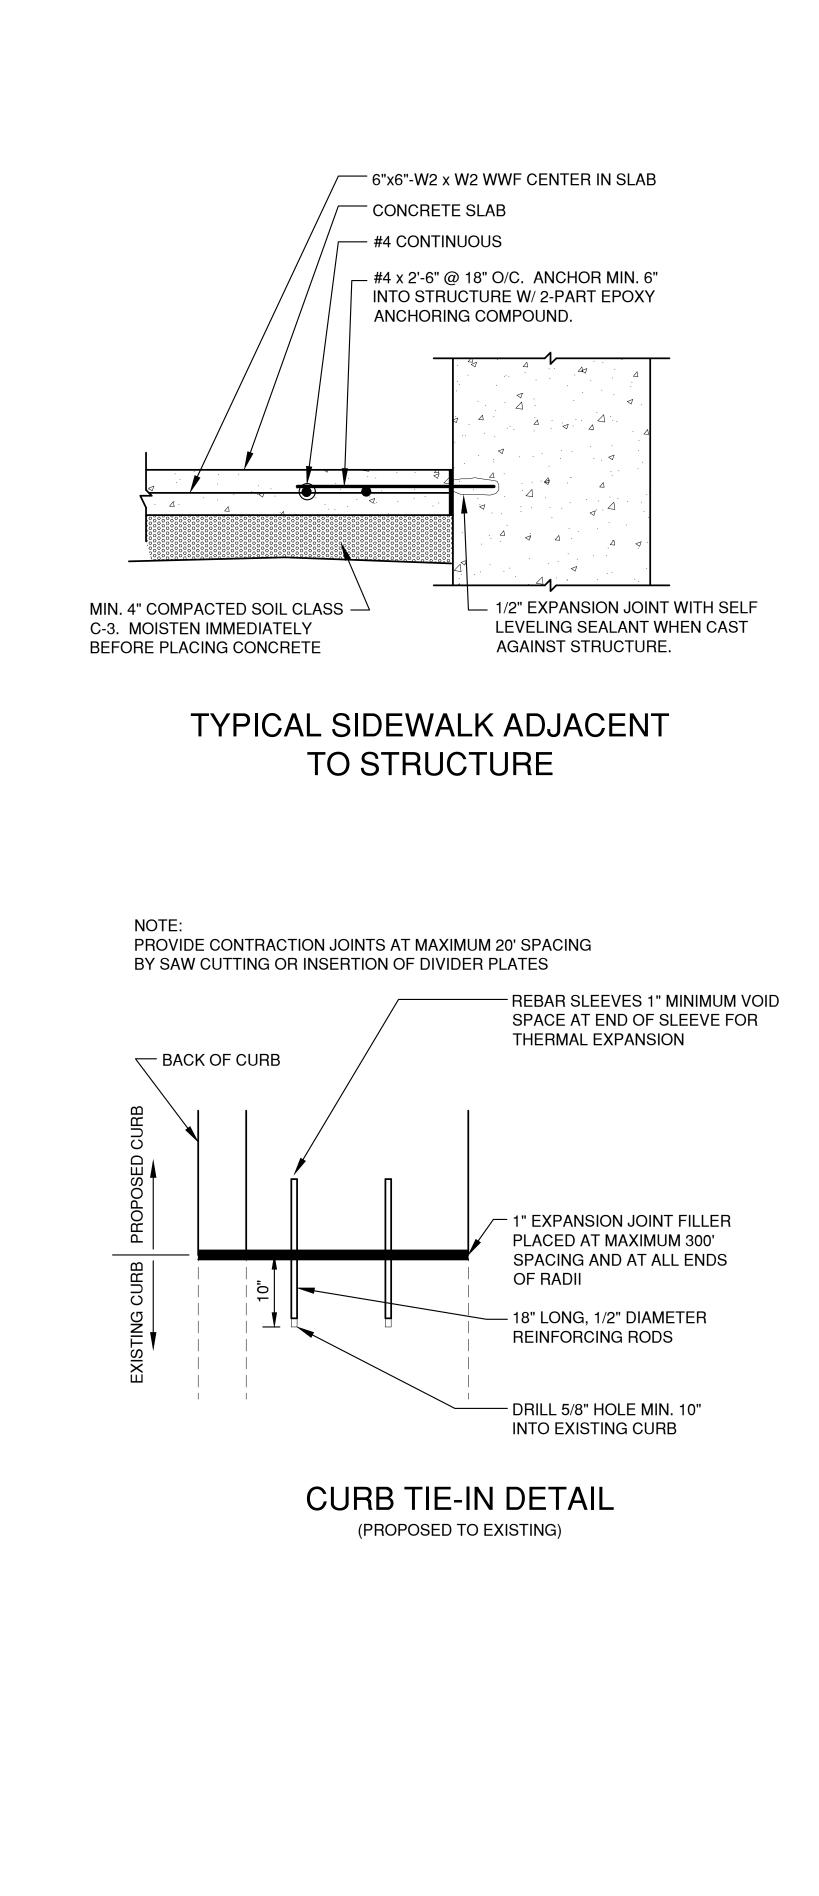


DETAILS	DATE 04/2025 FILE 1703129DET	& Associates, Inc.	SHEET NO.
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NO.	DATE	APPROV.	REVISION	NO.	DATE	APPROV.	REVISION
1	4/29/25	BDR	BID SET				
2	5/9/25	BDR	CITY SUBMITTAL				

INLET PROTECTION, TYPE A



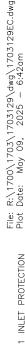

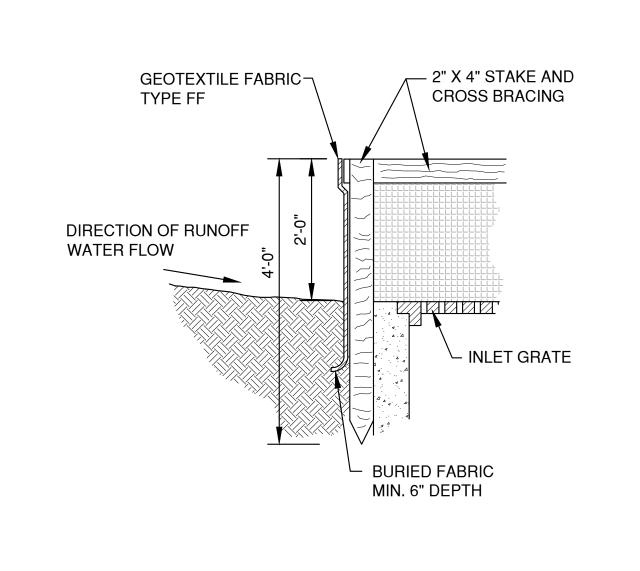TYPE FF GEOTEXTILE FABRIC (ATTACHED TO 2" X 4" STAKES AND CROSS BRACING)

2" X 4" STAKE AND

CROSS BRACING

NLET WITH OR WITHOUT GRATE

INLET PROTECTION NOTES:

INLET PROTECTION DEVICES SHALL BE IN ACCORDANCE WITH WDNR TECHNICAL STANDARD 1060, STORM DRAIN INLET PROTECTION FOR CONSTRUCTION SITES.

MANUFACTURED ALTERNATIVES APPROVED AND LISTED ON THE WDOT PRODUCT ACCEPTABILITY LIST MAY BE SUBSTITUTED.

WHEN REMOVING OR MAINTAINING INLET PROTECTION, CARE SHALL BE TAKEN SO THAT THE SEDIMENT TRAPPED ON THE GEOTEXTILE FABRIC DOES NOT FALL INTO THE INLET. ANY MATERIAL FALLING INTO THE INLET SHALL BE REMOVED IMMEDIATELY.

MAINTENANCE NOTES:

WHEN REMOVING OR MAINTAINING INLET PROTECTION, CARE SHALL BE TAKEN SO THAT THE SEDIMENT TRAPPED IN THE FABRIC DOES NOT FALL INTO THE STRUCTURE. MATERIAL THAT HAS FALLEN INTO THE INLET SHALL BE IMMEDIATELY REMOVED.

INSTALLATION NOTES: TYPE "B" AND "C"

TRIM EXCESS FABRIC IN THE FLOW LINE TO WITHIN 3" OF THE GRATE.

DEMONSTRATE A METHOD OF MAINTENANCE, USING A SEWN FLAP, HAND HOLDS OR OTHER METHOD TO PREVENT ACCUMULATED SEDIMENT FROM ENTERING THE INLET.

TYPE "D"

DO NOT INSTALL INLET PROTECTION TYPE D IN INLETS SHALLOWER THAN 30" MEASURED FROM THE BOTTOM OF THE INLET TO THE TOP OF THE GRATE.

TRIM EXCESS FABRIC IN THE FLOW LINE TO WITHIN 3" OF THE GRATE.

THE INSTALLED BAG SHALL HAVE A MINIMUM SIDE CLEARANCE, BETWEEN THE INLET WALLS AND THE BAG, MEASURED AT THE BOTTOM OF THE OVERFLOW HOLES, OF 3". WHERE NECESSARY, CINCH THE BAG, USING PLASTIC ZIP TIES, TO ACHIEVE THE 3" CLEARANCE, THE TIES SHALL BE PLACED AT THE MAXIMUM OF 4" FROM THE BOTTOM OF THE BAG.

TYPE FF GEOTEXTILE FABRIC (EXTEND FABRIC A MINIMUM OF **10" AROUND GRATE PERIMETER** FOR MAINTENANCE OR REMOVAL)

> SIDE FLAP SEE NOTE 4

LENGTH AND WIDTH DIMENSIONS SHALL BE PER PLAN

FRONT LIFTING FLAP **SEE NOTE 3**

MINIMUM DOUBLE STITCHED SEAMS ALL AROUND SIDE PIECES AND ON FLAP POCKETS.

TYPE FF GEOTEXTILE FABRIC


(FRONT, BACK, AND BOTTOM TO **BE A SINGLE PIECE OF FF FABRIC**

4" X 6" OPENINGS WITH ROUNDED CORNERS SHALL BE HEAT CUT (ONE HOLE ON EACH OF THE FOUR SIDES)

CITY OF DE PERE INLET PROTECTION TYPE	DRAWN BDR	COMMERCE DRIVE-BEDFORD PAPER EXPANSION	
	CHECKED	FOR BEST BUILT, INC.	EROSION CONTR
	 	CITY OF DE PERE	INLET PROTECTION TYPES
BROWN COUNTY, WISCONSIN	DESIGNED BDR	BROWN COUNTY, WISCONSIN	

INLET PROTECTION, TYPE B (WITHOUT CURB BOX)

(CAN BE INSTALLED IN ANY INLET WITHOUT A CURB BOX)

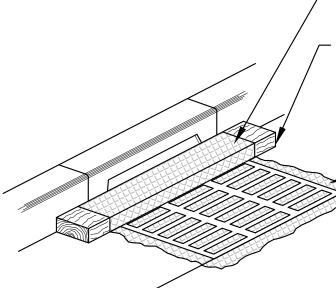

- FLAP POCKET SEE NOTE 5


- WOOD 2" X 4" EXTENDS 8" BEYOND GRATE WIDTH ON BOTH SIDES, LENGTH VARIES. SECURE TO GRATE WITH PLASTIC TIES.

> TYPE FF GEOTEXTILE FABRIC (EXTEND FABRIC A MINIMUM OF **10" AROUND GRATE PERIMETER** FOR MAINTENANCE OR REMOVAL)

INLET PROTECTION, TYPE C (WITH CURB BOX)


NOTES:

- TAPER BOTTOM OF BAG TO MAINTAIN THREE INCHES OF CLEARANCE 1. BETWEEN THE BAG AND THE STRUCTURE, MEASURED FROM THE BOTTOM OF THE OVERFLOW OPENINGS TO THE STRUCTURE WALL.
- GEOTEXTILE FABRIC TYPE FF FOR FLAPS, TOP AND BOTTOM OF THE 2. OUTSIDE OF FILTER BAG. FRONT, BACK AND BOTTOM OF FILTER BAG BEING ONE PIECE.
- FRONT LIFTING FLAP IS TO BE USED WHEN REMOVING AND MAINTAINING 3. FILTER BAG.
- 4. SIDE FLAPS SHALL BE A MAXIMUM OF TWO INCHES LONG. FOLD THE FABRIC OVER AND REINFORCE WITH MULTIPLE STITCHES.
- FLAP POCKETS SHALL BE LARGE ENOUGH TO ACCEPT WOOD 2" X 4". THE 5. REBAR, STEEL PIPE, OR WOOD SHALL BE INSTALLED IN THE REAR FLAP AND SHALL NOT BLOCK THE TOP HALF OF THE CURB FACE OPENING.

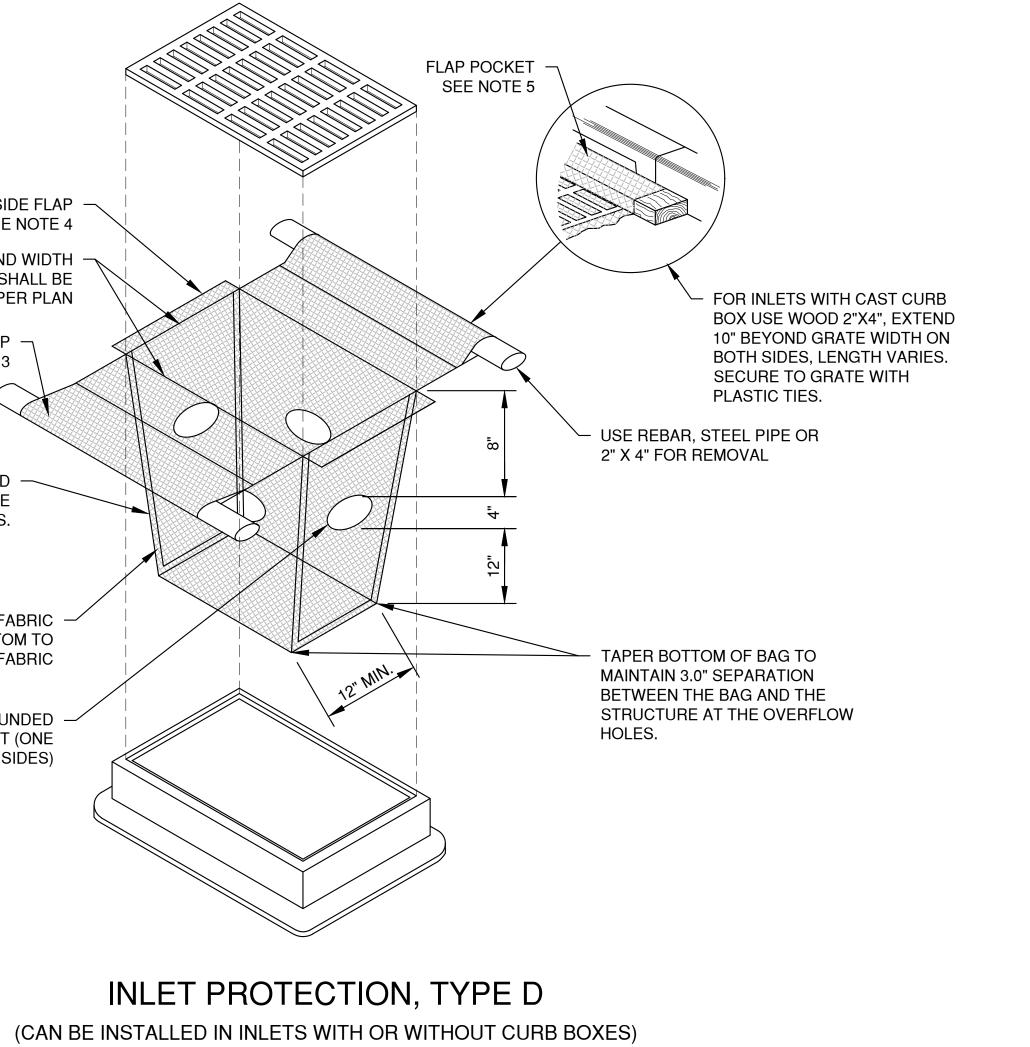

TROL S A, B, C AND D	DATE 04/2025 FILE 1703129EC	& Associates, Inc.	SHEET NO.
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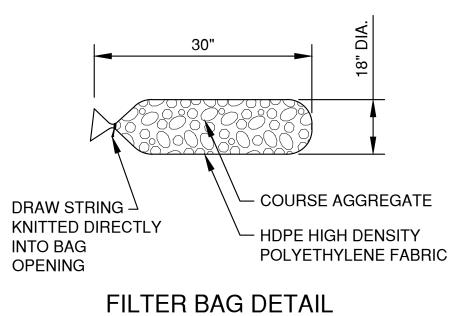
- 1. BETWEEN THE BAG AND THE STRUCTURE, MEASURED FROM THE BOTTOM OF THE OVERFLOW OPENINGS TO THE STRUCTURE WALL.
- 2. GEOTEXTILE FABRIC TYPE HR FOR BOTTOM HALF OF FILTER BAG. FRONT, BACK AND BOTTOM OF FILTER BAG BEING ONE PIECE.
- 3. FRONT LIFTING FLAP IS TO BE USED WHEN REMOVING AND MAINTAINING FILTER BAG.
- SIDE FLAPS SHALL BE A MAXIMUM OF TWO INCHES LONG. FOLD THE FABRIC 4. OVER AND REINFORCE WITH MULTIPLE STITCHES.
- FLAP POCKETS SHALL BE LARGE ENOUGH TO ACCEPT WOOD 2" X 4". THE 5. REBAR, STEEL PIPE, OR WOOD SHALL BE INSTALLED IN THE REAR FLAP AND SHALL NOT BLOCK THE TOP HALF OF THE CURB FACE OPENING.

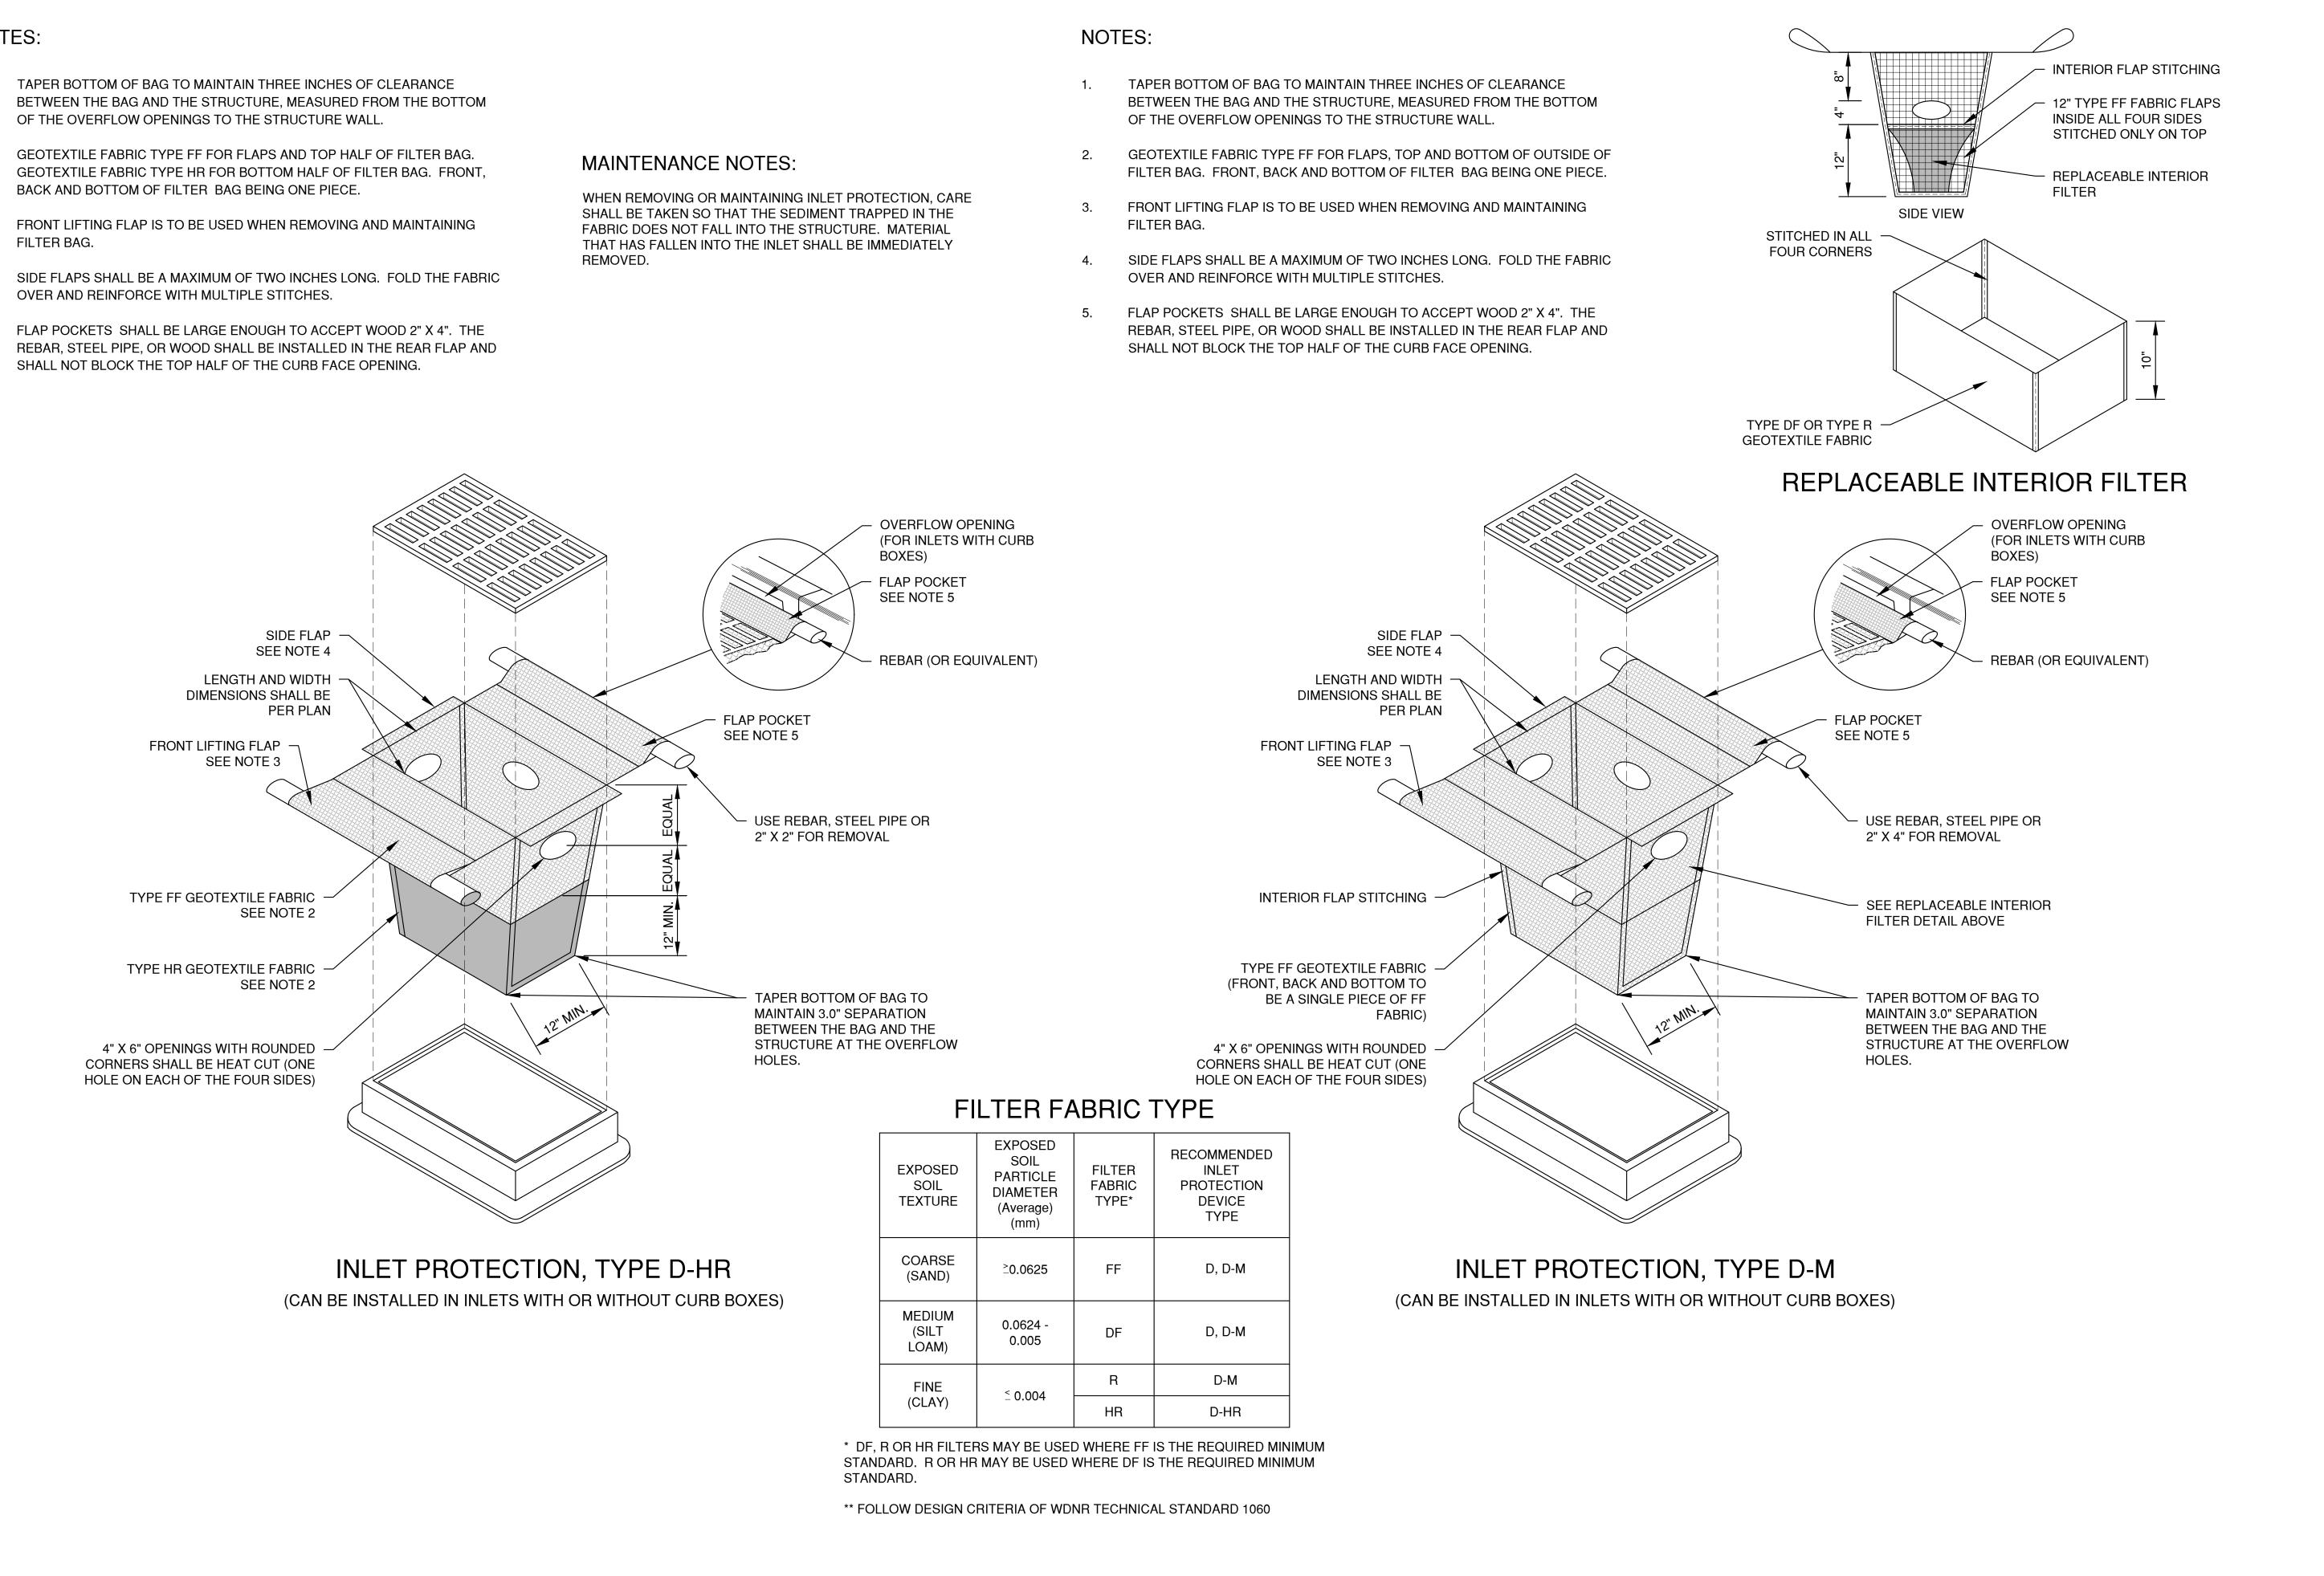

NO.	DATE	APPROV.	REVISION	NO.	DATE	APPROV.	REVISION
1	4/29/25	BDR	BID SET				
2	5/9/25	BDR	CITY SUBMITTAL				

DRAWN ^{BDR} CHECKED	COMMERCE DRIVE-BEDFORD PAPER EXPANSION FOR BEST BUILT, INC.	EROSION CONTROL INLET PROTECTION	DATE 04/2025 FILE	Robert E. Lee	SHEET NO.
	CITY OF DE PERE		1703129EC	A Associates, Inc.	
DESIGNED BDR	BROWN COUNTY, WISCONSIN	TYPE D-HR AND TYPE D-M	JOB NO. 1703129	1250 Centennial Centre Blvd Hobart, WI 920-662-9641 releeinc.com	

	-	-			-	-	
NO.	DATE	APPROV.	REVISION	NO.	DATE	APPROV.	REVISION
1	4/29/25	BDR	BID SET				
2	5/9/25	BDR	CITY SUBMITTAL				



- 1. 18" X 30" ROCK FILLED FILTER BAG SHALL BE COMPRISED OF THE FOLLOWING:
 - HDPE HIGH DENSITY POLYETHYLENE HDPE HIGH DENSITY POLYETHYLENE DRAW STRING KNITTED DIRECTLY INTO BAG OPENING.
 - 80% FABRIC CLOSURE WITH APPARENT OPENING SIZE NO LARGER THAN 1/8 " X 1/8" ROLLED SEAM USING A MINIMUM OF 480 DENIER POLYESTER
 - SEWING YARN FOR STRENGTH AND DURABILITY.
- 2. USE WELL GRADED COURSE AGGREGATE CONFORMING TO THE FOLLOWING GRADATION REQUIREMENTS

	SIZE NO.
SIEVE SIZE	AASHTO No. 67 (1)
2 INCH (50 mm)	-
1 1/2 INCH (37.5mm)	-
1 INCH (25.0 mm)	100
3/4 INCH (19.0mm)	90-100
3/8 INCH (9.5mm)	20-55
No. 4 (4.75mm)	0-10
No. 8 (2.36mm)	0-5


(1) SIZE No. ACCORDING TO AASHTO M 43

FLOW

DITCH CHECK GENERAL NOTES:


- 1. DITCH CHECKS SHALL BE CONSTRUCTED IN ACCORDANCE WITH WDNR TECHNICAL STANDARD 1062.
- 2. AT A MINIMUM, INSTALL ONE DITCH CHECK FOR EVERY 2 FEET OF VERTICAL DROP.
- 3. DITCH CHECKS SHALL BE PLACED SUCH THAT THE RESULTING PONDING WILL NOT CAUSE AN INCONVENIENCE OR DAMAGE TO ADJACENT AREAS.

DRAWN BDR	COMMERCE DRIVE-BEDFORD PAPER EXPANSION	
CHECKED	FOR BEST BUILT, INC.	EROSION CONTR
	CITY OF DE PERE	DITCH CHECK DET
DESIGNED BDR	BROWN COUNTY, WISCONSIN	

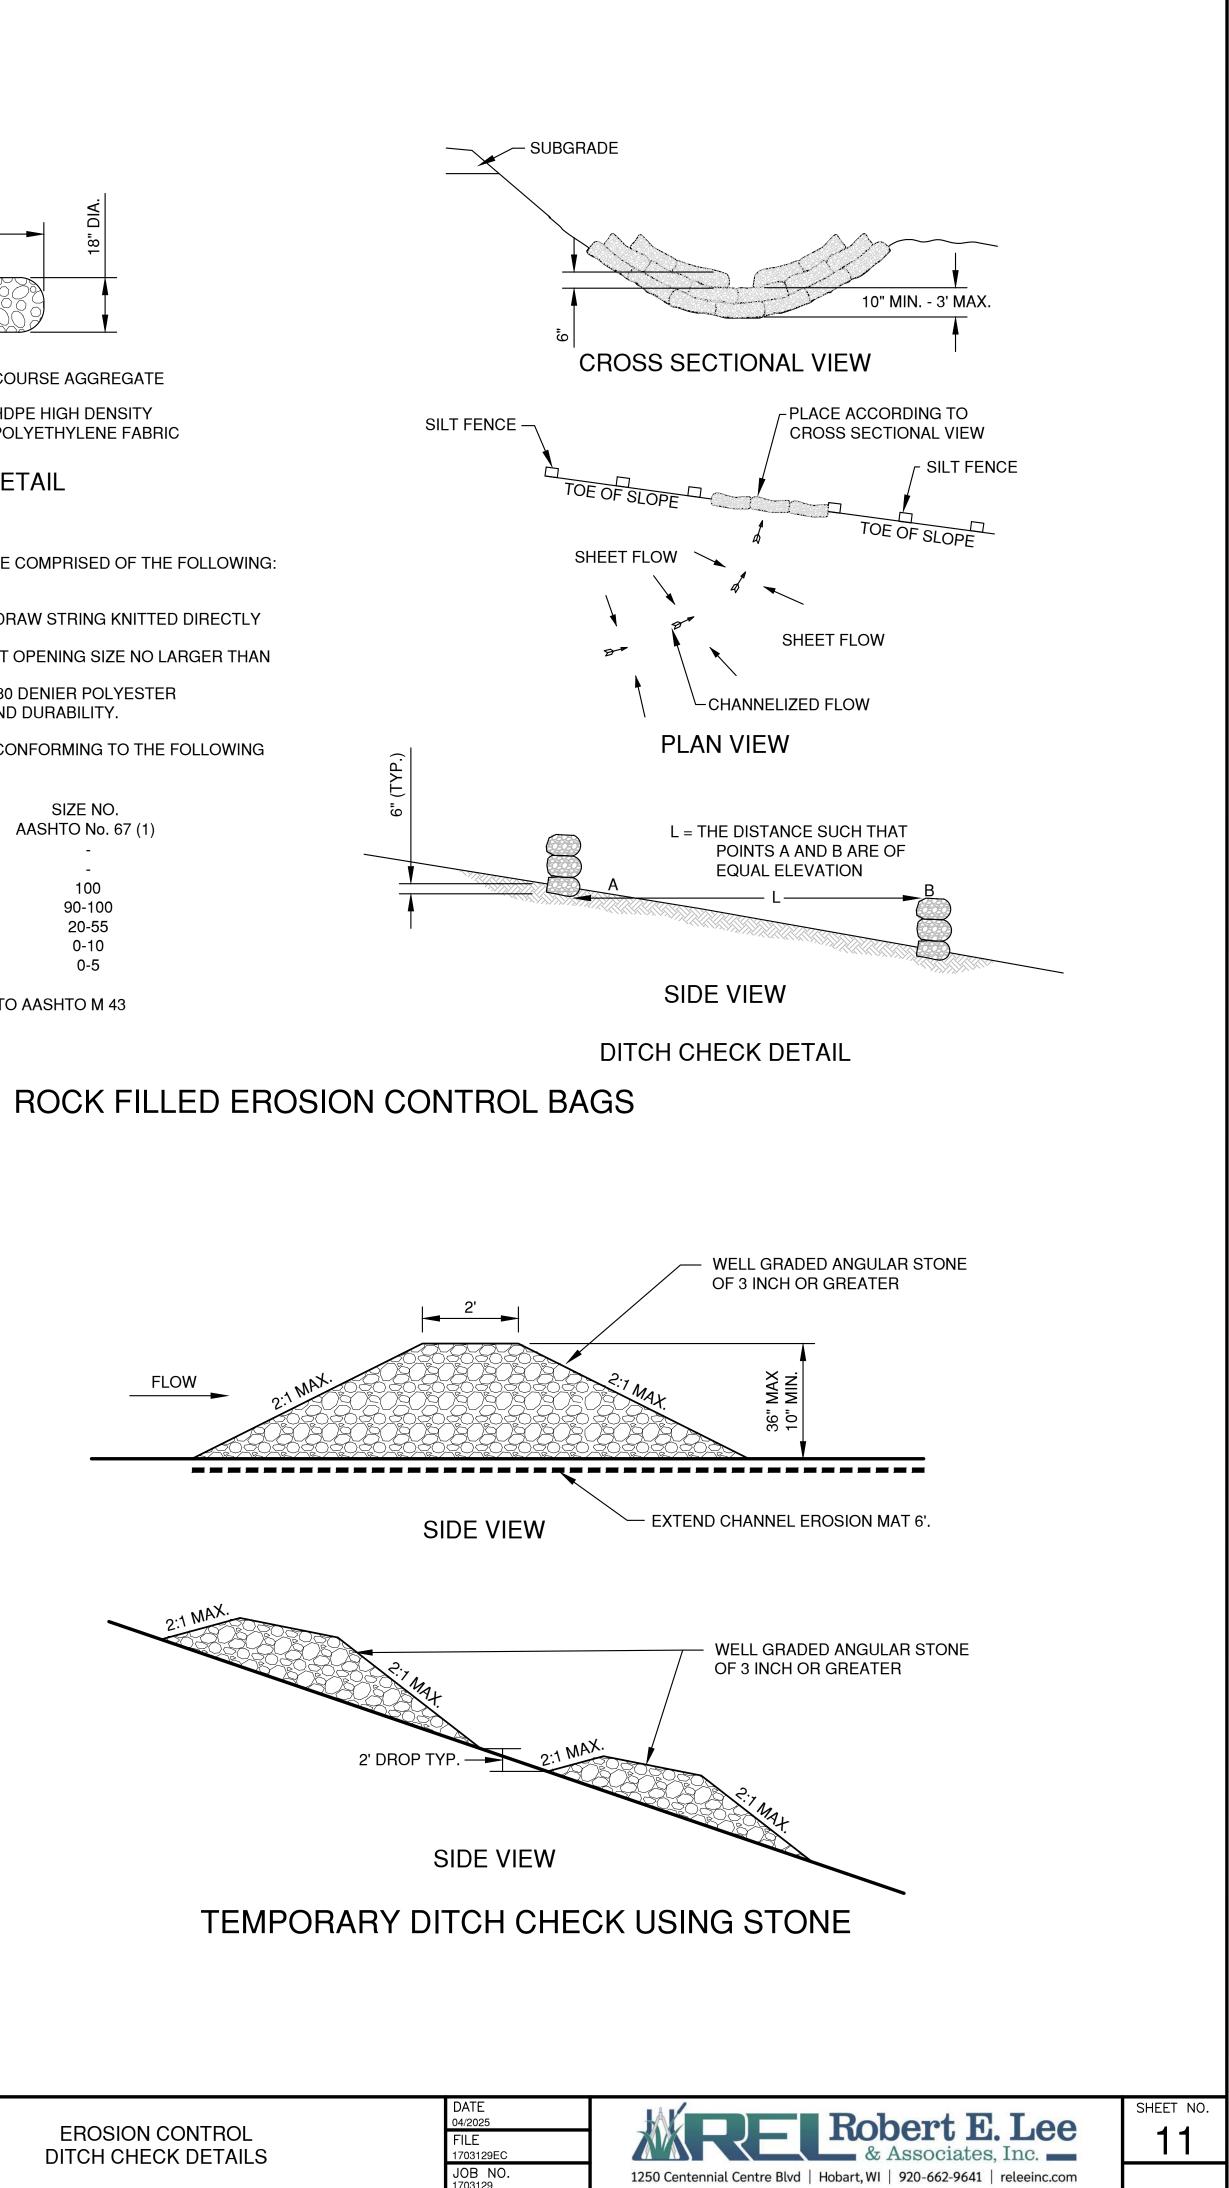


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File:	Plot
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NO.	DATE	APPROV.	REVISION	NO.	DATE	APPROV.	REVISION
1	4/29/25	BDR	BID SET				
2	5/9/25	BDR	CITY SUBMITTAL				

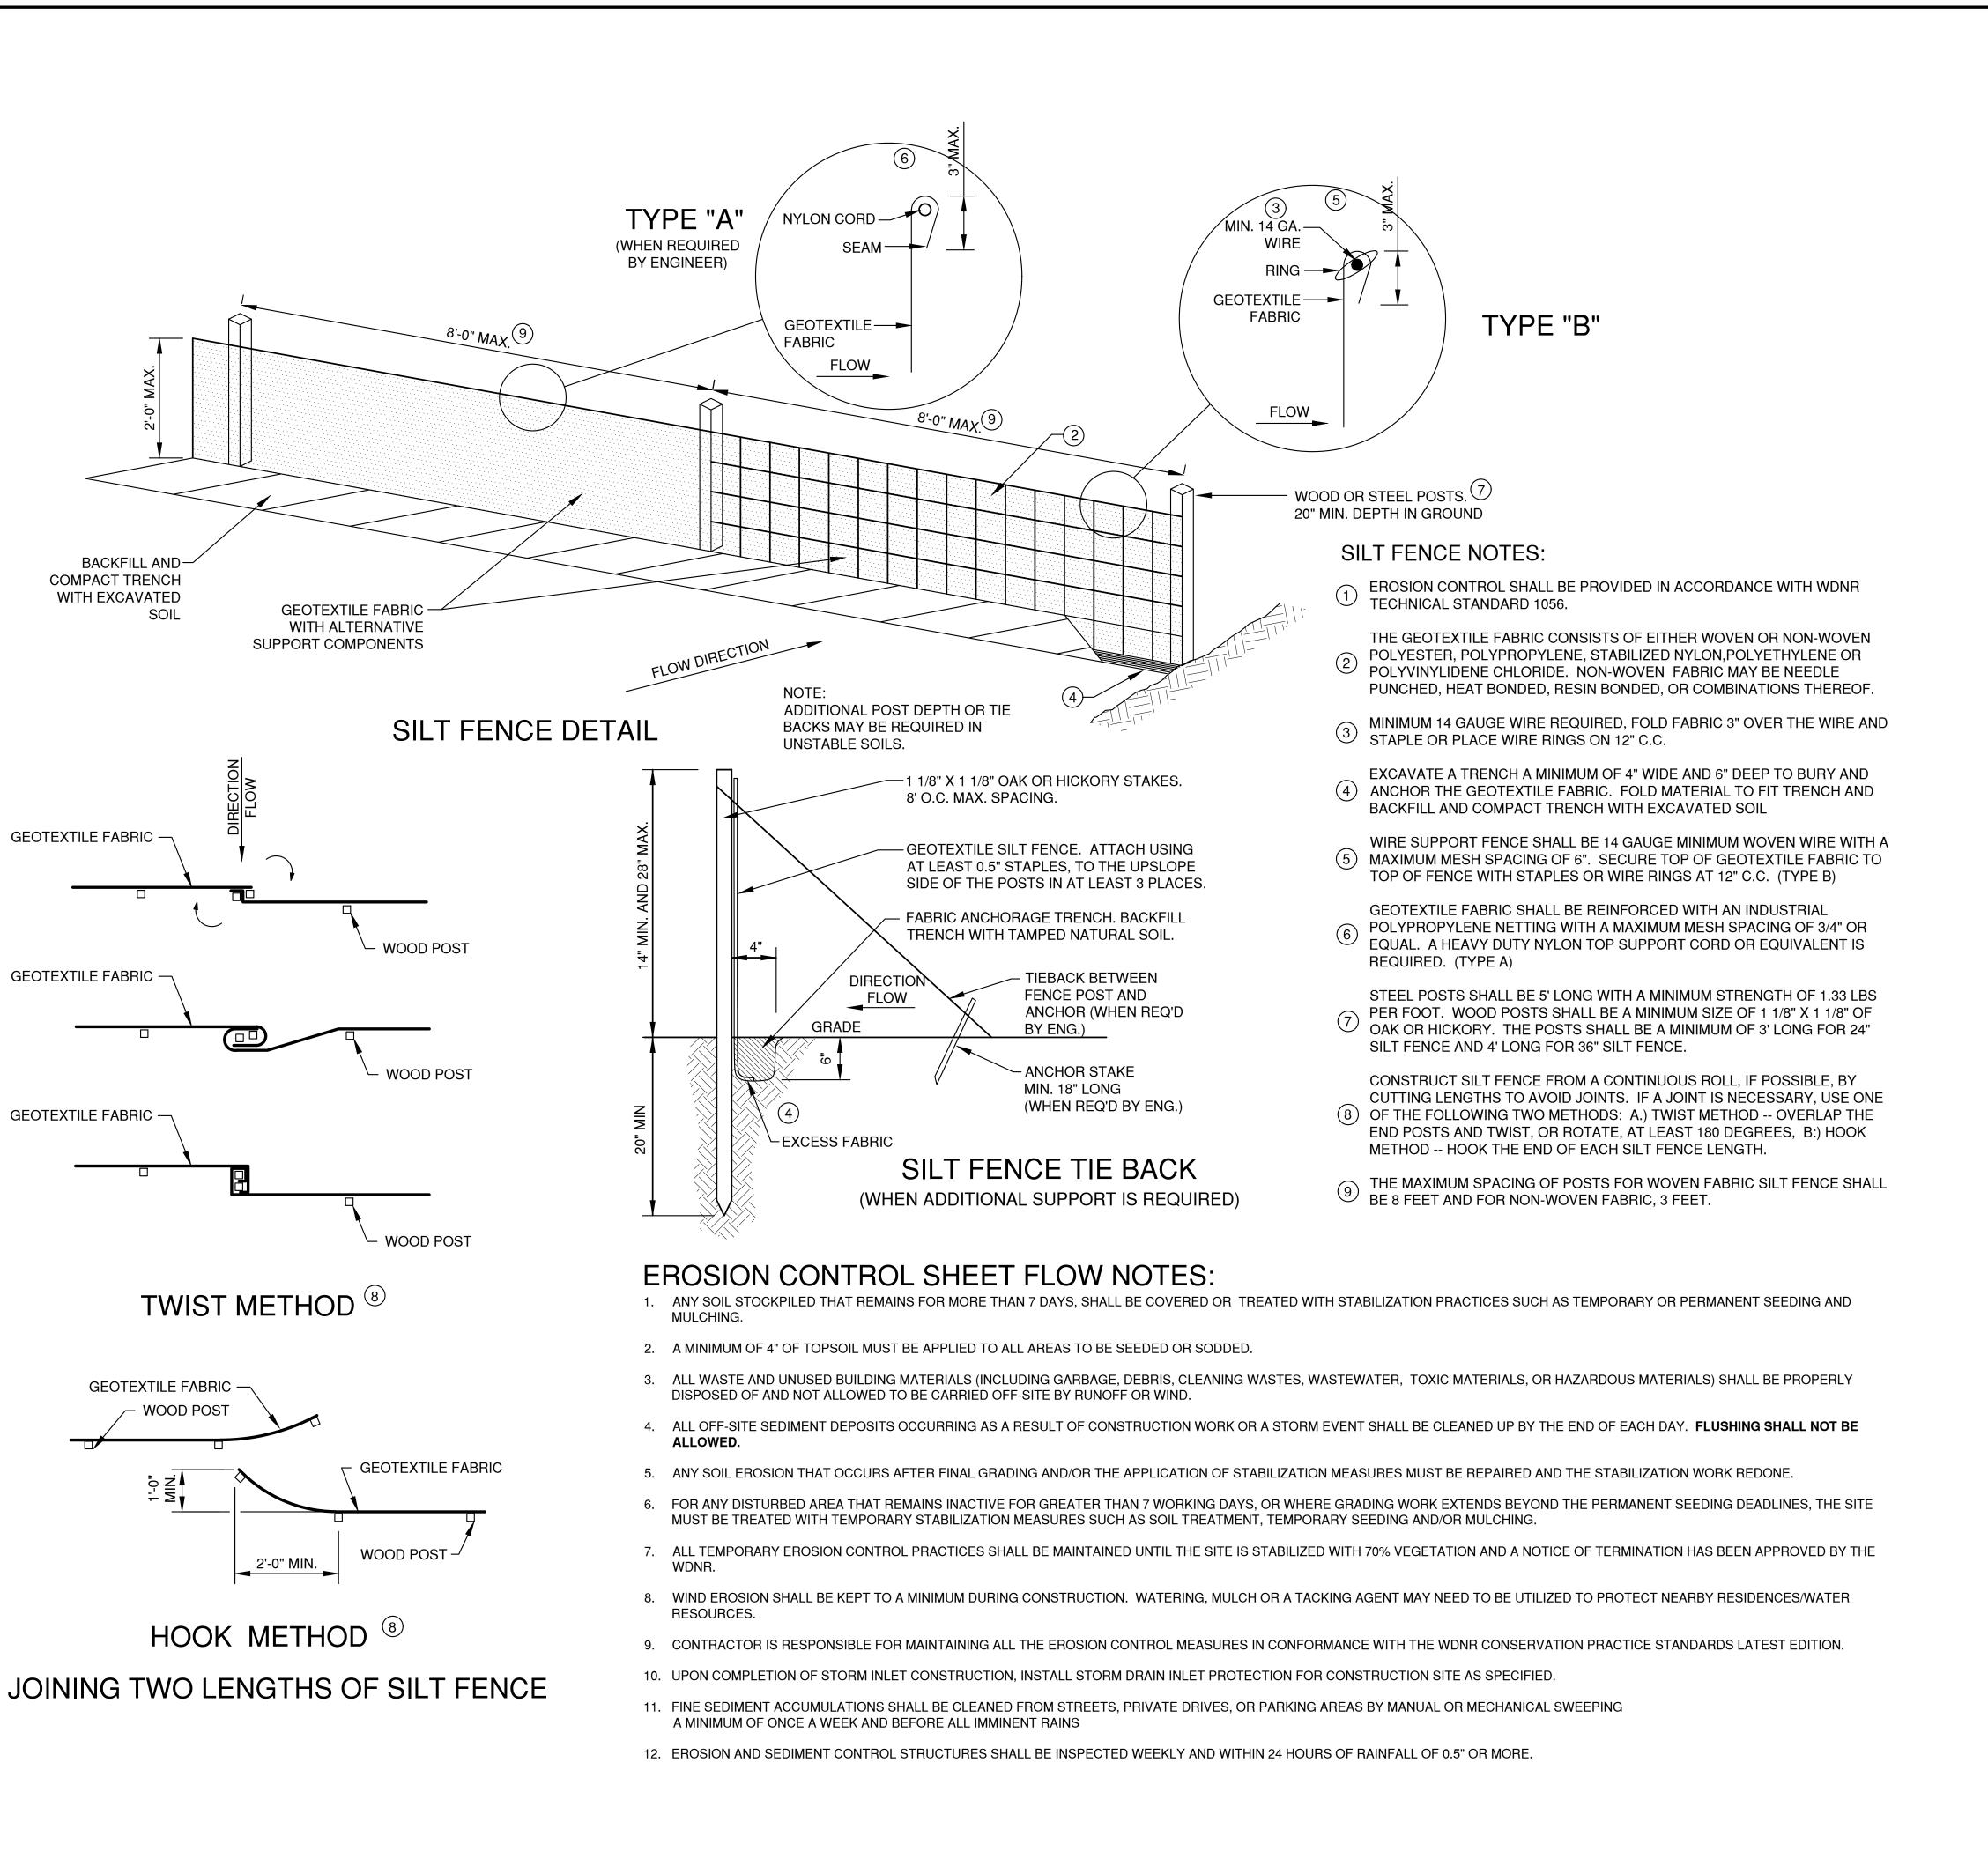

DRAWN BDR	COMMERCE DRIVE-BEDFORD PAPER EXPANSION		DATE 04/2025	Bebort F Loo	SHEET NO.
CHECKED	FOR BEST BUILT, INC.	EROSION CONTROL	FILE	Kobert E. Lee	1 12
	CITY OF DE PERE	SHEET FLOW DETAILS	1703129EC	& Associates, Inc.	
DESIGNED BDR	BROWN COUNTY, WISCONSIN		JOB NO. 1703129	1250 Centennial Centre Blvd Hobart, WI 920-662-9641 releeinc.com	

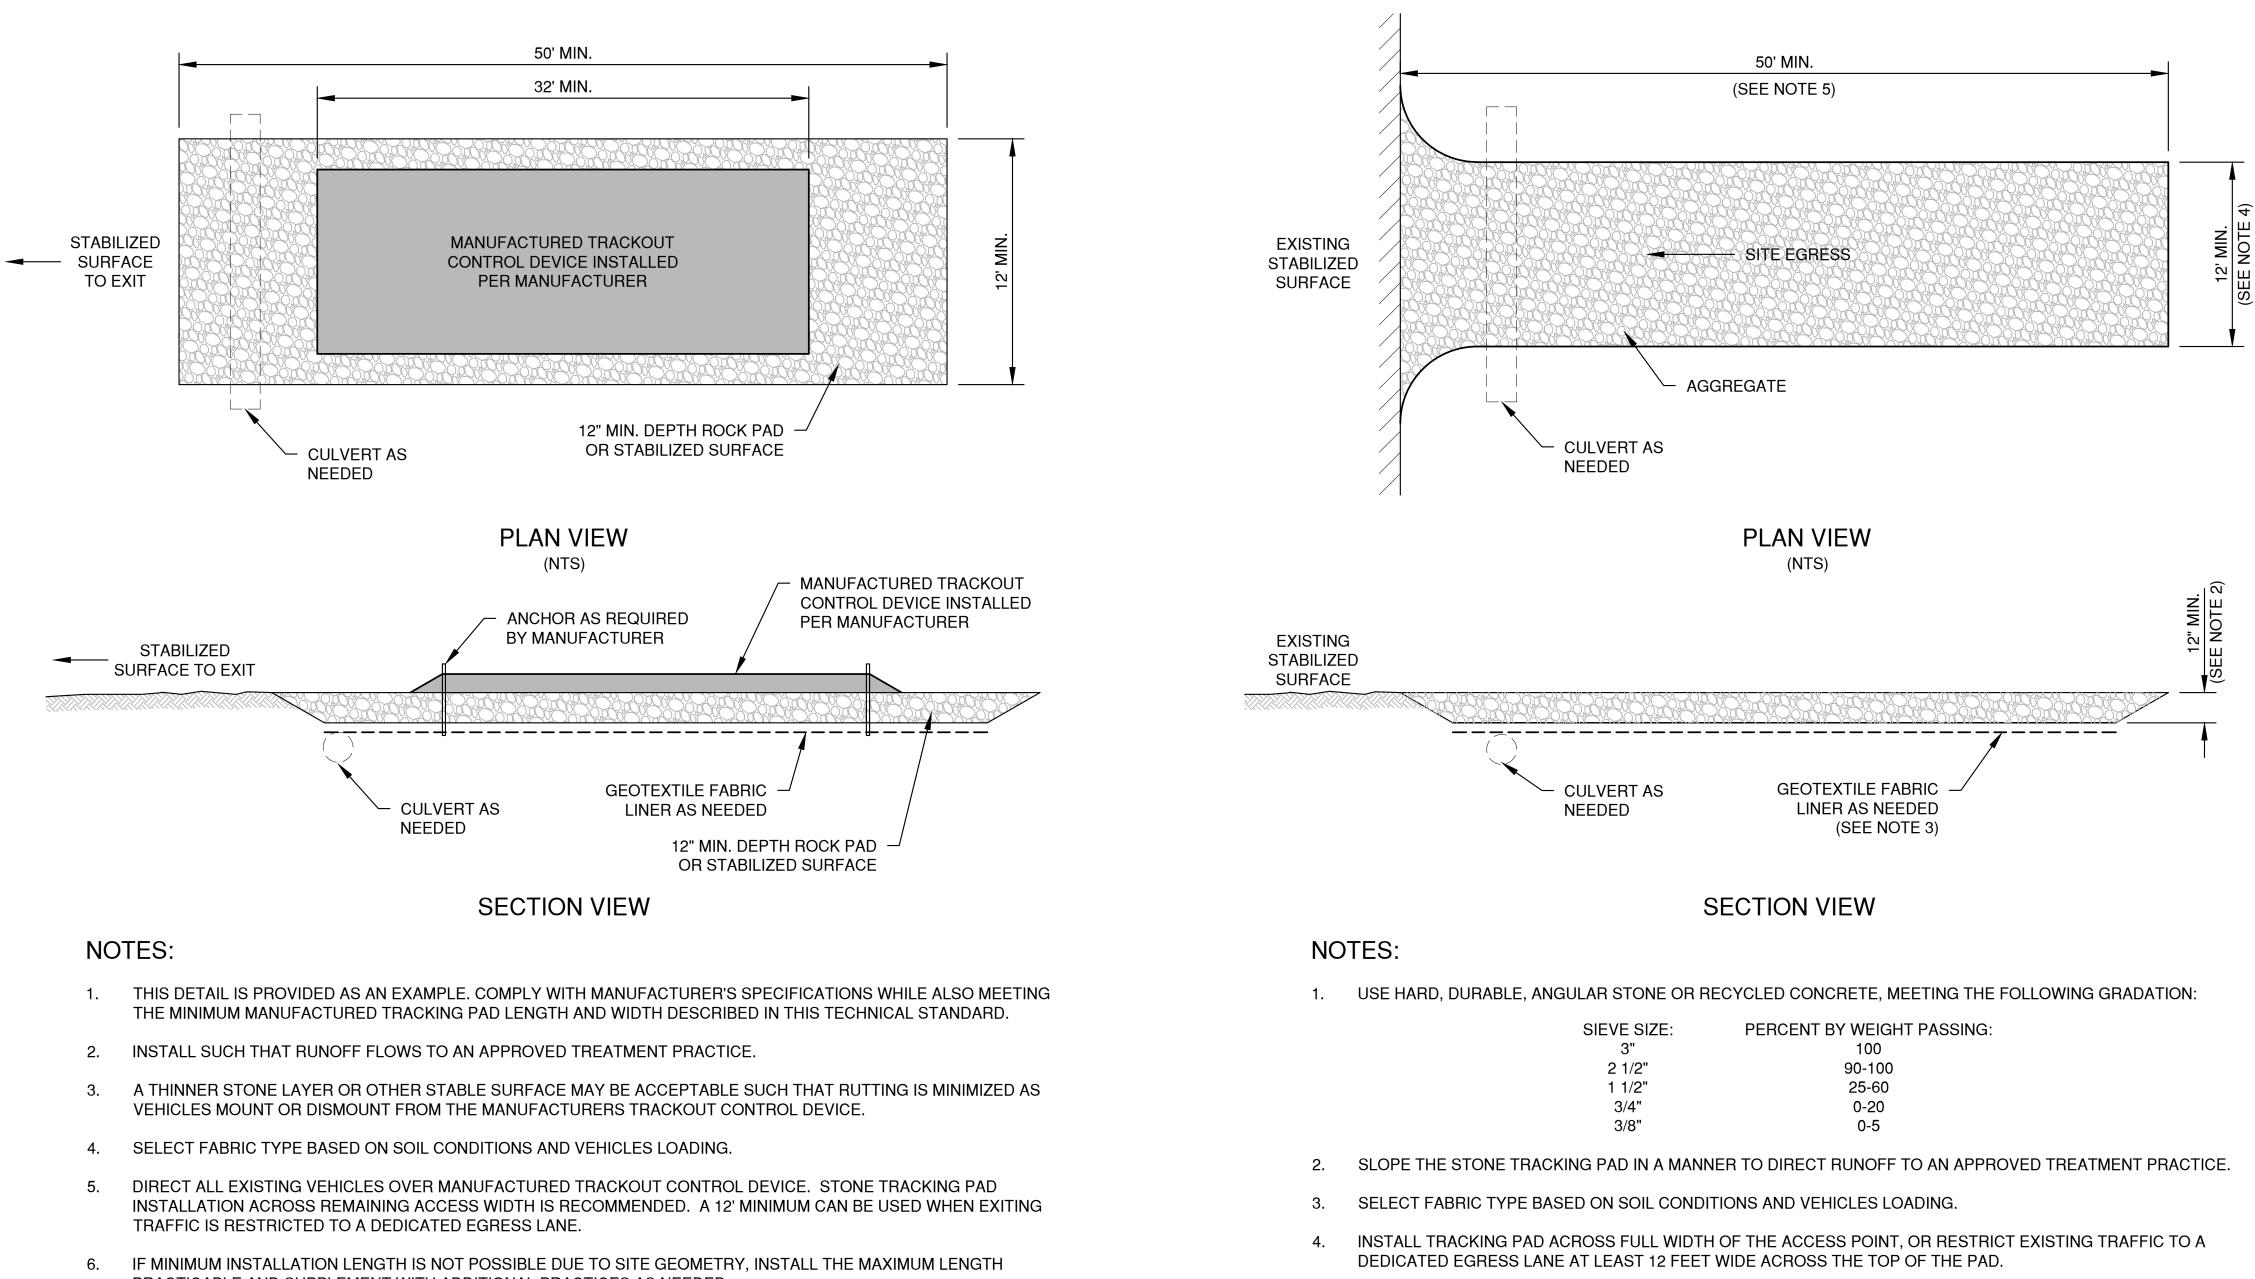

- PRACTICABLE AND SUPPLEMENT WITH ADDITIONAL PRACTICES AS NEEDED.
- WITH OTHER TREATMENT PRACTICES.

MANUFACTURED TRACKOUT CONTROL DETAIL

NO.	DATE	APPROV.	REVISION	NO.	DATE	APPROV.	REVISION	DRAWN BDR	COMMERCE DRIVE-BEDFORD PAPER EXPANSION	
1	4/29/25	BDR	BID SET					CHECKED	FOR BEST BUILT, INC.	EROSION CONTRO
2	5/9/25	BDR	CITY SUBMITTAL					DESIGNED	CITY OF DE PERE	TRACKOUT CONTROL PRA
								BDR	BROWN COUNTY, WISCONSIN	


* TRACKOUT CONTROL TO BE PROVIDED PER DETAILS BELOW AND IN ACCORDANCE WITH WDNR TECHNICAL STANDARD 1057

7. ACCOMMODATE EXITING VEHICLES IN EXCESS OF MANUFACTURED TRACKOUT CONTROL DEVICE WEIGHT CAPACITY

STONE TRACKING PAD DETAIL


5. IF A 50' PAD LENGTH IS NOT POSSIBLE DUE TO SITE GEOMETRY, INSTALL THE MAXIMUM LENGTH PRACTICABLE AND SUPPLEMENT WITH ADDITIONAL PRACTICES AS NEEDED.


ROL PRACTICES	DATE 04/2025 FILE 1703129EC JOB NO. 1703129	1250 Centennial Centre Blvd Hobart, WI 920-662-9641 releeinc.com	SHEET NO
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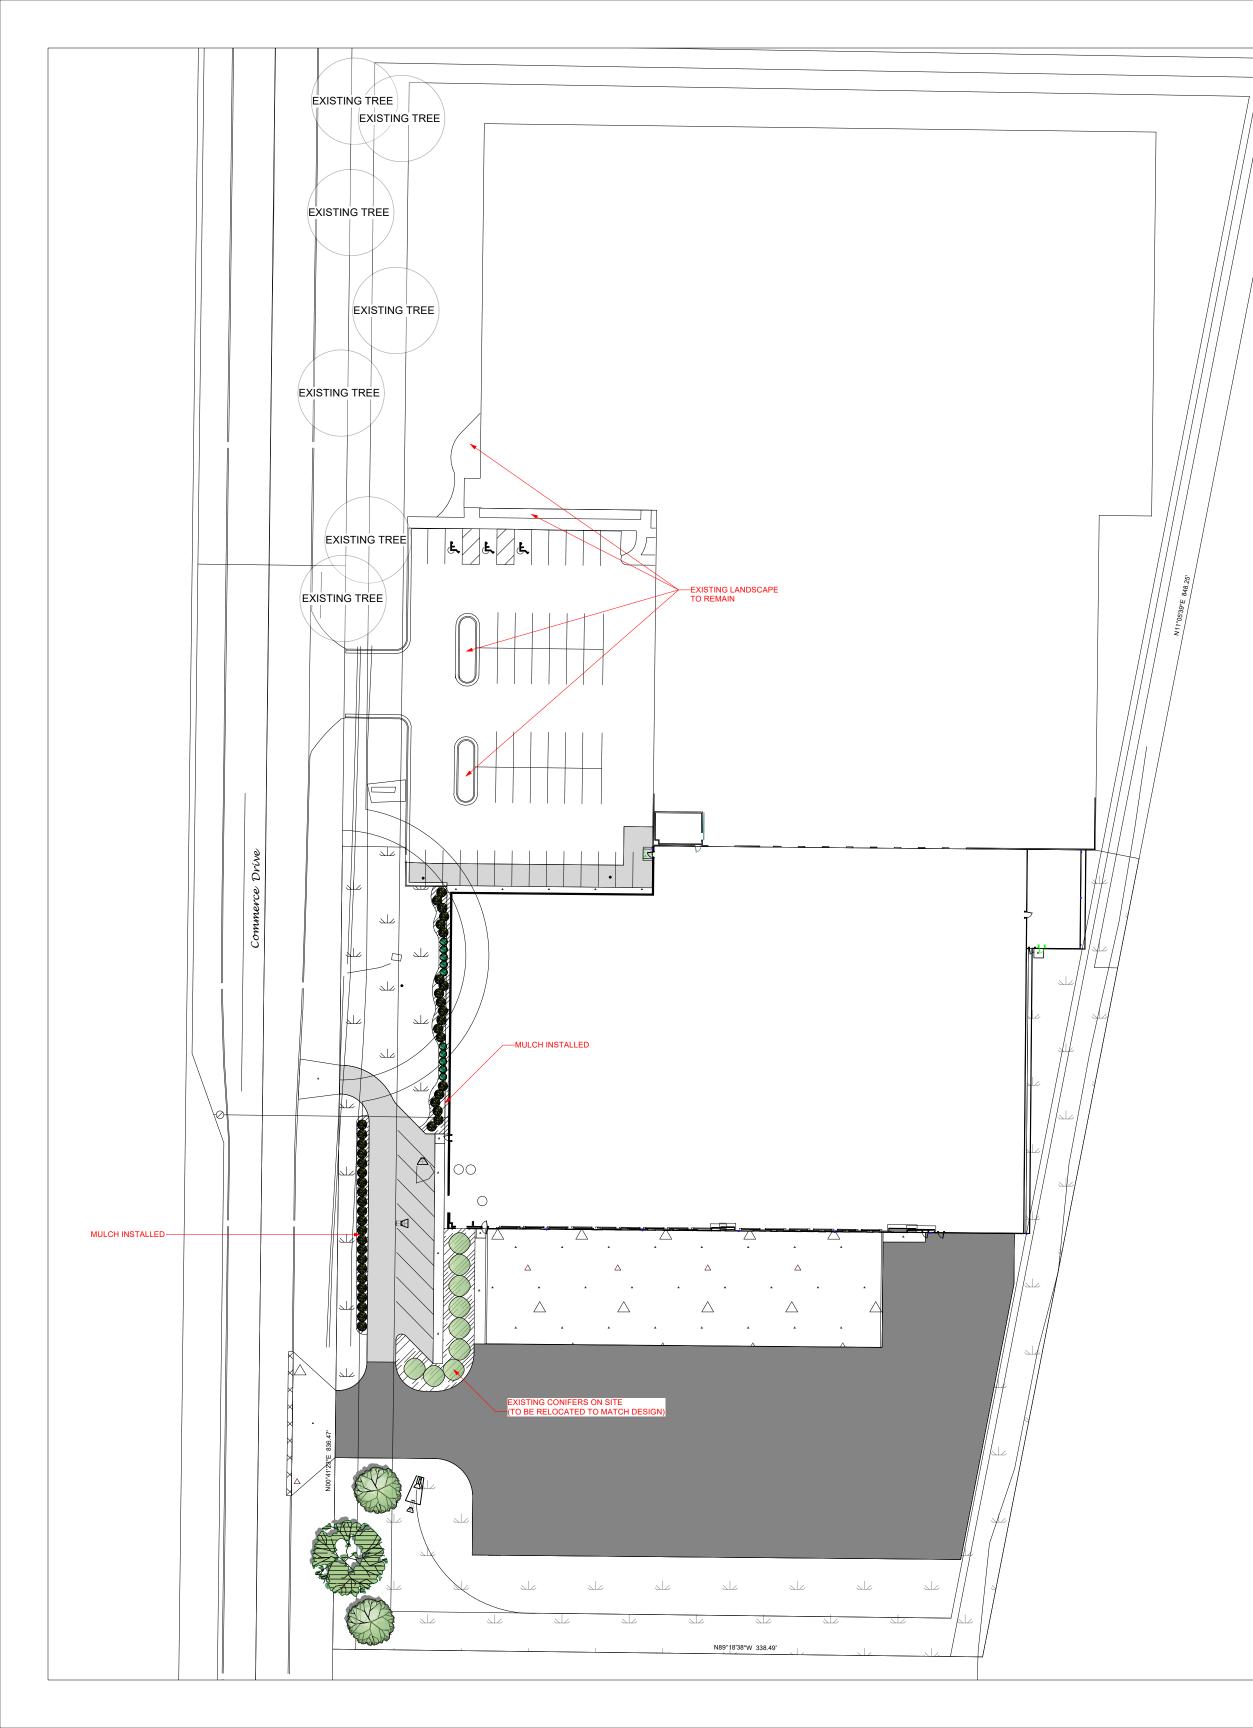
EXTEND BLANKET A MINIMUM OF 3'-0" OVER CREST OF SLOPE, SEE DETAIL 4, THIS SHEET. TRENCHING NEEDED IF A MINIMUM OF 3'-0" IS NOT AVAILABLE AT THE CREST OF SLOPE OR IF OVERLAND FLOW IS ANTICIPATED FROM UPLAND AREAS, SEE DETAILS 5 & 6, THIS SHEET	
	METHOD "A" (NO TRENCH)
$\begin{array}{cccccccccccccccccccccccccccccccccccc$	DO NOT NEED TO TRENCH BLANKET IN IF IT CAN BE EXTENDED A MINIMUM OF 3'-0" OVER THE CREST OF THE SLOPE.
$\begin{array}{ c c c c c c c c c c c c c c c c c c c$	- TRENC 10" WID
L L L L L L L L L L L L L L L L L L L	SOIL PILE FROM TRENCH
	SLOPE TO PROTECT
FOR END ROLL OVERLAP, SEE DETAIL 2, THIS SHEET	STEP 1 2 F ST EA
y y y y	
BLANKET TO EXTEND A MINIMUM OF 3'-0" BEYOND TOE OF SLOPE. FOR BOTTOM OF SLOPE	SLOPE TRENCHING METHOD "B" (5)
TERMINATION, SEE DETAIL 3, THIS SHEET	
	INIETHOD B Soll Pile TRENCH APPROX. Soll Pile 10" WIDE x 8" DEEP 18"
	SOIL PILE TRENCH APPROX
DETAIL 3, THIS SHEET	TRENCH APPROX. 10" WIDE x 8" DEEP 10" SLOPE TO
DETAIL 3, THIS SHEET	SOIL PILE FROM TRENCH 10" WIDE x 8" DEEP SLOPE TO PROTECT STEP 1 STEP 1 STE
DETAIL 3, THIS SHEET	SUPPE FROM TRENCH I" WIDE x 8" DEEP I" WIDE x 8" DEEP I I I I I I I I I I I I I I I
DETAIL 3, THIS SHEET	SOL PLE FROM TRENCH 10" WIDE x 8" DEEP USOPE TO PROTECT SLOPE TO PROTECT STEP1

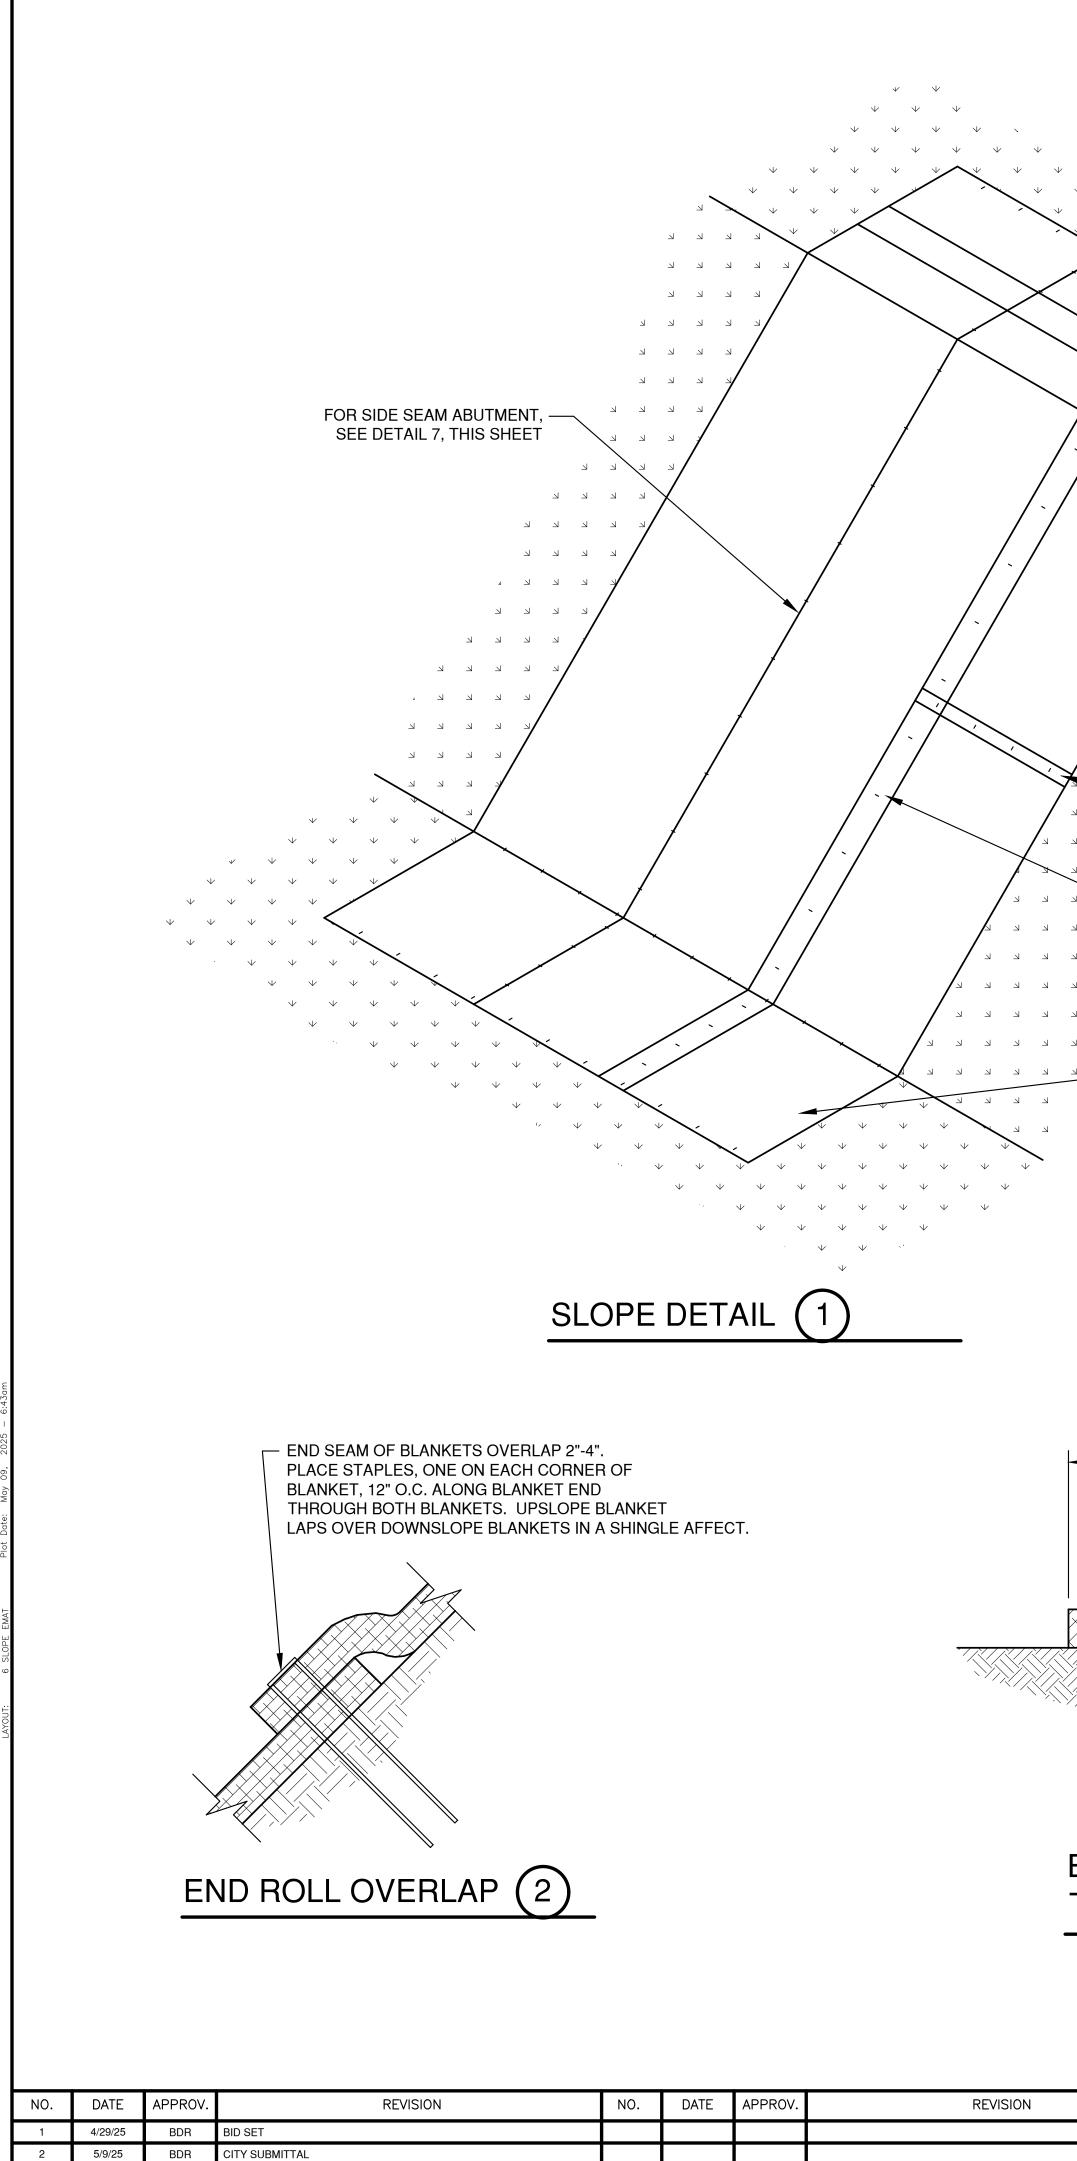DRAWN BDR	COMMERCE DRIVE-BEDFORD PAPER EXPANSION	EROSION CONTR
CHECKED	FOR BEST BUILT, INC.	EROSION MAT
 DESIGNED	CITY OF DE PERE	SLOPE APPLICATION E
BDR	BROWN COUNTY, WISCONSIN	SECTE AT LIGATION E



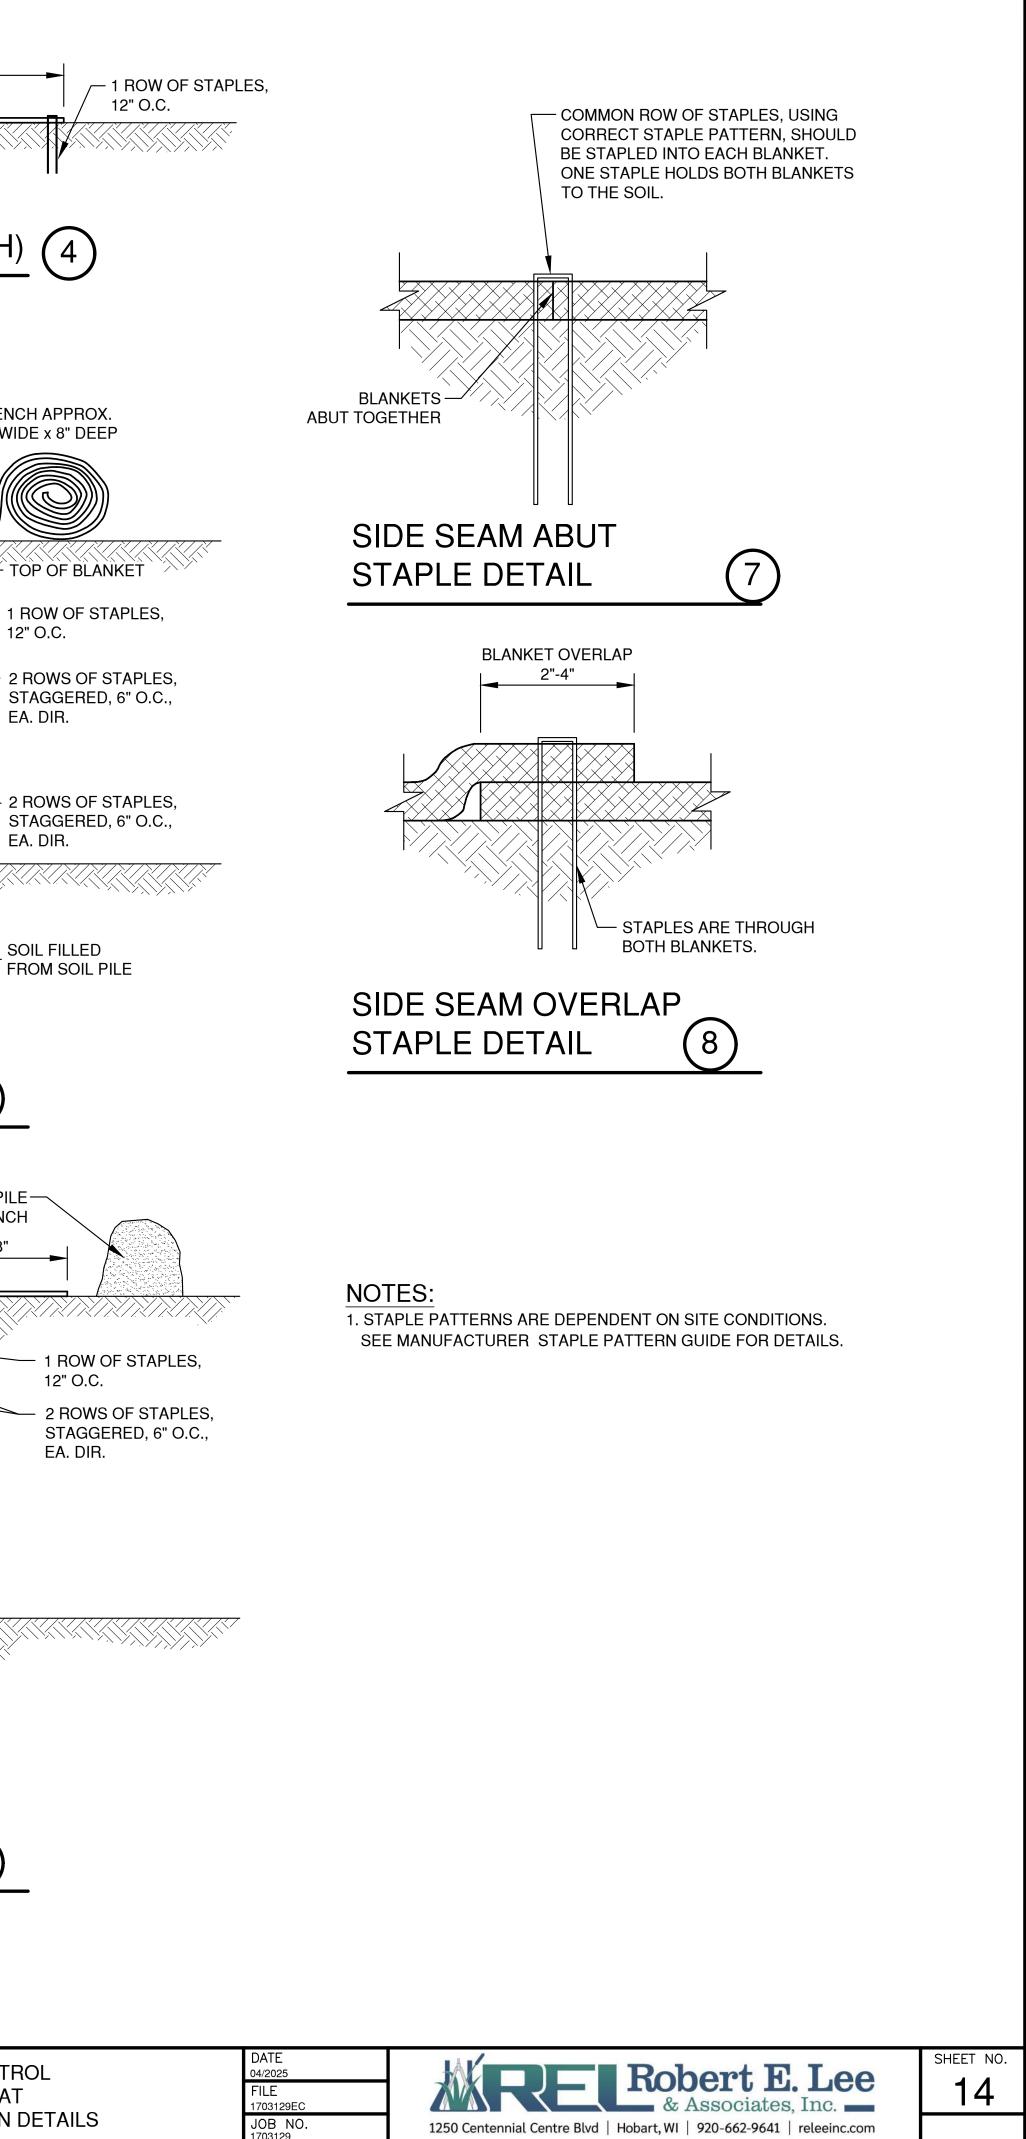

DRAWN BDR CHECKED DESIGNED	COMMERCE DRIVE-BEDFORD PAPER EXPANSION FOR BEST BUILT, INC. CITY OF DE PERE BROWN COUNTY, WISCONSIN	EROSION CONTE EROSION MAT CHANNEL APPLICATION
BDR		

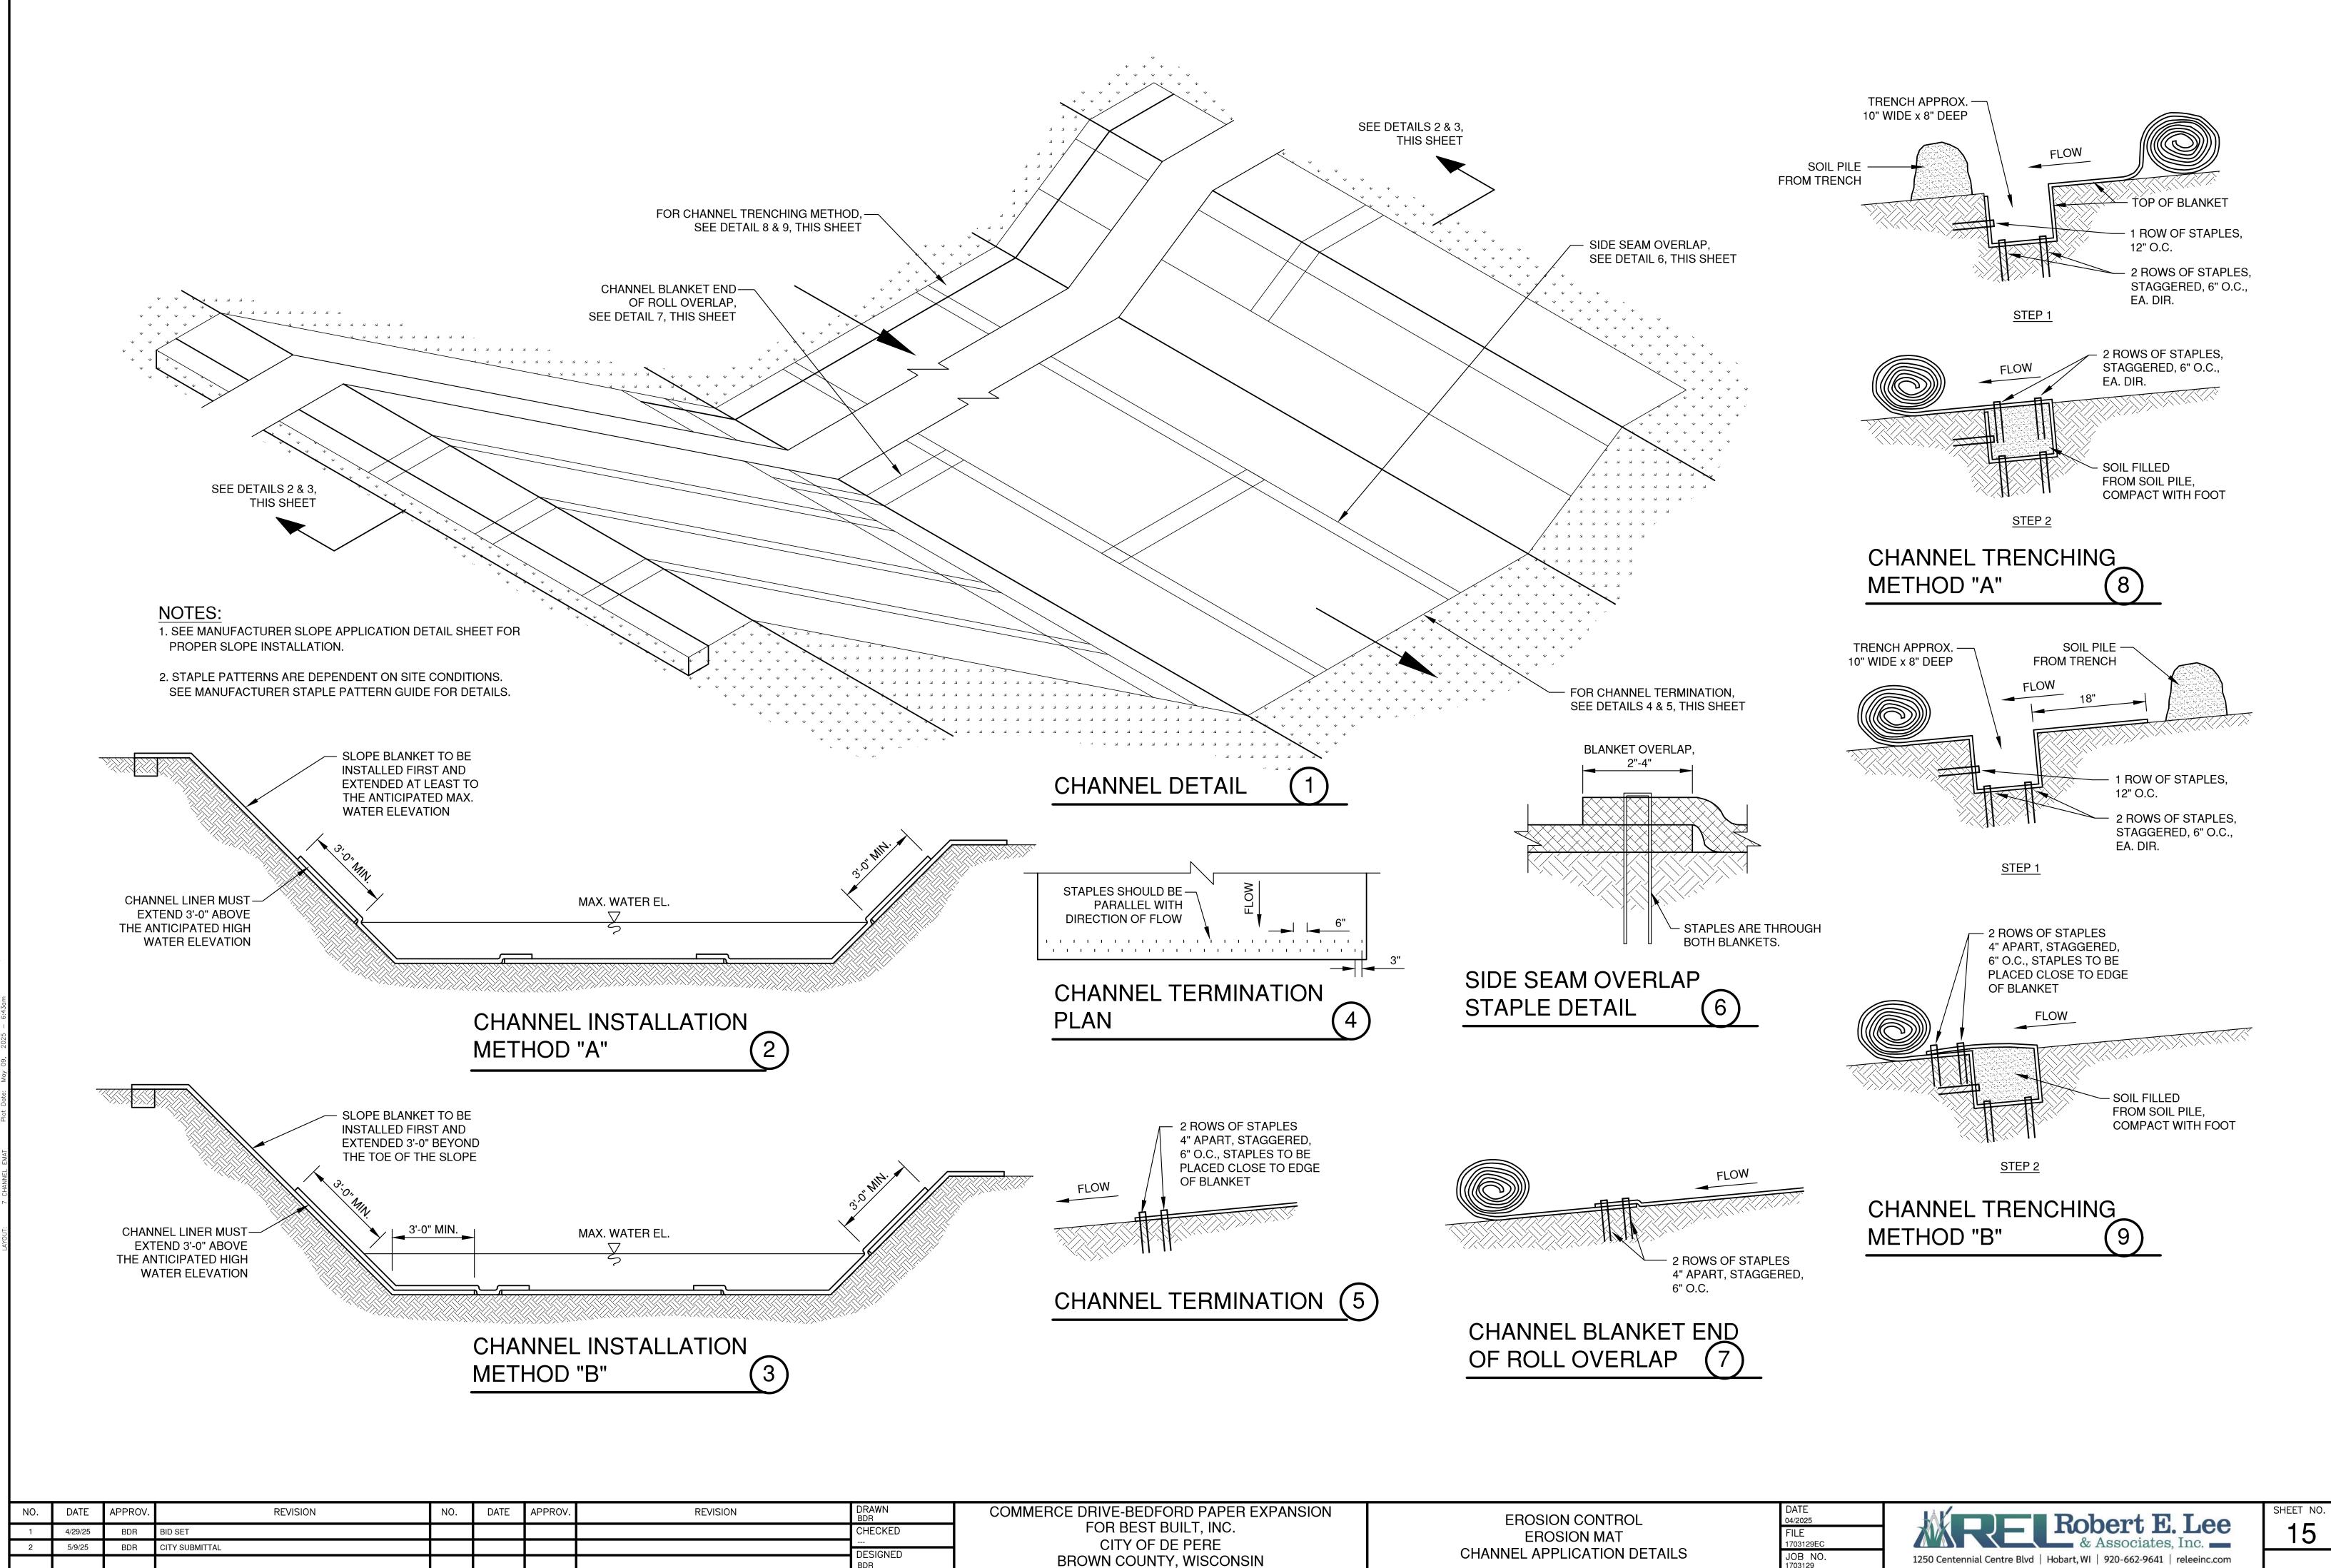

Planting Schedule						
	Qty	Common Name	Botanical Name	Scheduled Size		
Conifers						
	42	Sea Green Juniper	Juniperus x pfitzeriana 'Sea Green'	#5 - 18"		
Perennials						
Shrubs						
۲	10	Goldflame Spirea	Spiraea x bumalda 'Goldflame' (S.x 'Goldflame')	#5 - 18"		
Trees	10			#0 10		
	2	Red Maple, Swamp Maple	Acer rubrum	2" Cal.		
AT		Red Maple, Swamp Maple		2 Gal.		
	1	Skyline Honeylocust	Gleditsia triacanthos inermis 'Skyline'	2" Cal.		
Other						
\bigcirc		Existing Tree		6" Min. Cal.		

Landscape Installation Notes:

GENERAL:

-Landscape Contractor is responsible for coordinating work with general contractor to ensure the landscape scope of work doesn't interfere with existing or built conditions. They should note any discrepancies to the general contractor.

-Landscape Contractor is responsible for verifying the location of underground utilities by calling their local utility marking service.

-All plant material should be inspected by Landscape Contractor prior to installation to determine overall appearance and condition. Plant material that is damaged or has clear signs of stress should be rejected.

-Quantities of material shown on plan take precedence over the specification list or legend.

-If plant substitutions are required, Landscape Contractor is responsible for submitting recommendations to the client or client's representative.

-This proposed landscape plan will mitigate/enhance site conditions in accordance to city requirements.

PLANTING:

-When excavating for plant pits, any excess rock or building material should be removed and replaced with specified soil mix backfill.

-All plant tags should be removed from material by Landscape Contractor.

-All planting beds should receive a minimum 3" deep layer of shredded hardwood mulch, unless otherwise noted.

-Edge all beds with a spade cut edge unless otherwise noted.

-All backfill around plant material should be removed during planting.

-All wire baskets and stakes should be removed during planting.

-Cut and remove top half of burlap around rootballs and cut and remove any twine around trunk or root flare.

-All stakes and guy wires and tree wrap are to be removed no more than 1 year after installation. -Tree wrap, if used, is to be installed by November 1 and to be removed by April 1.

City of De Pere Landscaping Standards:

14-102 Street Right-of-Way Trees:

(2b) Any addition to or enlargement of an existing principal building when the addition or enlargement exceeds 50% of the building's existing floor area (3a) At least one large tree is required per 35 feet of street frontage. 14-106 (3a) Preserved trees up to 6 inches in diameter will be credited . as 3 trees.

836' Street Frontage	/	35	=	24 Trees Required
7 Existing trees	х	3	=	21 Credits
				3 Additional Trees Provided

14-103 Parking Lot Screening:

(2b) The expansion of any existing parking lot that results in the addition of 3,500 square feet of paved area. A vegetative screen consisting of shrubs planted to form a continuous visual barrier at least 3 feet in height.

14-105 Foundation Landscaping:

(2c) Any addition to or enlargement of an existing principal building when the addition or enlargement exceeds 20% of the building's exisiting floor area. (3a) Foundation planting areas must be priorided abutting each principal building along at least 60% of length of any street facing building walls.

105' Planting Required 175' Building Expansion x 60% = 126' Planting Providex

1" = 50'

A 4/10/2025 MVG S Bedford Paper Expansion 1891 Commerce Drive De Pere, WIsconsin 54115 S Project Addres De elevate outdoor Design Firm Elevate Outdoor LLC. 1112 Bryan Road O'Fallon, Missouri 63366 APLD Designer Mark Gawriluk Project Title Bedford Paper Expansion Sheet Title Landscape Plan Project Manage Project ID Scale rawn By MVG 1" = 50' Reviewed By Sheet No. L-1 5/8/2025

of

1

Date

By

No.

Revision Notes

- Customers are responsible for confirming mounting heights, fixture suspension types/ lengths, color temperature, CRI, linear fixture lengths, pole lengths, and bollard heights/ lengths prior to ordering.
- Mounting height (MH) is measured from the bottom of the fixture to the floor.
- This Lighting layout assumes the following unless values are specified and must be confirmed by the customer prior to ordering.
- •• Room reflectance of 80, 50, 20 for standard ceilings and 50, 50, 20 for exposed ceilings
- •• Wall sconces are mounted at 7' for calculation purposes. Customer must confirm desired mounting height before rough in.

Calculation Summary				
Label	СаісТуре	Units	Avg	Max
PROPERTY LINE	Illuminance	Fc	0.07	0.48
SITE	Illuminance	Fc	0.68	11.03

Luminaire Schedule

	louulo				
Qty	Label	Arrangement	LLF	MFR	Description
2	OA2	Single	0.950	LITHONIA	WDGE3 LED P4 xxK 70CRI R2 MVOLT SRM (Finish)
1	OA2-0	Single	0.758	LITHONIA	WDGE3 LED P0 xxK 70CRI R2 MVOLT SRM (Finish)
4	OA3	Single	0.950	LITHONIA	WDGE3 LED P4 xxK 70CRI R3 MVOLT SRM (Finish)
6	OAF	Single	0.950	LITHONIA	WDGE3 LED P4 xxK 70CRI RFT MVOLT SRM (Finish)
1	OAF-0	Single	0.758	LITHONIA	WDGE3 LED P0 xxK 70CRI RFT MVOLT SRM (Finish)

Min		Avg/Min	Max/Min
0.00		N.A.	N.A.
0.00		N.A.	N.A.
	Lum, Watts	Total Watts	Lum. Lumens
	Lum. Watts	Total Watts	Lum. Lumens
	Lum. Watts 87.8914	Total Watts 175.783	Lum. Lumens
	87.8914	175.783	12372
	87.8914 51.1717	175.783 51.172	12372 7651

